

PROJECT NO. 06176.02

NEW WOONSOCKET MIDDLE SCHOOL

WOONSOCKET, RHODE ISLAND

DEPARTMENT OF ENVIRONMENTAL MANAGEMENT
OFFICE OF WATER RESOURCES
FRESHWATER WETLANDS PROGRAM
APPROVED WITH CONDITIONS
AS SPECIFIED IN THE LETTER OF APPROVAL
DATED JUN 3 2008 FILE # _ O8 - O12]
NO CHANGES ALLOWED WITHOUT PRIOR APPROVAL
APPROVED PLANS MUST BE AT CONSTRUCTION SITE

Challe A. House of

ARCHITECT


ARCHITECTURE INVOLUTION, INC. 286 Boston Post Road Wayland, MA 01778
Tel: 508-358-0790
Fax: 508-358-0791

LANDSCAPE ARCHITECT

GATES, LEIGHTON & ASSOCIATES, INC. 865 A Waterman Avenue
East Providence, RI 02914-1300
Tel: 401-438-2071
Fax: 401-434-7511

CIVIL & STRUCTURAL ENGINEER

PARE CORPORATION
10 Lincoln Road, Suite 103
Foxboro, MA 02035
Tel: 508-543-1755
Fax: 508-543-1881

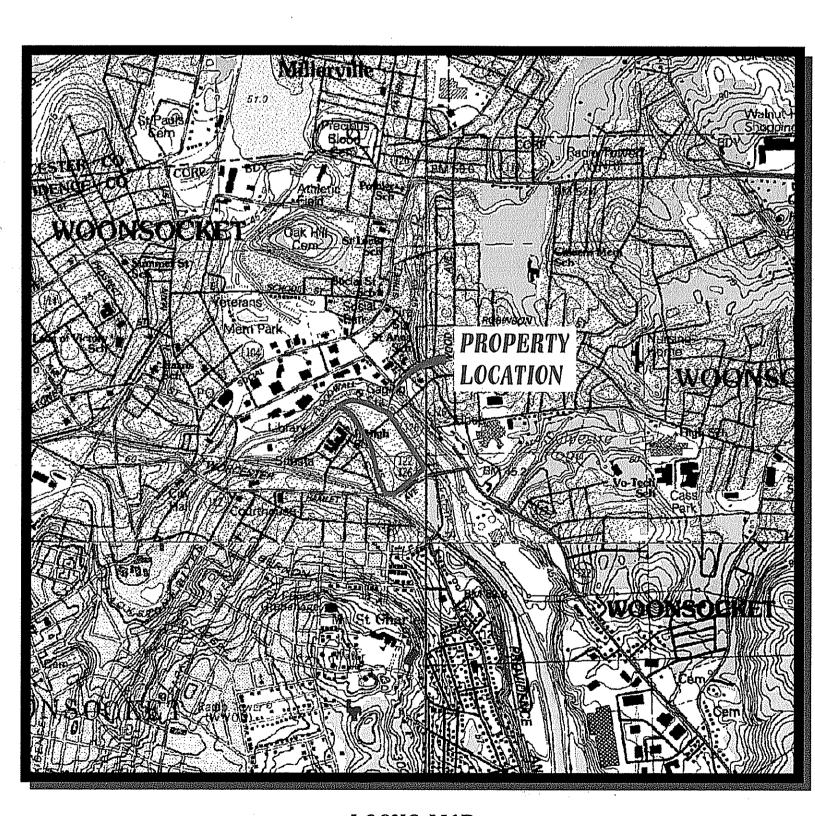

SCALB. 1"=1.500"±

Cover
SITE

C1 General Notes And Legend

C2 Existing Conditions Plan

C3.00 Overall Demolition Plan

C4.00 Overall Site Layout Plan

C5.00 Overall Grading Plan

C6.00 Overall Drainage & Utility Plan

C7.1 Site Details No. 1

C7.2 Site Details No. 2

C7.3 Site Details No. 3

C7.4 Site Details No. 4

C7.5 Site Details No. 5

C7.6 Site Details No. 6

C8.1 Traffic Signal Plan

C8.2 Traffic Signal Interconnect Plan & Details

C8.3 Off-Site Signing and Striping Plan

P-1 Planting Plan 1

P-2 Planting Plan 2

P-3 Hardscape Details

P-4 Landscape Details

APR 2 1 2008

LEGEND

EXISTING		PROPOSED	
255	– CONTOUR —	(262)	(3.4.1) = BRICK / SOLID BLOCK ROUND CATCH BASIN WITH GUTTER INLET - R.I. STD. 3.4.1
× 401.5	SPOT ELEVATION	X4015)	(4.2.0) = PRECAST 4'-O" ROUND MANHOLE - R.I. STD. 4.2.0
	- EASEMENT LINE		(4.4.0M) = PRECAST 4'-0" ROUND CATCH BASIN - R.I. STD. 4.4.0
	- ABUTTERS		(6.2.1) = HEAVY DUTY ROUND FRAME AND COVER - R.I. STD. 6.2.1
	- PROPERTY LINE		(6.3.2) = SQUARE FRAME AND GRATE (BICYCLE SAFE)- R.I. STD. 6.3.2
	BUILDING SETBACK LINE -		
D	- DRAINAGE LINE -		
W	- WATER LINE -	¥	(7.1.2) = 6'-0" PRECAST CONCRETE TRANSITION CURB - R.I. STD. 7.1.2
5	- SANITARY SEWER LINE -		(13.0) = GRANITE CURB - R.I. STD. 7.3.0
6	- GAS LINE (BY OTHERS)		7.3.2) = 6'-0" GRANITE TRANSITION CURB - R.I. STD. 7.3.2
OHW	- OVERHEAD ELECTRIC LINE (BY OTHERS)		(75.1) = BITUMINOUS BERM - R.I. STD. 75.1
CB □ ■	CATCH BASIN	CB	(9.2.0) = SILT FENCE EROSION CHECK - R.I. STD. 9.2.0
	HYDRANT	•	
DMH (D)	DRAINAGE MANHOLE	● DMH	
SMH (S)	SEWER MANHOLE	SMH	(9.4.0) = BALED HAY DITCH AND SWALE EROSION CHECK - R.I. STD. 9.4.0
MMH (Q)	WATER MANHOLE		(9.8.0) = BALED HAY CATCH BASIN INLET PROTECTION - R.I. STD. 9.8.0
	WATER GATE VALVE		(9.9.0) = CONSTRUCTION ACCESS - R.I. STD. 9.9.0
₽0LE # ₽3	GAS GATE VALVE UTILITY POLE		
β <u>GUY</u> ,	UTILITY POLE WGUY WIRE		(24.1.0) = SIGN POST SELECTION AND INSTALLATION DETAILS - R.I. STD. 24.1.0
	= RETAINING WALL =		(43.1.0) = CEMENT CONCRETE SIDEWALK - R.I. STD. 43.1.0 (SEE LANDSCAPE PLANS FOR FIN
	BERM =		
	= CURBING =	And the second s	(43.3.0) = WHEELCHAIR RAMP - R.I. STD. 43.3.0
	- EDGE OF PAVEMENT -		(43.3.1) = WHEELCHAIR RAMP FOR LIMITED RIGHT-OF-WAY AREAS- R.I. STD. 43.3.1
		,,,,,,,,,,,,,,,,,,,,,,,,,,,,,,,,,,,,,,	51.1.0 = TREE PROTECTION DEVICE- R.I. STD. 51.1.0
			20.1.0 = PAVEMENT MARKINGS ARROWS AND ONLY - R.I. STD. 20.1.0
RIR	$\frac{1}{2}$ TREE LINE (LOD) $\frac{2}{2}$ EDGE OF RIVER		ACP = 1-1/2" BITUMINOUS CONCRETE SURFACE COURSE TYPE 1-2 OVER
	= 200' RIVERBANK		I-I/2" BITUMINOUS CONCRETE SURFACE COURSE TYPE I-I OVER 6" SAND GRAVEL FILL AGGREGATE BASE COURSE
	BUILDING		8" GRANULAR FILL AGGREGATE SUBBASE COURSE ASPHALT EMULSION TACK COAT IS TO BE APPLIED BETWEEN BITUMINOUS LAYERS
	PAVEMENT		(ATG) = ADJUST TO GRADE
	CONCRETE WALK		(BCP) = I-I/2" BITUMINOUS CONCRETE SURFACE COURSE TYPE I-I OVER
			1-1/2" BITUMINOUS CONCRETE BINDER COURSE OVER
			6" SAND GRAVEL FILL AGGREGATE BASE COURSE 8" GRANULAR FILL AGGREGATE SUBBASE COURSE
	BALED HAY WITH SILT FENCE (LIMIT OF DISTURBANCE)	<u> </u>	ASPHALT EMULSION TACK COAT IS TO BE APPLIED BETWEEN BITUMINOUS LAYERS
	LIMIT OF DISTURBANCE -	LOD	BCP2) = 2" BITUMINOUS SURFACE COURSE TYPE I-I 5" BITUMINOUS BASE COURSE (PLACED IN 2.5" LAYERS)
	SILT FENCE -	× × × × × ×	12" GRAVEL BORROW SUBBASE ASPHALT EMULSION TACK COAT IS TO BE APPLIED
	MONITORING WELL		BETWEEN BITUMINOUS LAYERS
B-08-#	BORING		CB = PRECAST CATCH BASIN WITH OIL/WATER SEPARATOR
			(CM) = SAWCUT AND MATCH EXISTING GRADES
[XXX FT]	BOTTOM OF ON-SITE FILL		DI = DUCTILE IRON PIPE
·	FINISHED FLOOR ELEVATION	FFE: XXX.XX	DMH = PRECAST DRAIN MANHOLE
	CLEAN OUT	<i>c.o.</i>	(DGCB) = DOUBLE GRATE CATCH BASIN
	 APPROXIMATE AREAS OF EXCAVATED MATERIAL 		
	(SEE NOTES)		
			(DY4) = 4" DOUBLE YELLOW EPOXY RESIN PAVEMENT MARKING
			HDPE = HIGH DENSITY POLYETHYLENE
			LA = LANDSCAPED AREA SEE LANDSCAPING PLANS
			GV = GATE VALVE
			(R\$D) = REMOVE AND DISPOSE

TE SIDEWALK - R.I. STD. 43.I.O (SEE LANDSCAPE PLANS FOR FINISHES)

(R&R) = REMOVE AND RESET

(SCW) = STRIPED CROSS WALK (SEE DETAIL)

(SHP) = HANDICAP EPOXY RESIN PAVEMENT MARKING

= PRECAST SEWER MANHOLE

(SW) = 4" SOLID WHITE EPOXY RESIN PAVEMENT MARKING

= 6" SOLID WHITE EPOXY RESIN PAVEMENT MARKING (SW6)

(SWI2) = 12" SOLID WHITE EPOXY RESIN PAVEMENT MARKING

(TCB) = TRANSITION (CURB TO BERM) - R.I. STD. 7.1.2

DEMOLITION NOTES

- UNDERGROUND UTILITIES WERE COMPILED FROM AVAILABLE RECORD PLANS OF UTILITY COMPANIES AND PUBLIC AGENCIES AND ARE APPROXIMATE AND ASSUMED. BEFORE COMMENCING SITE WORK IN ANY AREA, CONTACT "DIG SAFE" AT I-888-DIG-SAFE TO ACCURATELY LOCATE UNDERGROUND UTILITIES. ANY DAMAGE TO EXISTING UTILITIES OR STRUCTURES AS SHOWN ON THE PLANS SHALL BE THE CONTRACTOR'S RESPONSIBILITY. COSTS OF SUCH DAMAGE SHALL BE THE CONTRACTOR'S RESPONSIBILITY. NO EXCAVATION SHALL BE DONE UNTIL UTILITY COMPANIES ARE PROPERLY NOTIFIED.
- THE CONTRACTOR SHALL COORDINATE ALL DEMOLITION OF STRUCTURES, PAVEMENT AND CONCRETE MATERIALS, AND UTILITIES WITH APPROPRIATE PROPOSED SITE GENERAL, UTILITY, LANDSCAPING, AND ARCHITECTURAL DRAWINGS.
- 3. ALL NOTED UTILITIES TO BE REMOVED AND DISPOSED OF, RELOCATED OR CAPPED REPRESENT ALL KNOWN SITE CONDITIONS TO BE DEMOLISHED. CONTRACTOR TO COORDINATE ALL UNFORESEEN CONDITIONS WITH THE PROJECT ENGINEER, ARCHITECT, OWNERS REPRESENTATIVE, AND/OR RESPECTIVE UTILITY COMPANIES PRIOR TO PROCEEDING WITH WORK.
- 4. ALL UNDERGROUND VAULTS NEED TO BE CLOSED IN ACCORDANCE TO STATE REGULATIONS.
- 5. FOR DIRECTION ON EXISTING MONITORING WELLS SEE "REMEDIAL ACTION PLANS".
- 6. WHERE DRAIN OR SEWER LINES ARE REMOVED AND DISPOSED, FROM A STRUCTURE TO REMAIN, THE CONTRACTOR SHALL BRICK AND MORTAR THE RESULTING HOLE.
- 7. ALL EXISTING VEGETATION WITHIN THE LIMITS OF DISTURBANCE IS TO BE REMOVED UNLESS OTHERWISE NOTED.
- 8. THE CONTRACTOR SHALL REMOVE WATER, SEWER AND DRAIN LINES ASSOCIATED WITH STRUCTURES TO BE REMOVED. THE LINE SHALL BE PROPERLY CAPPED WHEN THEY ARE NOT REMOVED IN THEIR ENTIRETY.

REFERENCE

- EXISTING CONDITION AND PROPERTY LINE INFORMATION TAKEN FROM PLAN ENTITLED, "EXISTING CONDITIONS" FOR CITY OF WOONSOCKET, MIDDLE SCHOOL SITE, PREPARED BY NATIONAL SURVEYORS-DEVELOPERS INC. DATED AUGUST 2007. THIS SURVEY AND PLAN CONFORM TO A CLASS I STANDARD AS ADOPTED BY THE RHODE ISLAND BOARD OF REGISTRATION FOR PROFESSIONAL LAND SURVEYORS. VERTICAL DATUM IS NVGD 29.
- 2. "SITE PLAN WITH EXCAVATION LIMITS AND REMEDIATION STAGING AREAS" FOR CITY OF WOONSOCKET, PROPOSED MUNICIPAL MIDDLE SCHOOL SITE, PREPARED BY FUSS & O'NEILL,
- 3. THE FOLLOWING DOCUMENTS ARE REFERENCED FOR ON-SITE SOIL REMEDIATION (HEREINAFTER WITHIN THESE PLANS REFERRED TO "REMEDIAL ACTION PLANS":
 - ? THE DOCUMENT ENTITLED, "CONSTRUCTION SOIL MANAGEMENT PLAN" PREPARED BY FUSS # O'NEILL, DATED MARCH 18, 2008. ? THE DOCUMENT ENTITLED, "REMEDIAL ACTION WORK PLAN" PREPARED BY FUSS \$ O'NEILL, DATED APRIL 1, 2008. ? THE PLANS ENTITLED, "CITY OF WOONSOCKET, WOONSOCKET MIDDLE SCHOOL, REMEDIAL ACTION PLANS" PREPARED BY FUSS & O'NEILL, DATED APRIL 1, 2008.

GENERAL NOTES

- THE STATE OF RHODE ISLAND STANDARD SPECIFICATIONS FOR ROAD AND BRIDGE CONSTRUCTION, 1997 EDITION, AND THE RHODE ISLAND STANDARD DETAILS ARE MADE A PART HEREOF AS FULLY AND COMPLETELY AS IF ATTACHED HERETO. THE 1997 EDITION OF THE STANDARD SPECIFICATIONS MAY BE OBTAINED AT THE RHODE ISLAND DEPARTMENT OF
- THE CONTRACTOR SHALL MAKE ALL NECESSARY CONSTRUCTION NOTIFICATIONS AND APPLY FOR AND OBTAIN ALL NECESSARY CONSTRUCTION PERMITS, PAY ALL FEES AND POST ALL BONDS ASSOCIATED WITH THE SAME, AND COORDINATE WITH THE ENGINEER AND ARCHITECT AS REQUIRED.
- IF ANY DEVIATION OR ALTERATION OF THE WORK PROPOSED ON THESE DRAWINGS IS REQUIRED, THE CONTRACTOR IS TO IMMEDIATELY CONTACT AND COORDINATE WITH THE ENGINEER AND
- ANY AREA OUTSIDE OF THE LIMIT OF WORK THAT IS DISTURBED SHALL BE RESTORED TO ITS ORIGINAL CONDITION AT NO COST TO THE OWNER.
- 5. ALL SITE WORK SHALL MEET OR EXCEED THE SITE WORK SPECIFICATIONS PREPARED FOR THIS PROJECT. THE CONTRACTOR SHALL BE RESPONSIBLE FOR VERIFYING THAT THE PROPOSED IMPROVEMENTS SHOWN ON THE PLANS DO NOT CONFLICT WITH ANY KNOWN EXISTING OR OTHER PROPOSED IMPROVEMENTS. IF ANY CONFLICTS ARE DISCOVERED, THE CONTRACTOR SHALL NOTIFY THE OWNER AND THE ENGINEER PRIOR TO INSTALLATION OF ANY PORTION OF THE SITE WORK WHICH WOULD BE AFFECTED.
- 6. ALL UTILITIES (LOCATION AND ELEVATION) SHOWN SHALL BE CONSIDERED APPROXIMATE ONLY. BEFORE COMMENCING SITE WORK IN ANY AREA, CONTACT "DIG SAFE" AT I-888-344-7233. TO ACCURATELY LOCATE UNDERGROUND UTILITIES. ANY DAMAGE TO EXISTING UTILITIES OR STRUCTURES AS SHOWN ON THE PLANS SHALL BE THE CONTRACTOR'S RESPONSIBILITY. COSTS OF SUCH DAMAGE SHALL BE THE CONTRACTOR'S RESPONSIBILITY. NO EXCAVATION SHALL BE DONE UNTIL COMPANIES ARE PROPERLY NOTIFIED IN ADVANCE. NOTE THAT NOT ALL EXISTING UNDERGROUND UTILITIES ARE SHOWN. IT IS THE CONTRACTORS RESPONSIBILITY TO CONTACT ALL RESPECTIVE UTILITY COMPANIES TO VERIFY AND LOCATE EXISTING UTILITIES.
- ALL WORK SHALL CONFORM TO THE CITY OF WOONSOCKET DPW REQUIREMENTS AND RHODE ISLAND STANDARD SPECIFICATIONS FOR ROAD AND BRIDGE CONSTRUCTION 1997 EDITION OR LATEST REVISION.
- 6. PAVEMENT MARKINGS: CROSSWALKS SHALL MEET ALL CITY OF WOONSOCKET REQUIREMENTS. ALL PAVEMENT MARKINGS ARE TO BE EPOXY RESIN.
- APPROXIMATE LIMITS OF CONCRETE FLOOR PADS WERE DETERMINED BY HISTORICAL INFORMATION (RIGIS AERIAL PHOTOS 1939, 1952, 1962, AND 2004)
- IO. UNDERGROUND STORAGE TANK CLOSURES AND SOIL REMEDIATION HAS BEEN DESIGNED BY FUSS AND O'NEILL. SOME OF THE WORK WILL BE COMPLETED PRIOR TO THE START OF CONSTRUCTION. FOR LOCATIONS AND QUANTITIES OF EXISTING HOLES AND STOCKPILED REMEDIATED SOIL REFER TO THE "REMEDIAL ACTION PLANS".
- II. ALL HANDLING OF ONSITE SOIL SHALL COMPLY WITH LOCAL AND STATE REGULATIONS AS WELL AS THE "REMEDIAL ACTION PLANS".
- 12. SEE DEMOLITION PLAN FOR AREAS OF EXISTING CONCRETE PADS TO BE CRUSHED AND REUSED
- 13. ALL AREAS OF DISTURBANCE SHALL BE CAPPED AS OUTLINED WITH SITE DETAILS AND THE "REMEDIAL ACTION PLANS"
- 14. FOR MINIMUM SITE CAPPING REQUIREMENTS SEE THE "REMEDIAL ACTION PLANS".
- 15. NO CRUSHED OR PROCESSED BUILDING DEMOLITION MATERIAL SHALL BE USED WITHIN TWO FEET VERTICALLY OF THE PROPOSED FINISHED GRADES WITHIN AREAS OF LANDSCAPING AND LOAM.
- 16. SOLIDIFIED/STABILIZED SOIL CONTAINING PETROLEUM SHALL BE USED UNDER PAVEMENT AND NOT WITHIN LANDSCAPED AREAS. SEE REMEDIAL ACTION PLANS.
- 17. REFER TO GILBANE BID PACKAGE SCOPE OF WORK BY GILBANE BUILDING COMPANY FOR ADDITIONAL INFORMATION REGARDING: PHASING, BUILDING DEMOLITION AND SITE CONDITIONS.
- 18. REFER TO MECHANICAL AND ELECTRICAL PLANS FOR SITE ISSUES RELATED TO THESE DISCIPLINES.

LAYOUT NOTES

- ALL LINES ARE PERPENDICULAR OR PARALLEL TO THE LINES FROM WHICH THEY ARE MEASURED UNLESS OTHERWISE INDICATED.
- 2. EACH HANDICAP PARKING SPACE SHALL BE IDENTIFIED BY A SIGN LOCATED AT THE BACK OF THE WALKWAY. THE SIGN SHALL CONTAIN THE "INTERNATIONAL SYMBOL OF ACCESSIBILITY" AS DESCRIBED IN THE AMERICANS WITH DISABILITIES ACT, PUBLIC LAW 101-336. (SEE DETAIL)
- DIMENSIONS OF PARKING SPACES AND DRIVEWAYS ARE FROM FACE OF CURB TO FACE OF CURB. DIMENSIONS FROM BUILDING ARE FROM FACE OF BUILDING TO FACE OF CURB.
- 4. ACCESSIBLE RAMPS SHALL BE PER THE AMERICANS WITH DISABILITIES ACT (ADA) ACCESSIBILITY
- 5. CENTER WALKWAYS ON DOORWAYS THEY SERVE.

STORMWATER MANAGEMENT SYSTEM INSPECTION AND MAINTENANCE NOTES

DURING CONSTRUCTION THE CONTRACTOR SHALL REMOVE SEDIMENT AND DEBRIS FROM ALL CATCH BASINS AND MANHOLES ON A ROUTINE BASIS, IMMEDIATELY FOLLOWING SITE STABILIZATION AND PRIOR TO PROJECT COMPLETION AND ACCEPTANCE.

POST CONSTRUCTION THE PARKING LOT SHALL BE SWEPT BY THE OWNER AS EARLY AS POSSIBLE EVERY SPRING TO

- REMOVE SALTS AND SAND DEPOSITED DURING THE WINTER.
- 2. ALL CLEANING AND MAINTENANCE OF DRAINAGE SYSTEM BMP'S SHALL BE THE RESPONSIBILITY OF THE PROPERTY OWNER. INSPECTION SHALL BE CONDUCTED MONTHLY FOR THE FIRST SIX MONTHS AFTER INSTALLATION,

AND TWO TIMES PER YEAR THEREAFTER, SYSTEM COMPONENTS TO BE INSPECTED SHALL INCLUDE

OF SEDIMENT, AND CONDITION OR RIPRAP. ANY DEFICIENCIES IDENTIFIED SHALL BE IMMEDIATELY

- ALL CATCH BASINS, THE VORTECHS STORM WATER TREATMENT SYSTEM, AND SYSTEM OUTFALLS. THE CATCH BASINS SHALL BE CLEANED WHEN SEDIMENT AND/OR DEBRIS LEVELS EQUAL 1/2 OF THE ORIGINAL SUMP DEPTH. REMOVED SEDIMENT AND DEBRIS SHALL BE DISPOSED OF OFFSITE AT AN APPROVED FACILITY. SYSTEM OUTFALLS SHALL BE CHECKED FOR EROSION, DISCHARGE
- THE VORTECHS STORM WATER TREATMENT SYSTEM SHALL BE INSPECTED AND MAINTAINED BY OWNER IN ACCORDANCE WITH THE MANUFACTURES INSTRUCTIONS, WHICH SHALL BE SUPPLIED AT NSTALLATION. THE SYSTEM SHALL BE INSPECTED QUARTERLY FOR ACCUMULATED SEDIMENT, AND MONTHLY DURING THE WINTER. THE SYSTEM SHALL BE CLEANED WHEN THE SEDIMENT DEPTH IS WITHIN 6 INCHES OF THE DRY WEATHER WATER LEVEL IN THE UNIT. A VACUUM TRUCK SHALL BE USED TO CLEAN THE UNIT.

SIDEWALK NOTES

CORRECTED.

- SIDEWALK SHALL BE CONSTRUCTED WITH WELDED WIRE FABRIC 6x6 W2.9xW2.9 CONFORMING TO STANDARD SPECIFICATIONS SECTION 905.02.3.
- 2. SEE LANDSCAPE PLANS FOR ALL FINISHES.
- THE PROPOSED WALKWAYS SHALL HAVE A MAXIMUM CROSS SLOPE OF 2% AND RUNNING SLOPE OF 5% AS SHOWN ON CONSTRUCTION DETAILS AND GRADING PLAN.

EROSION AND SEDIMENTATION CONTROL NOTES

- SOIL EROSION AND SEDIMENTATION CONTROLS SHALL BE PROVIDED IN ACCORDANCE WITH THE "RHODE ISLAND SOIL EROSION AND SEDIMENT CONTROL HANDBOOK" THE RIPEDES GENERAL PERMIT FOR STORM WATER DISCHARGE FROM CONSTRUCTION ACTIVITY (SEPT. 2003) AND THE PROJECT-SPECIFIC STORM WATER POLLUTION PREVENTION PLAN.
- 2. THE CONTRACTOR SHALL BECOME FAMILIAR WITH THE CONDITIONS ISSUED FOR THE PROJECT BY RIDEM AND BE RESPONSIBLE FOR CONFORMANCE WITH ALL CONSTRUCTION DOCUMENTS.
- 3. THE CONTRACTOR SHALL BE RESPONSIBLE FOR ESTABLISHING OR INSTALLING ALL TEMPORARY SEDIMENT AND EROSION CONTROLS AS SHOWN ON THESE PLANS AND SHALL MAINTAIN ALL EROSION CONTROL MEASURES AS NECESSARY DURING THE ENTIRE CONSTRUCTION PERIOD.
- 4. TEMPORARY DIVERSION SWALES SHALL BE PROVIDED AS NECESSARY TO DIRECT RUNOFF AROUND DISTURBED AREAS.
- 5. ANTI-TRACKING PADS (R.I. STD. DETAIL 9.9.0) SHALL BE PROVIDED AT ALL POINTS OF EGRESS OR INGRESS AND SHALL BE MAINTAINED TO LIMIT TRACKING OR FLOWING OF SEDIMENT ONTO
- EROSION CONTROL BARRIERS SHALL BE INSTALLED AS SHOWN ON THE EROSION CONTROL PLAN PRIOR TO COMMENCEMENT OF CONSTRUCTION OPERATIONS.
- 7. SOIL EROSION AND SEDIMENTATION CONTROL MEASURES SHALL BE INSPECTED AND MAINTAINED AS OUTLINED IN THE PROJECT SPECIFIC STORMWATER POLLUTION PREVENTION PLAN (SWPPP). IDENTIFIED DEFICIENCIES SHALL BE CORRECTED IMMEDIATELY.
- 8. DUST SHALL BE CONTROLLED BY WATERING OR OTHER APPROVED METHODS AS NECESSARY, OR AS DIRECTED BY THE OWNER OR OWNER'S REPRESENTATIVE.
- 9. THE CONTRACTOR SHALL CLEAN AND MAINTAIN EROSION CONTROL BARRIER WHEN SEDIMENT ACCUMULATES TO ONE HALF THE HEIGHT OF THE HAYBALES OR ONE THIRD THE HEIGHT OF SILT FENCE. MATERIAL COLLECTED FROM THE SILTATION BARRIERS SHALL BE REMOVED AS NECESSARY AND DISPOSED IN AN UPLAND AREA.
- IO. THE CONTRACTOR SHALL SCHEDULE HIS WORK TO ALLOW THE FINISHED SUB GRADE ELEVATIONS TO DRAIN PROPERLY WITHOUT PONDING. SPECIFICALLY, ALLOW WATER TO ESCAPE WHERE PROPOSED CURB MAY RETAIN RUNOFF PRIOR TO APPLICATION OF SURFACE PAVING. PROVIDE TEMPORARY POSITIVE DRAINAGE, AS REQUIRED, TO STABILIZED DISCHARGE POINTS.
- INSTALLATION OF THE EROSION CONTROL BARRIERS AS ILLUSTRATED IS INTENDED TO REPRESENT THE MINIMUM SEDIMENTATION CONTROL FACILITIES NECESSARY TO MEET ANTICIPATED SITE CONDITIONS. ADDITIONAL EROSION CONTROL MEASURES SHALL BE IMPLEMENTED AS CONDITIONS WARRANT OR AS DIRECTED BY THE OWNER OR OWNER'S REPRESENTATIVE.
- 12. REQUIRED SEDIMENTATION CONTROL FACILITIES MUST BE PROPERLY ESTABLISHED, CLEARLY VISIBLE AND IN OPERATION PRIOR TO INITIATING ANY LAND CLEARING ACTIVITY AND/OR OTHER CONSTRUCTION RELATED WORK. SUCH FACILITIES SHALL REPRESENT THE LIMIT OF WORK. WORKERS SHALL BE INFORMED THAT NO CONSTRUCTION ACTIVITY IS TO OCCUR BEYOND THE LIMIT OF WORK AT ANY TIME THROUGHOUT THE CONSTRUCTION PERIOD.
- 13. THE CONTRACTOR SHALL MAINTAIN A SUFFICIENT RESERVE OF VARIOUS EROSION CONTROL MATERIALS ONSITE AT ALL TIMES FOR EMERGENCY PURPOSES OR ROUTINE MAINTENANCE.
- 14. CATCH BASINS AND STORM DRAIN INLETS SHALL BE PROTECTED WITH HAY BALES (RIDOT R.I.STD. DETAIL 7.8.0) OR SEDIMENT BAGS IN PAVED AREAS.
- 15. THE CONTRACTOR SHALL NOT REMOVE ANY HAY BALES, SILT FENCE OR OTHER EROSION
- CONTROLS UNTIL THE CONTRIBUTING DRAINAGE AREA HAS BEEN PERMANENTLY STABILIZED. 16. CONSTRUCTION SITE WASTE MATERIALS WILL BE PROPERLY CONTAINED ONSITE AND DISPOSED
- OFF SITE AT A LOCATION IN ACCORDANCE WITH THE LOCAL AND STATE REGULATIONS. 17. RIP-RAP OR OTHER ENERGY DISSIPATERS WILL BE USED WHERE NECESSARY TO PREVENT SCOUR.
- 18. ALL DISTURBED AREAS SHALL BE STABILIZED WITHIN 14 DAYS UPON COMPLETION OF WORK IN

20. WHERE EROSION CONTROL IS CALLED FOR IN AREAS OF PAVEMENT, SAND BAGS WILL BE USED IN

19. ALL DRAINAGE STRUCTURES SHALL BE CLEARED OF ACCUMULATED SEDIMENT PRIOR TO ACCEPTANCE OF FINAL PROJECT.

GRADING AND UTILITY NOTES

PLACE OF HAYBALES AND SILT FENCE.

- I. UNDERGROUND UTILITIES WERE COMPILED FROM AVAILABLE RECORD PLANS OF UTILITY COMPANIES AND PUBLIC AGENCIES AND ARE APPROXIMATE AND ASSUMED. BEFORE COMMENCING SITE WORK IN ANY AREA, CONTACT "DIG SAFE" AT I-888-DIG-SAFE TO ACCURATELY LOCATE UNDERGROUND UTILITIES, ANY DAMAGE TO EXISTING UTILITIES OR STRUCTURES AS SHOWN ON THE PLANS SHALL BE THE CONTRACTOR'S RESPONSIBILITY. COSTS OF SUCH DAMAGE SHALL BE THE CONTRACTOR'S RESPONSIBILITY. NO EXCAVATION SHALL BE DONE UNTIL UTILITY COMPANIES ARE PROPERLY NOTIFIED.
- 2. THE CONTRACTOR SHALL BE RESPONSIBLE FOR VERIFYING THAT THE PROPOSED IMPROVEMENTS SHOWN ON THE PLANS DO NOT CONFLICT WITH ANY KNOWN EXISTING OR OTHER PROPOSED IMPROVEMENTS. IF CONFLICTS ARE DISCOVERED, THE CONTRACTOR SHALL NOTIFY THE OWNER AND THE ENGINEER PRIOR TO INSTALLATION OF ANY PORTION OF THE SITE WORK WHICH WOULD BE AFFECTED. NO FIELD ADJUSTMENTS IN THE LOCATION OF SITE ELEMENTS SHALL BE MADE WITHOUT THE ENGINEERS APPROVAL.
- 3. ALL WORK PERFORMED AND ALL MATERIALS FURNISHED SHALL CONFORM WITH THE LINES AND
- SRADES ON THE PLANS AND SITE WORK SPECIFICATIONS. 4. AT ALL LOCATIONS WHERE EXISTING CURBING OR PAVEMENT ABUT NEW CONSTRUCTION, THE EDGE OF THE EXISTING CURB OR PAVEMENT SHALL BE SAW CUT TO A CLEAN, SMOOTH EDGE. BLEND
- NEW PAVEMENT AND CURBS SMOOTHLY INTO EXISTING BY MATCHING LINES, GRADES AND JOINTS. 5. ALL UTILITY COVERS, GRATES, ETC. SHALL BE ADJUSTED TO BE FLUSH WITH THE SURROUNDING SURFACE OR PAVEMENT FINISH GRADE. RIM ELEVATIONS OF STRUCTURES AND MANHOLES ARE APPROXIMATE. FINAL ELEVATIONS ARE TO BE SET FLUSH AND CONSISTENT WITH THE GRADING
- 6. FINAL CONCRETE MECHANICAL EQUIPMENT PAD SIZES, LOCATIONS AND DETAILING TO BE COORDINATED WITH EQUIPMENT SUPPLIER AND PROJECT ENGINEER. INSTALL ALL UTILITIES (INCLUDING CONCRETE PADS) PER UTILITY COMPANY STANDARDS.
- 7. THE CONTRACTOR SHALL MAKE ALL ARRANGEMENTS FOR THE ALTERATION OF PRIVATE UTILITIES BY THE UTILITY COMPANIES, AS REQUIRED.
- 8. WHERE AN EXISTING UTILITY IS FOUND TO CONFLICT WITH THE PROPOSED WORK, THE LOCATION, ELEVATION AND SIZE OF THE UTILITY SHALL BE ACCURATELY DETERMINED WITHOUT DELAY BY THE CONTRACTOR AND THE INFORMATION FURNISHED TO THE ENGINEER FOR RESOLUTION.
- 9. THE CONTRACTOR SHALL PROTECT ALL UNDERGROUND DRAINAGE, SEMER AND UTILITY FACILITIES FROM EXCESSIVE VEHICULAR LOADS DURING CONSTRUCTION. ANY DAMAGE TO THESE FACILITIES RESULTING FROM CONSTRUCTION LOADS WILL BE RESTORED TO ORIGINAL CONDITION. IO. GAS, ELECTRIC, AND COMMUNICATIONS ROUTING ARE SUBJECT TO REVIEW AND APPROVAL BY
- APPROPRIATE UTILITY COMPANIES. DURING CONSTRUCTION OPERATIONS, THE CONTRACTOR SHALL PROTECT EXISTING UTILITIES BY PROVIDING TEMPORARY SUPPORTS OR SHEETING AS REQUIRED AT NO ADDITIONAL COST TO THE
- 12. ALL GRAVITY SANITARY PIPING SHALL BE SDR-35 PVC AND CONFORM TO THE CITY OF
- WOONSOCKET REQUIREMENTS. 13. ALL WATER LINE BENDS SHALL BE REINFORCED WITH THRUST BLOCKS.

WOONSOCKET PRIOR TO ANY DISTURBANCE IN SERVICE.

COMMISSION PRIOR TO COMMENCING WORK.

GRADE.

- 14. EXCAVATION REQUIRED WITHIN THE PROXIMITY OF EXISTING UTILITY LINES SHALL BE PERFORMED BY HAND. CONTRACTOR SHALL REPAIR ANY DAMAGE TO EXISTING UTILITY LINES OR STRUCTURES INCURRED DURING CONSTRUCTION OPERATIONS AT NO COST TO THE OWNER.
- 15. PITCH EVENLY BETWEEN SPOT GRADES. ALL PAVED AREAS MUST PITCH TO DRAIN AT A MIN. OF 1/8" PER FOOT UNLESS SPECIFIED. 16. ANY UTILITY INTERRUPTION SHALL BE COORDINATED AND APPROVED BY THE CITY OF APR 2 1 2008
- 17. ALL WATER MAIN INSTALLATION SHALL CONFORM TO THE CITY OF WOONSOCKET REQUIREMENTS. 18 CONTRACTOR IS RESPONSIBLE FOR SCHEDULING A PRE-CONSTRUCTION MEETING WITH THE WATER
- 19. ALL SEWER CONSTRUCTION SHALL CONFORM TO THE CITY OF WOONSOCKET REQUIREMENTS. 20. ANY EXISTING UTILITY RIMS ASSOCIATED WITH UTILITIES TO REMAIN SHALL BE ADJUSTED TO

ARCHITECTURE INVOLUTION, 1 286 BOSTON POST ROAD 508-358-0790 (WAYLAND, MA 01778 508-358-0791 (F Al3@Al-3.COM




NEW **WOONSOCKET** Woonsocket, Ri

HAMLET AVENUE. FLORENCE DRIVE & VILLA NOVA STREET

ASSESSOR'S PLAT 27 LOTS 13, 24, 26, 62, 63, 77, 78, 81, 91, 165, & 170


DEPARTMENT OF ENVIRONMENTAL MANAGEMENT OFFICE OF WATER RESOURCES FRESHWATER WETLANDS PROGRAM APPROVED WITH CONDITIONS
AS SPECIFIED IN 3 2005 LETTER OF APPROVAL NO CHANGES ALLOWED WITHOUT PRIOR APPROVAL APPROVED PLANS MUST BE AT CONSTRUCTION SITE

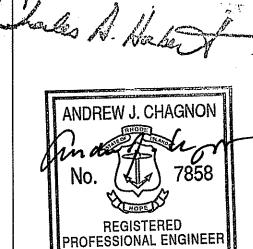

RIDEM SUBMISSION

(CIVIL)



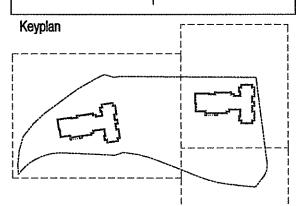



L________

GENERAL NOTES AND LEGEND

As Noted | Drawing Number: Job No. 070100/061760


APRIL, 2008 | Sheet 2 of 13

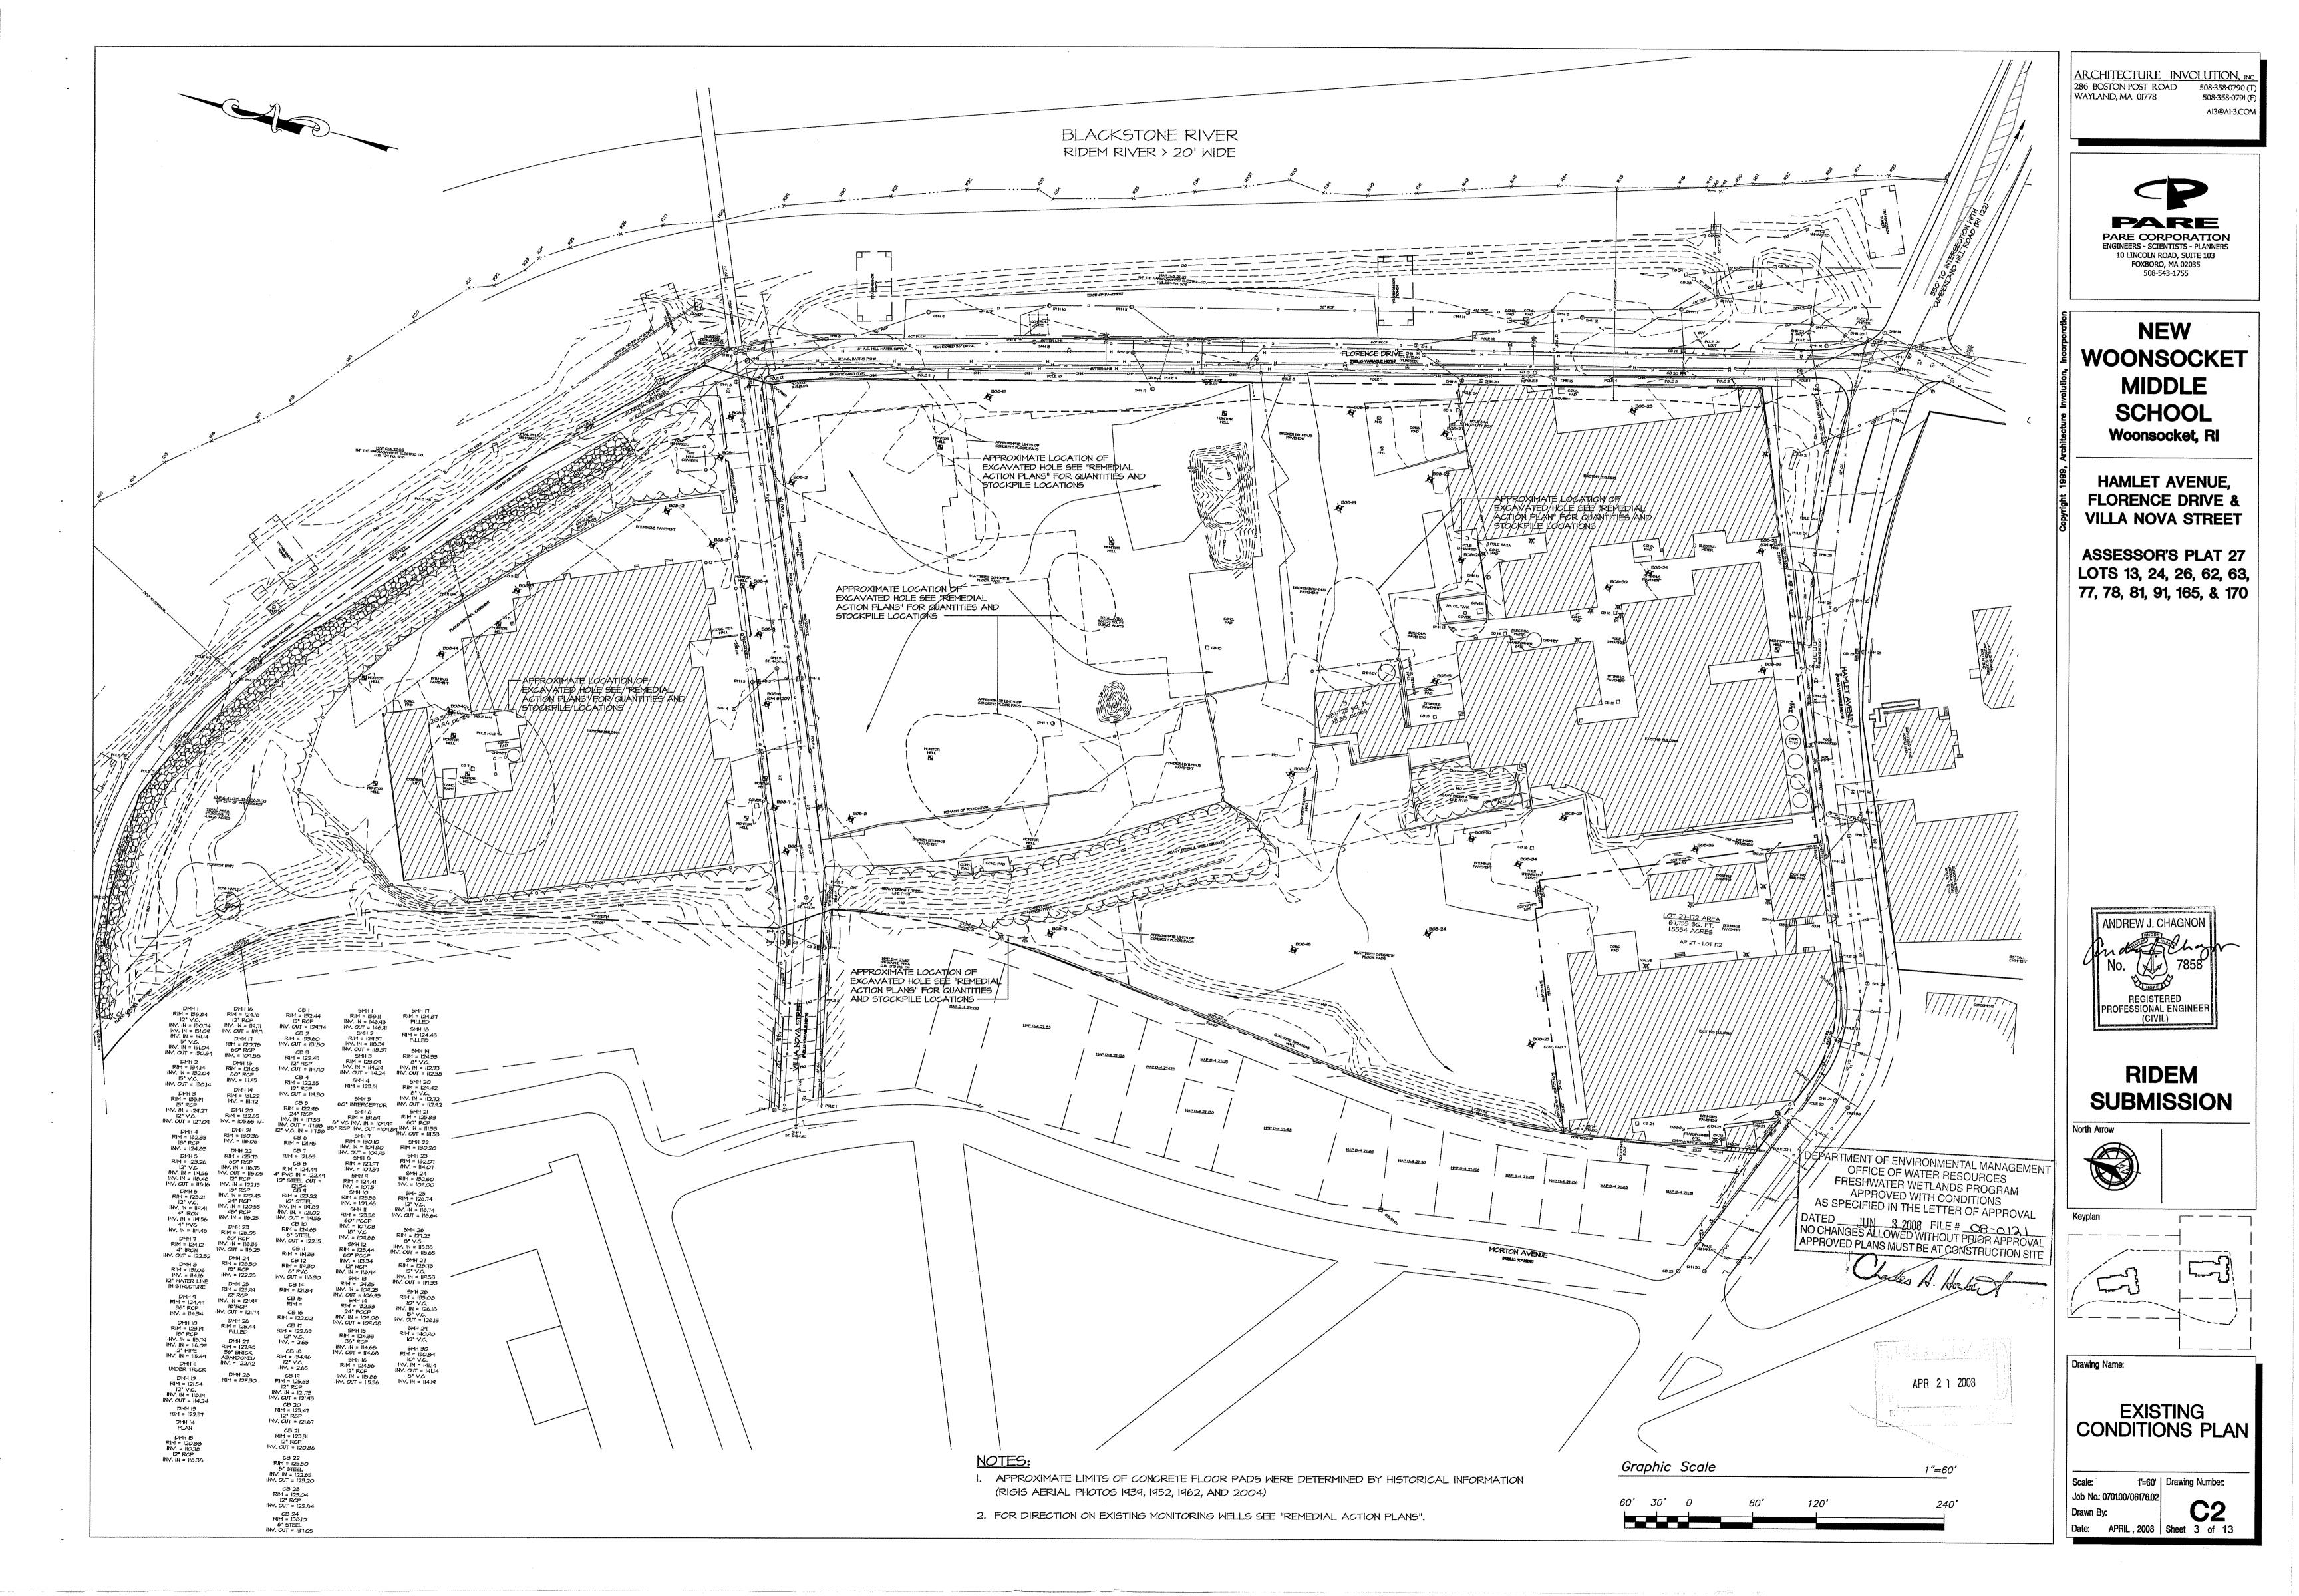


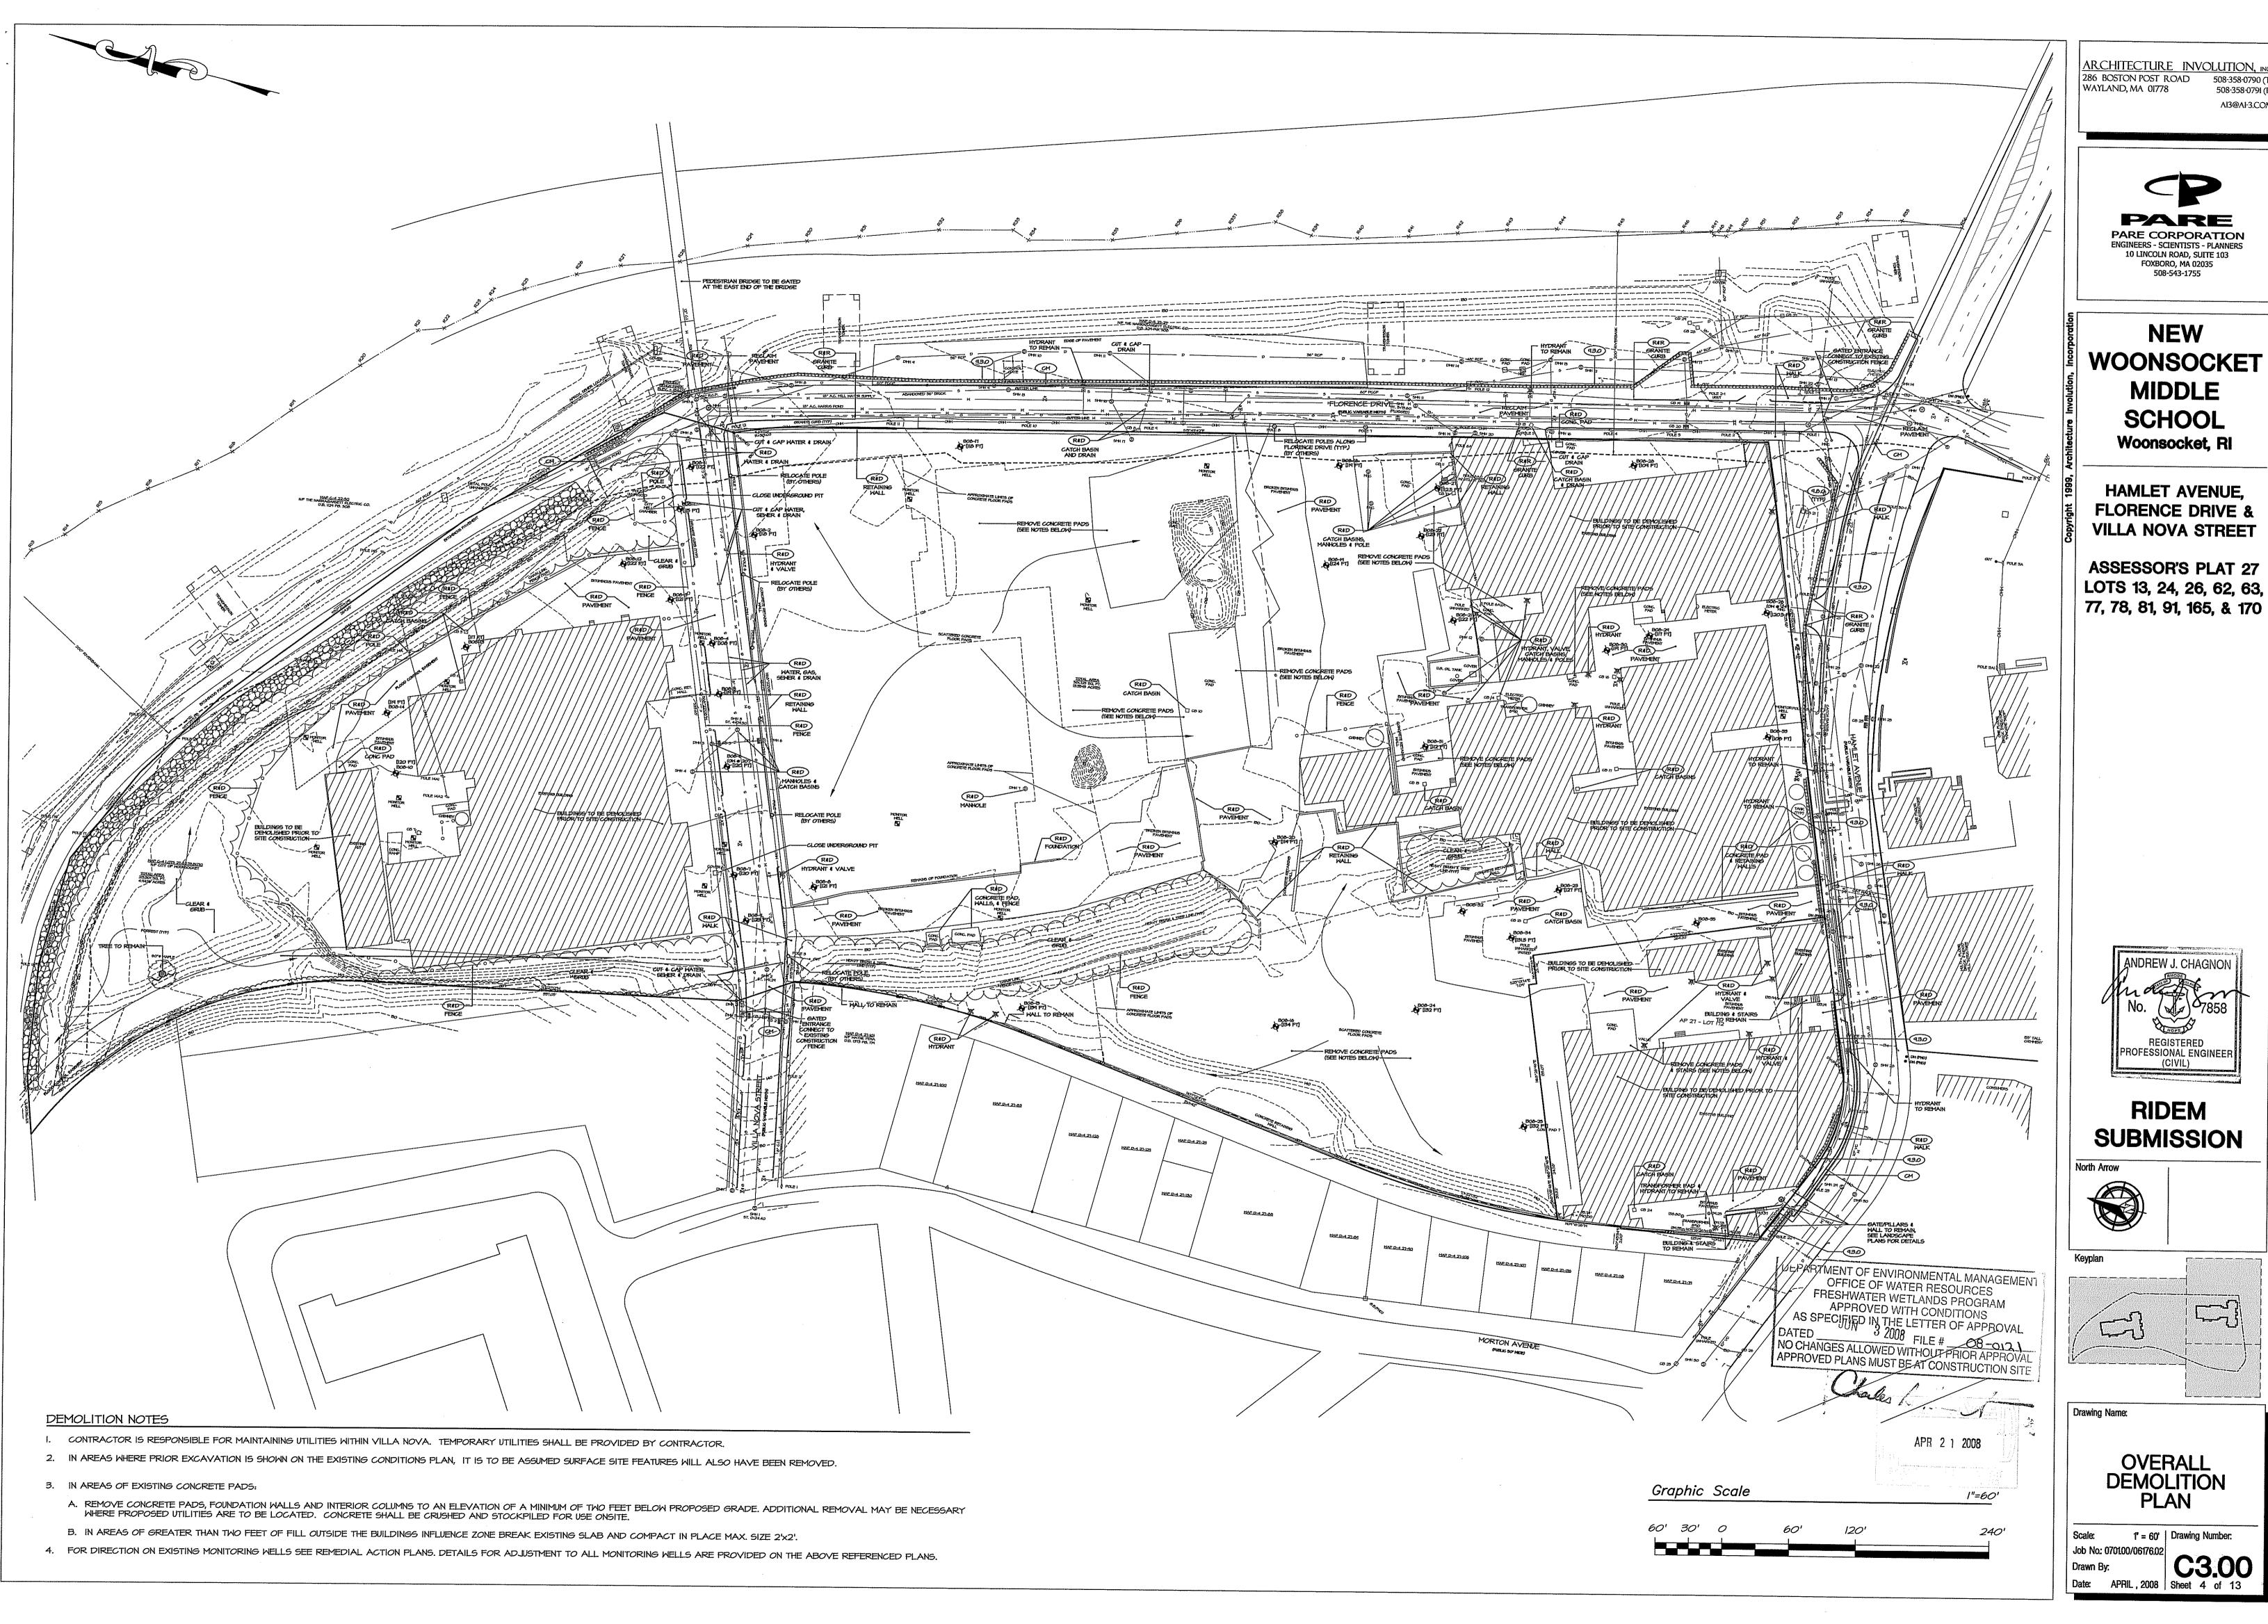

ARCHITECTURE INVOLUTION, INC. 286 BOSTON POST ROAD 508-358-0790 (T

ASSESSOR'S PLAT 27 LOTS 13, 24, 26, 62, 63,

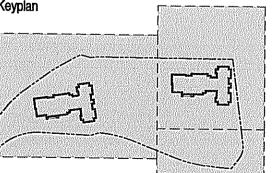

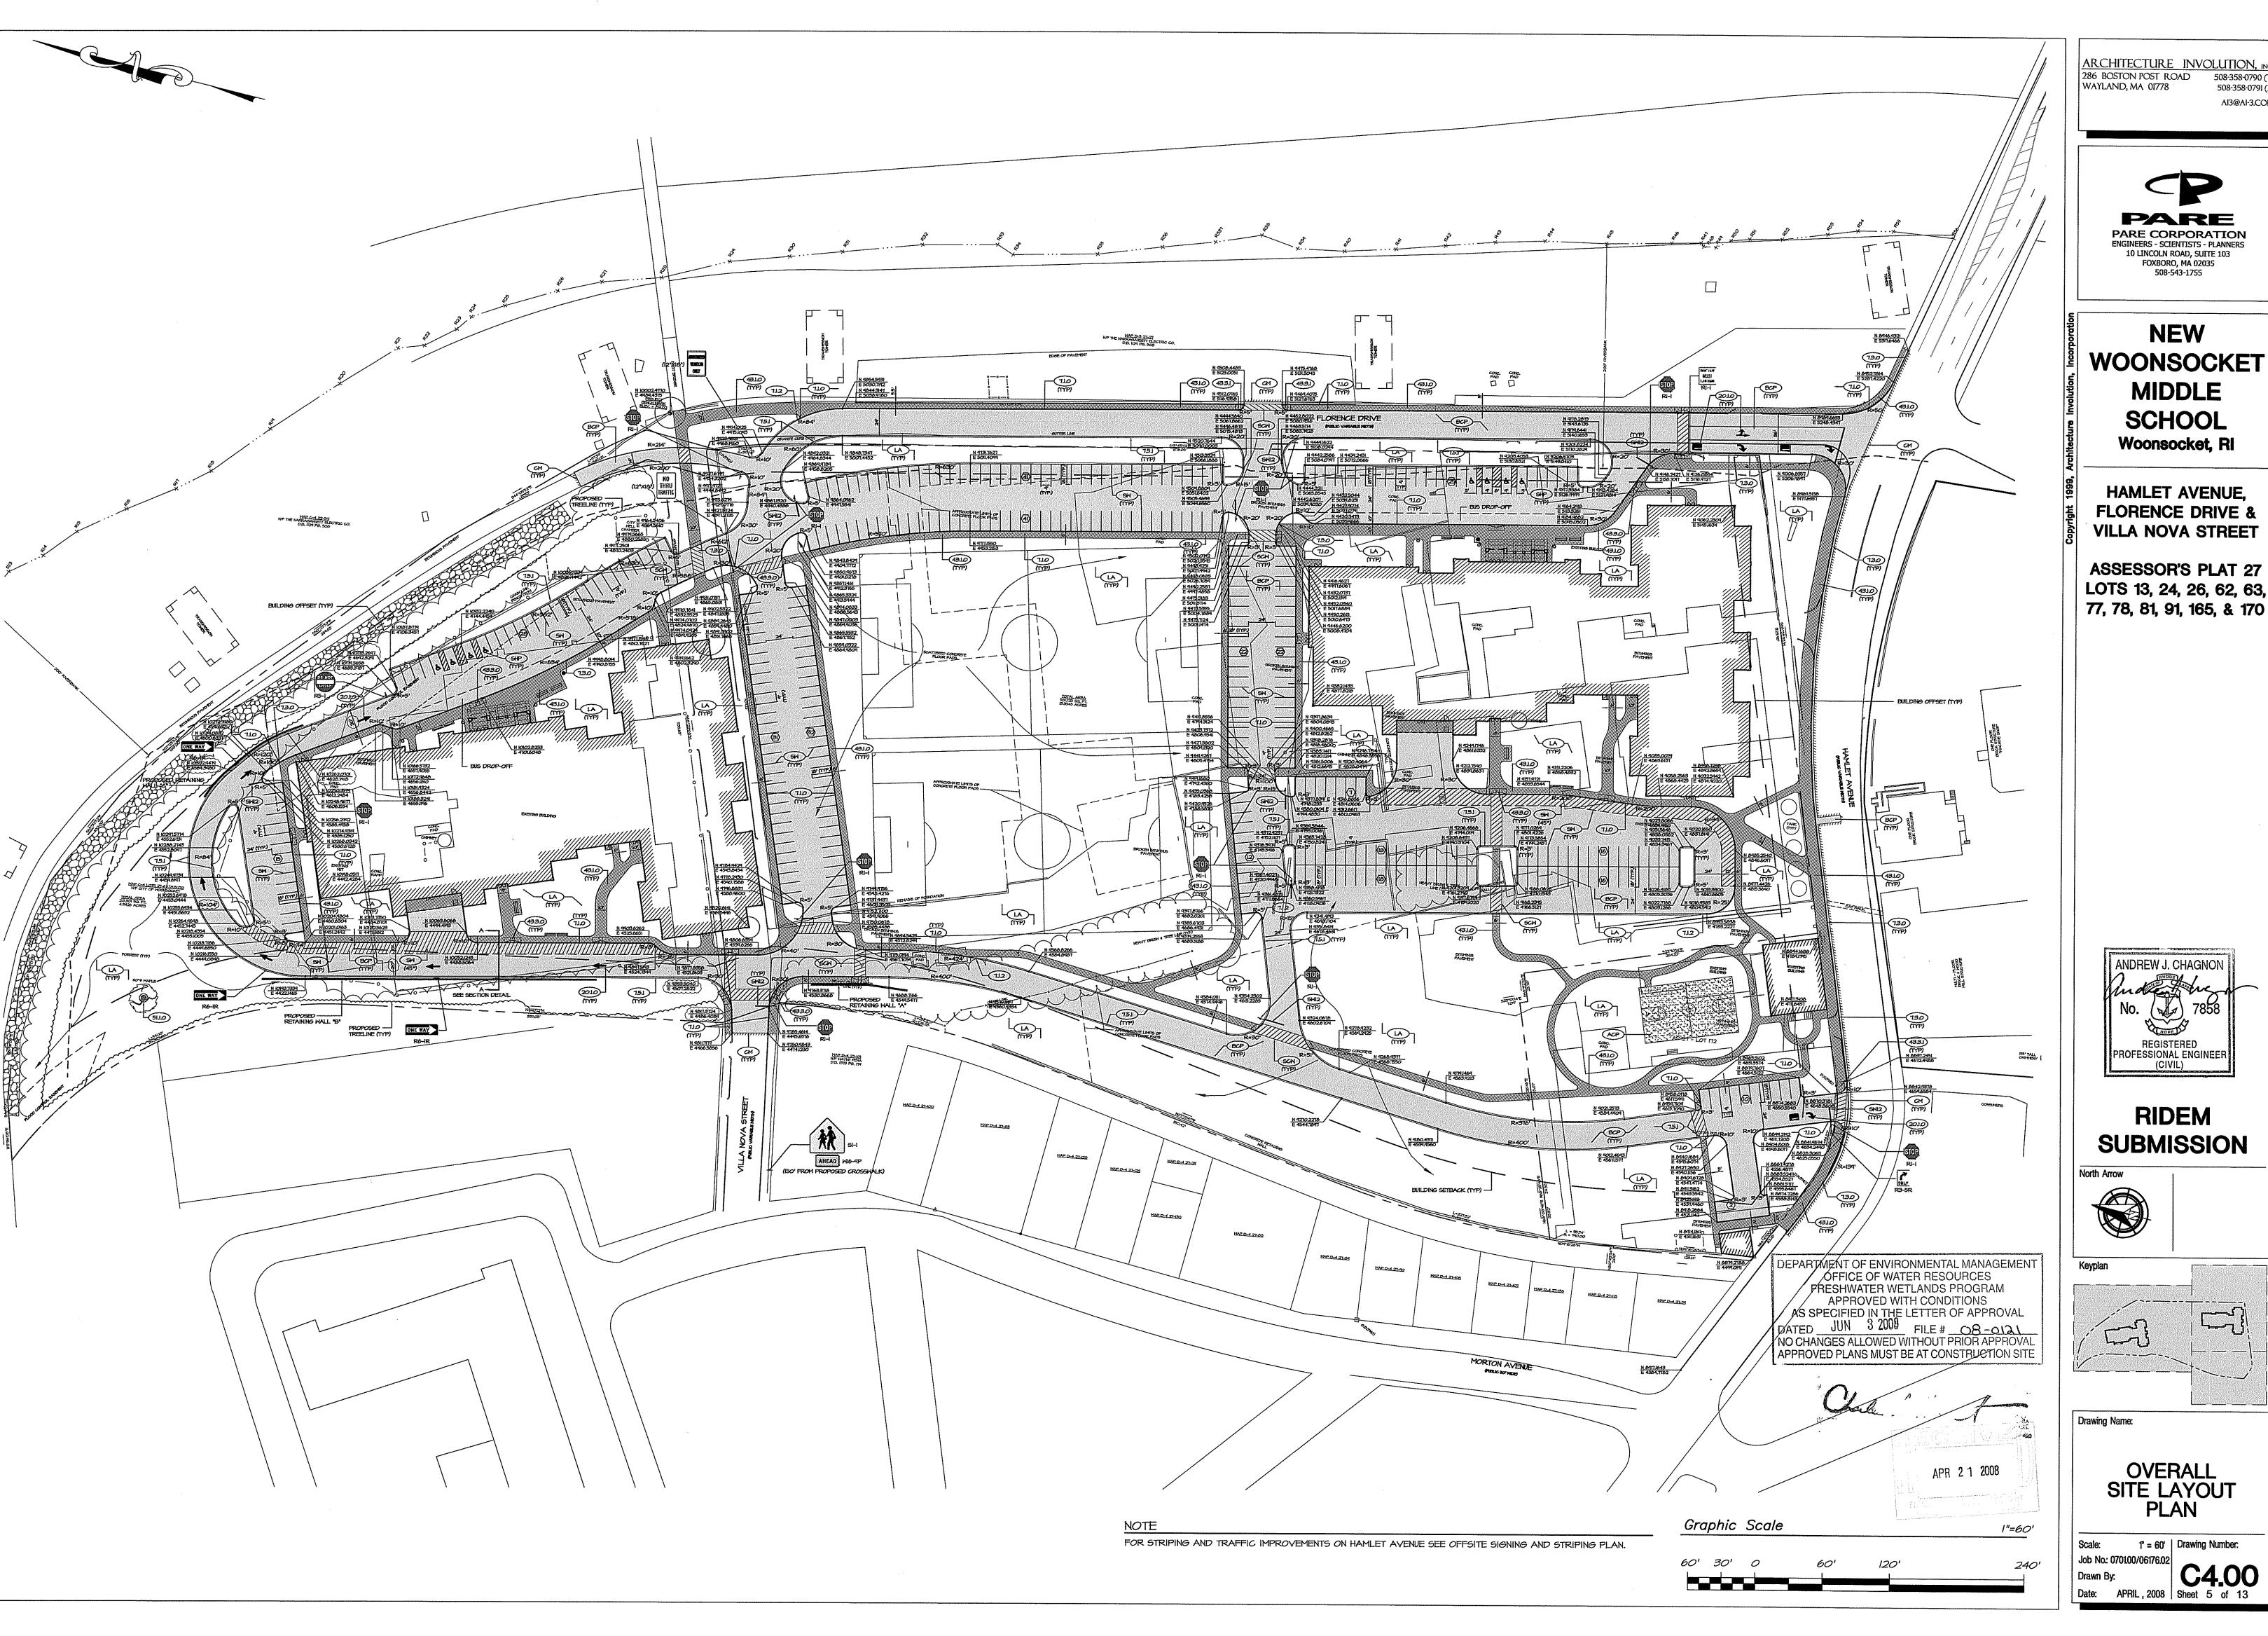



ARCHITECTURE INVOLUTION, IN 286 BOSTON POST ROAD 508-358-0790 (WAYLAND, MA 01778 508-358-0791 (

HAMLET AVENUE, FLORENCE DRIVE & **VILLA NOVA STREET**

ASSESSOR'S PLAT 27 LOTS 13, 24, 26, 62, 63, 77, 78, 81, 91, 165, & 170



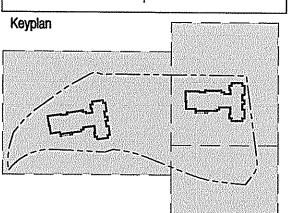

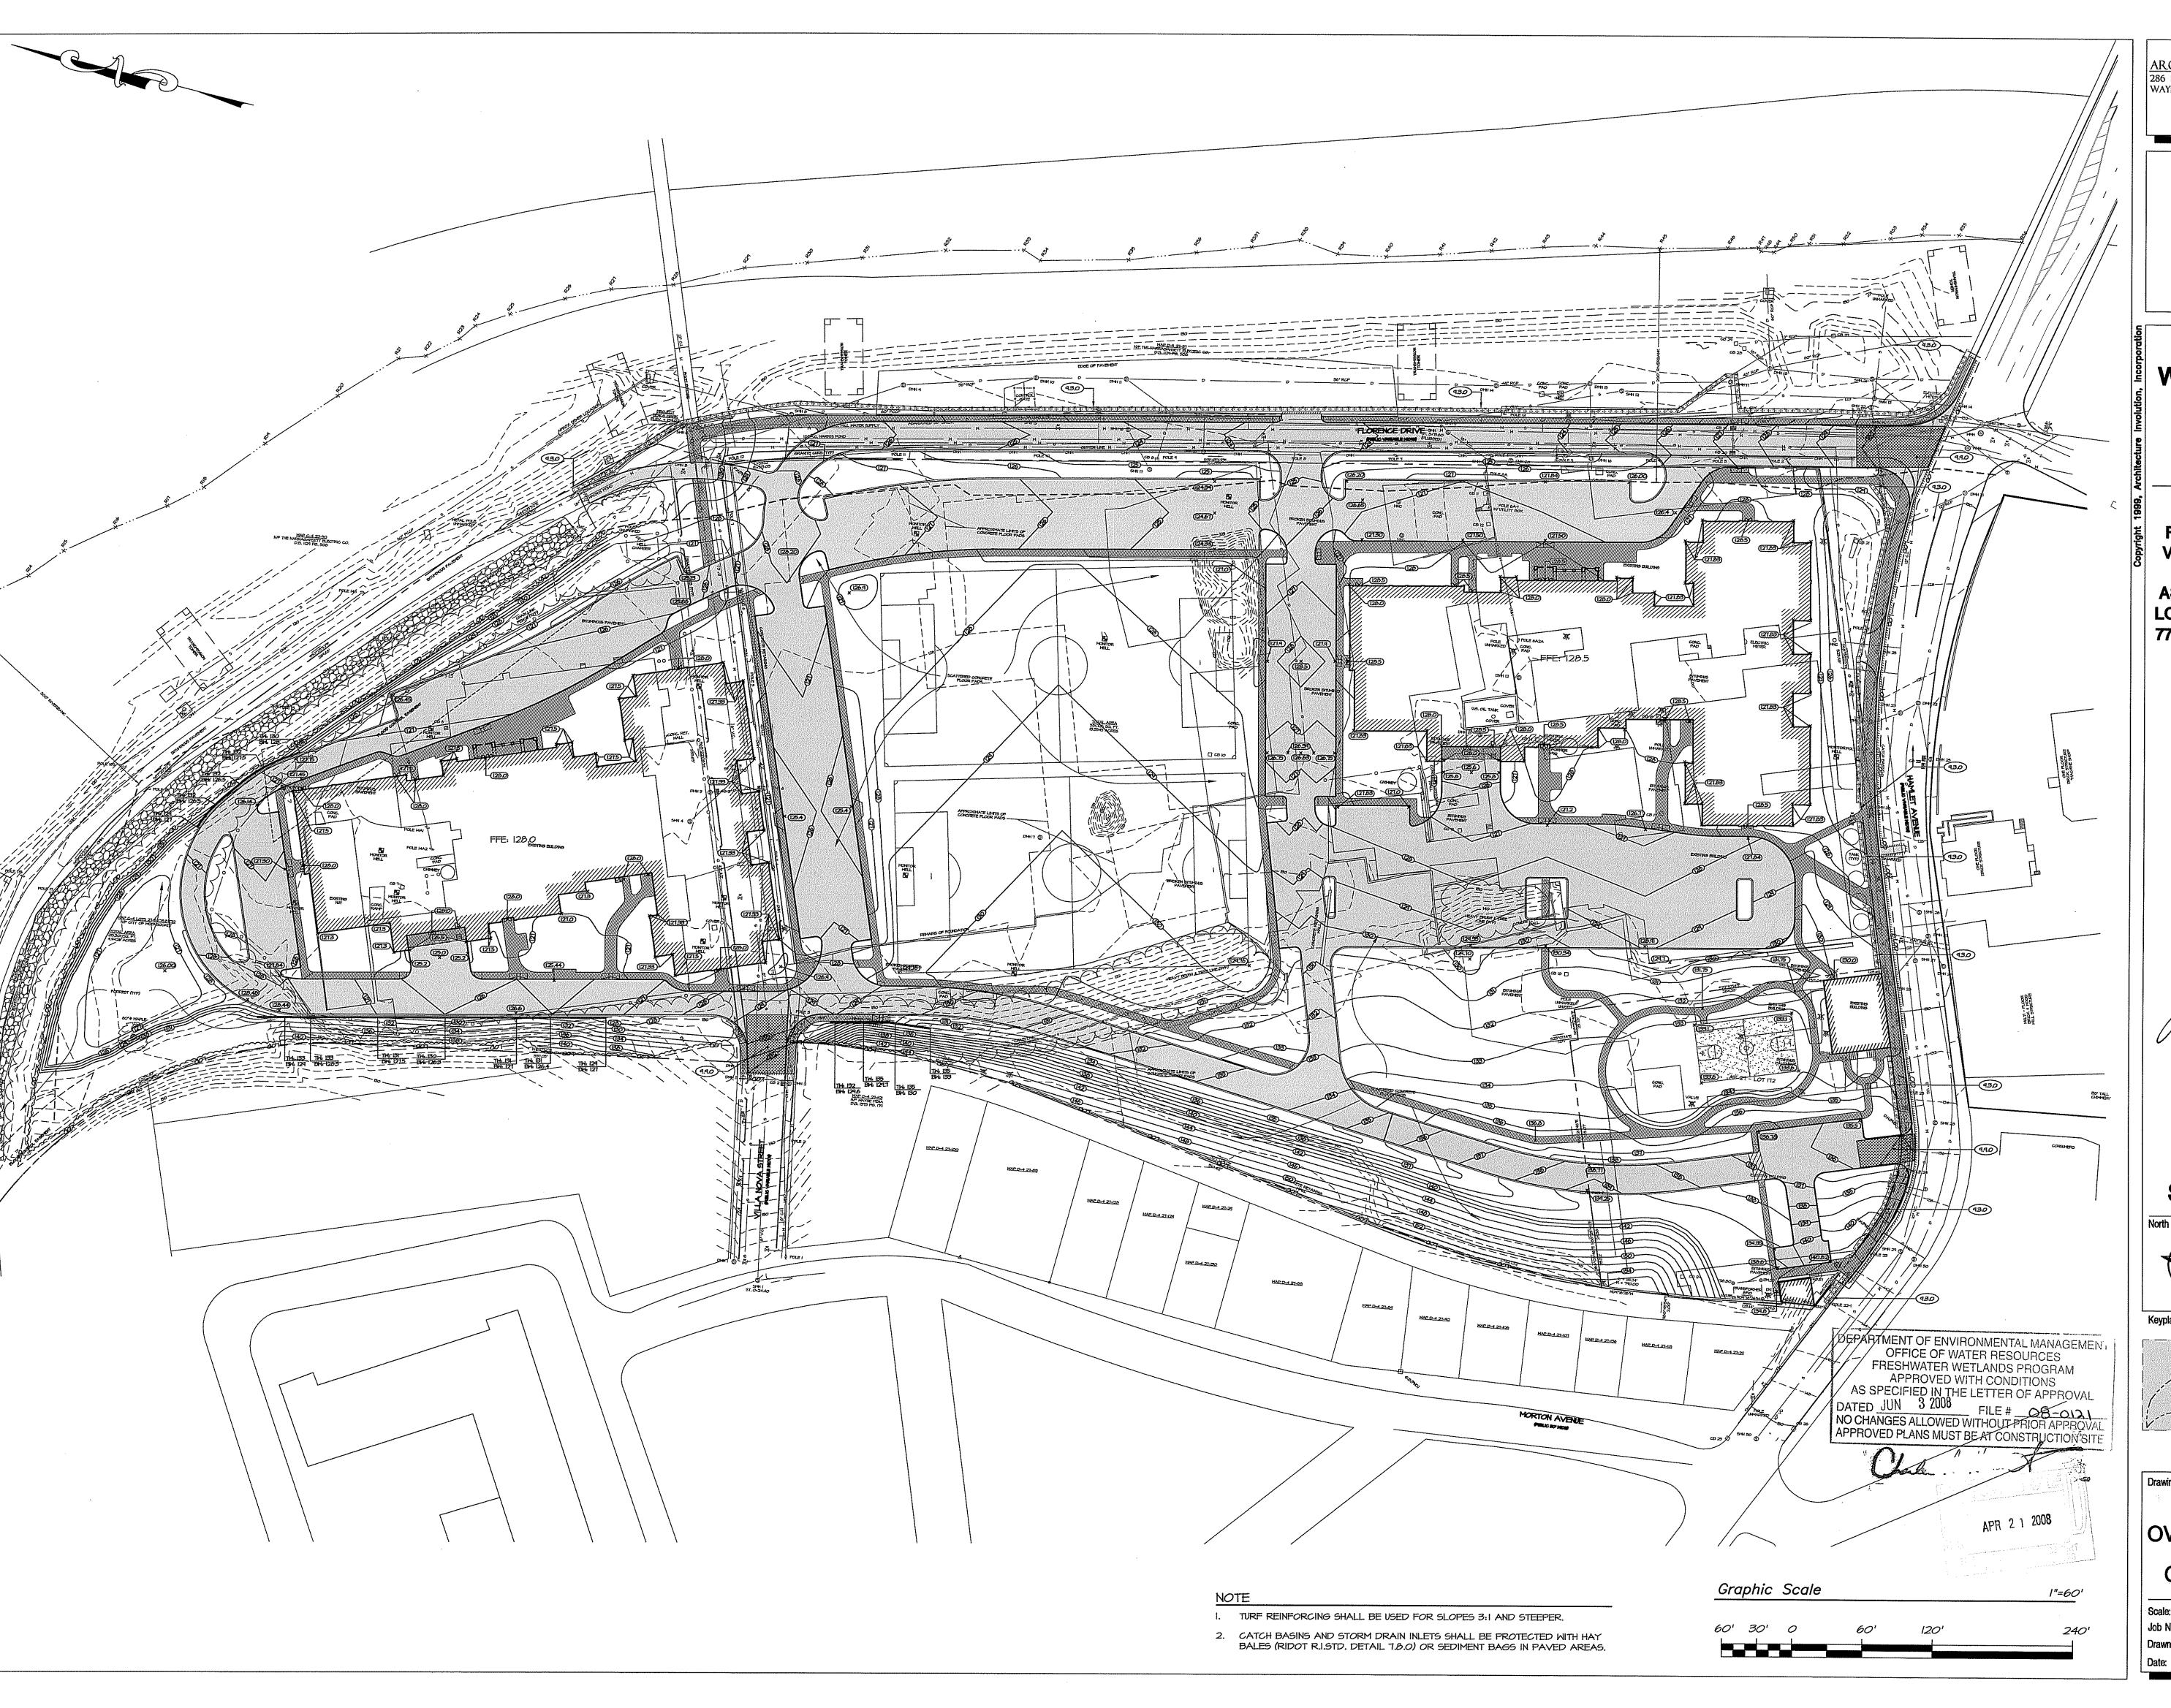

ARCHITECTURE INVOLUTION, INC 286 BOSTON POST ROAD 508-358-0790 (T) WAYLAND, MA 01778 508-358-0791 (F)




NEW WOONSOCKET MIDDLE SCHOOL

HAMLET AVENUE, FLORENCE DRIVE & VILLA NOVA STREET


Woonsocket, RI

ASSESSOR'S PLAT 27 LOTS 13, 24, 26, 62, 63, 77, 78, 81, 91, 165, & 170

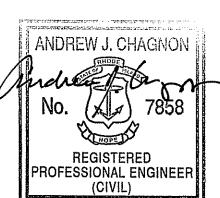

RIDEM SUBMISSION



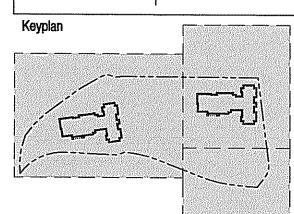


Drawing Name:

OVERALL GRADING AND EROSION CONTROL PLAN

Scale: 1" = 60" Drawing Number:
Job No: 0701.00/06176.02

APRIL . 2008 Sheet 6 of 13

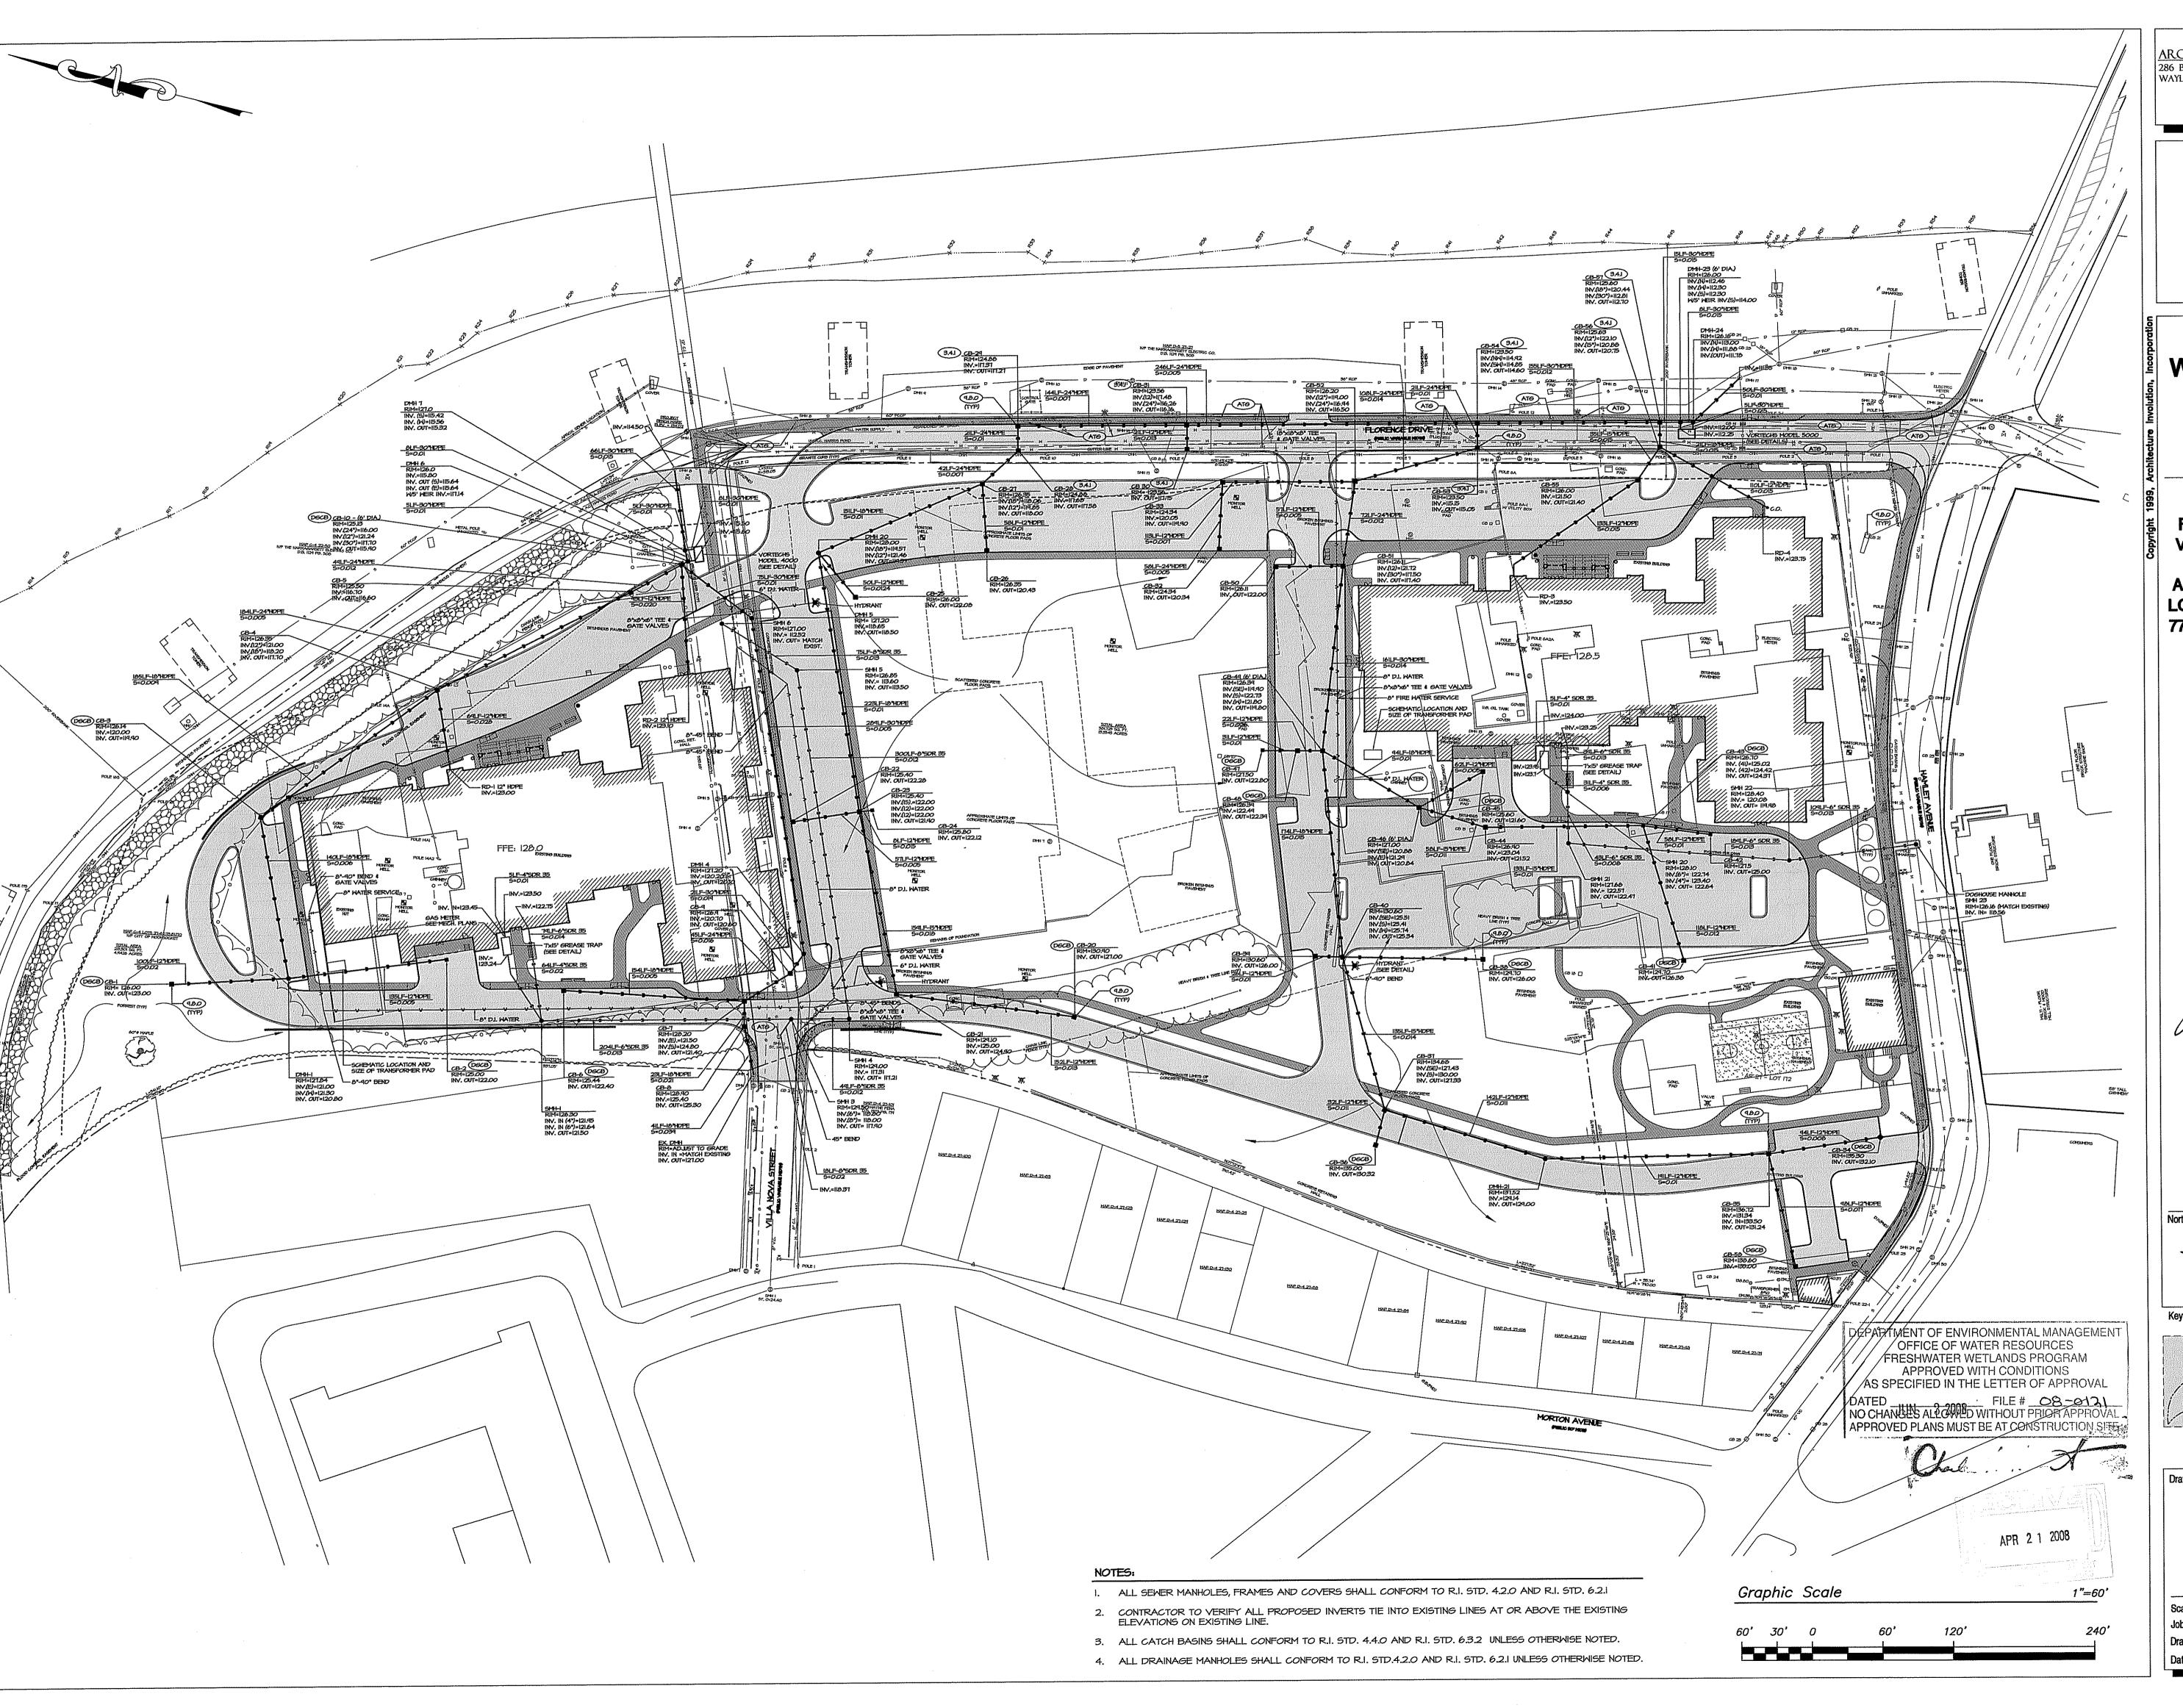


ARCHITECTURE INVOLUTION, INC 286 BOSTON POST ROAD 508-358-0790 (1 WAYLAND, MA 01778 508-358-0791 (1 AI3@AI-3.COM




NEW WOONSOCKET **MIDDLE** SCHOOL Woonsocket, RI

HAMLET AVENUE, **FLORENCE DRIVE & VILLA NOVA STREET**

ASSESSOR'S PLAT 27 LOTS 13, 24, 26, 62, 63, 77, 78, 81, 91, 165, & 170

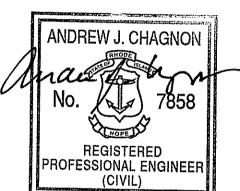

RIDEM SUBMISSION

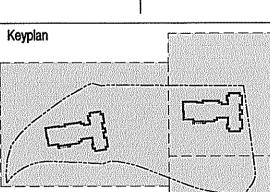


Drawing Name:

OVERALL DRAINAGE & **UTILITY PLAN**

1° = 60° | Drawing Number:

Date: APRIL, 2008 | Sheet 7 of 13

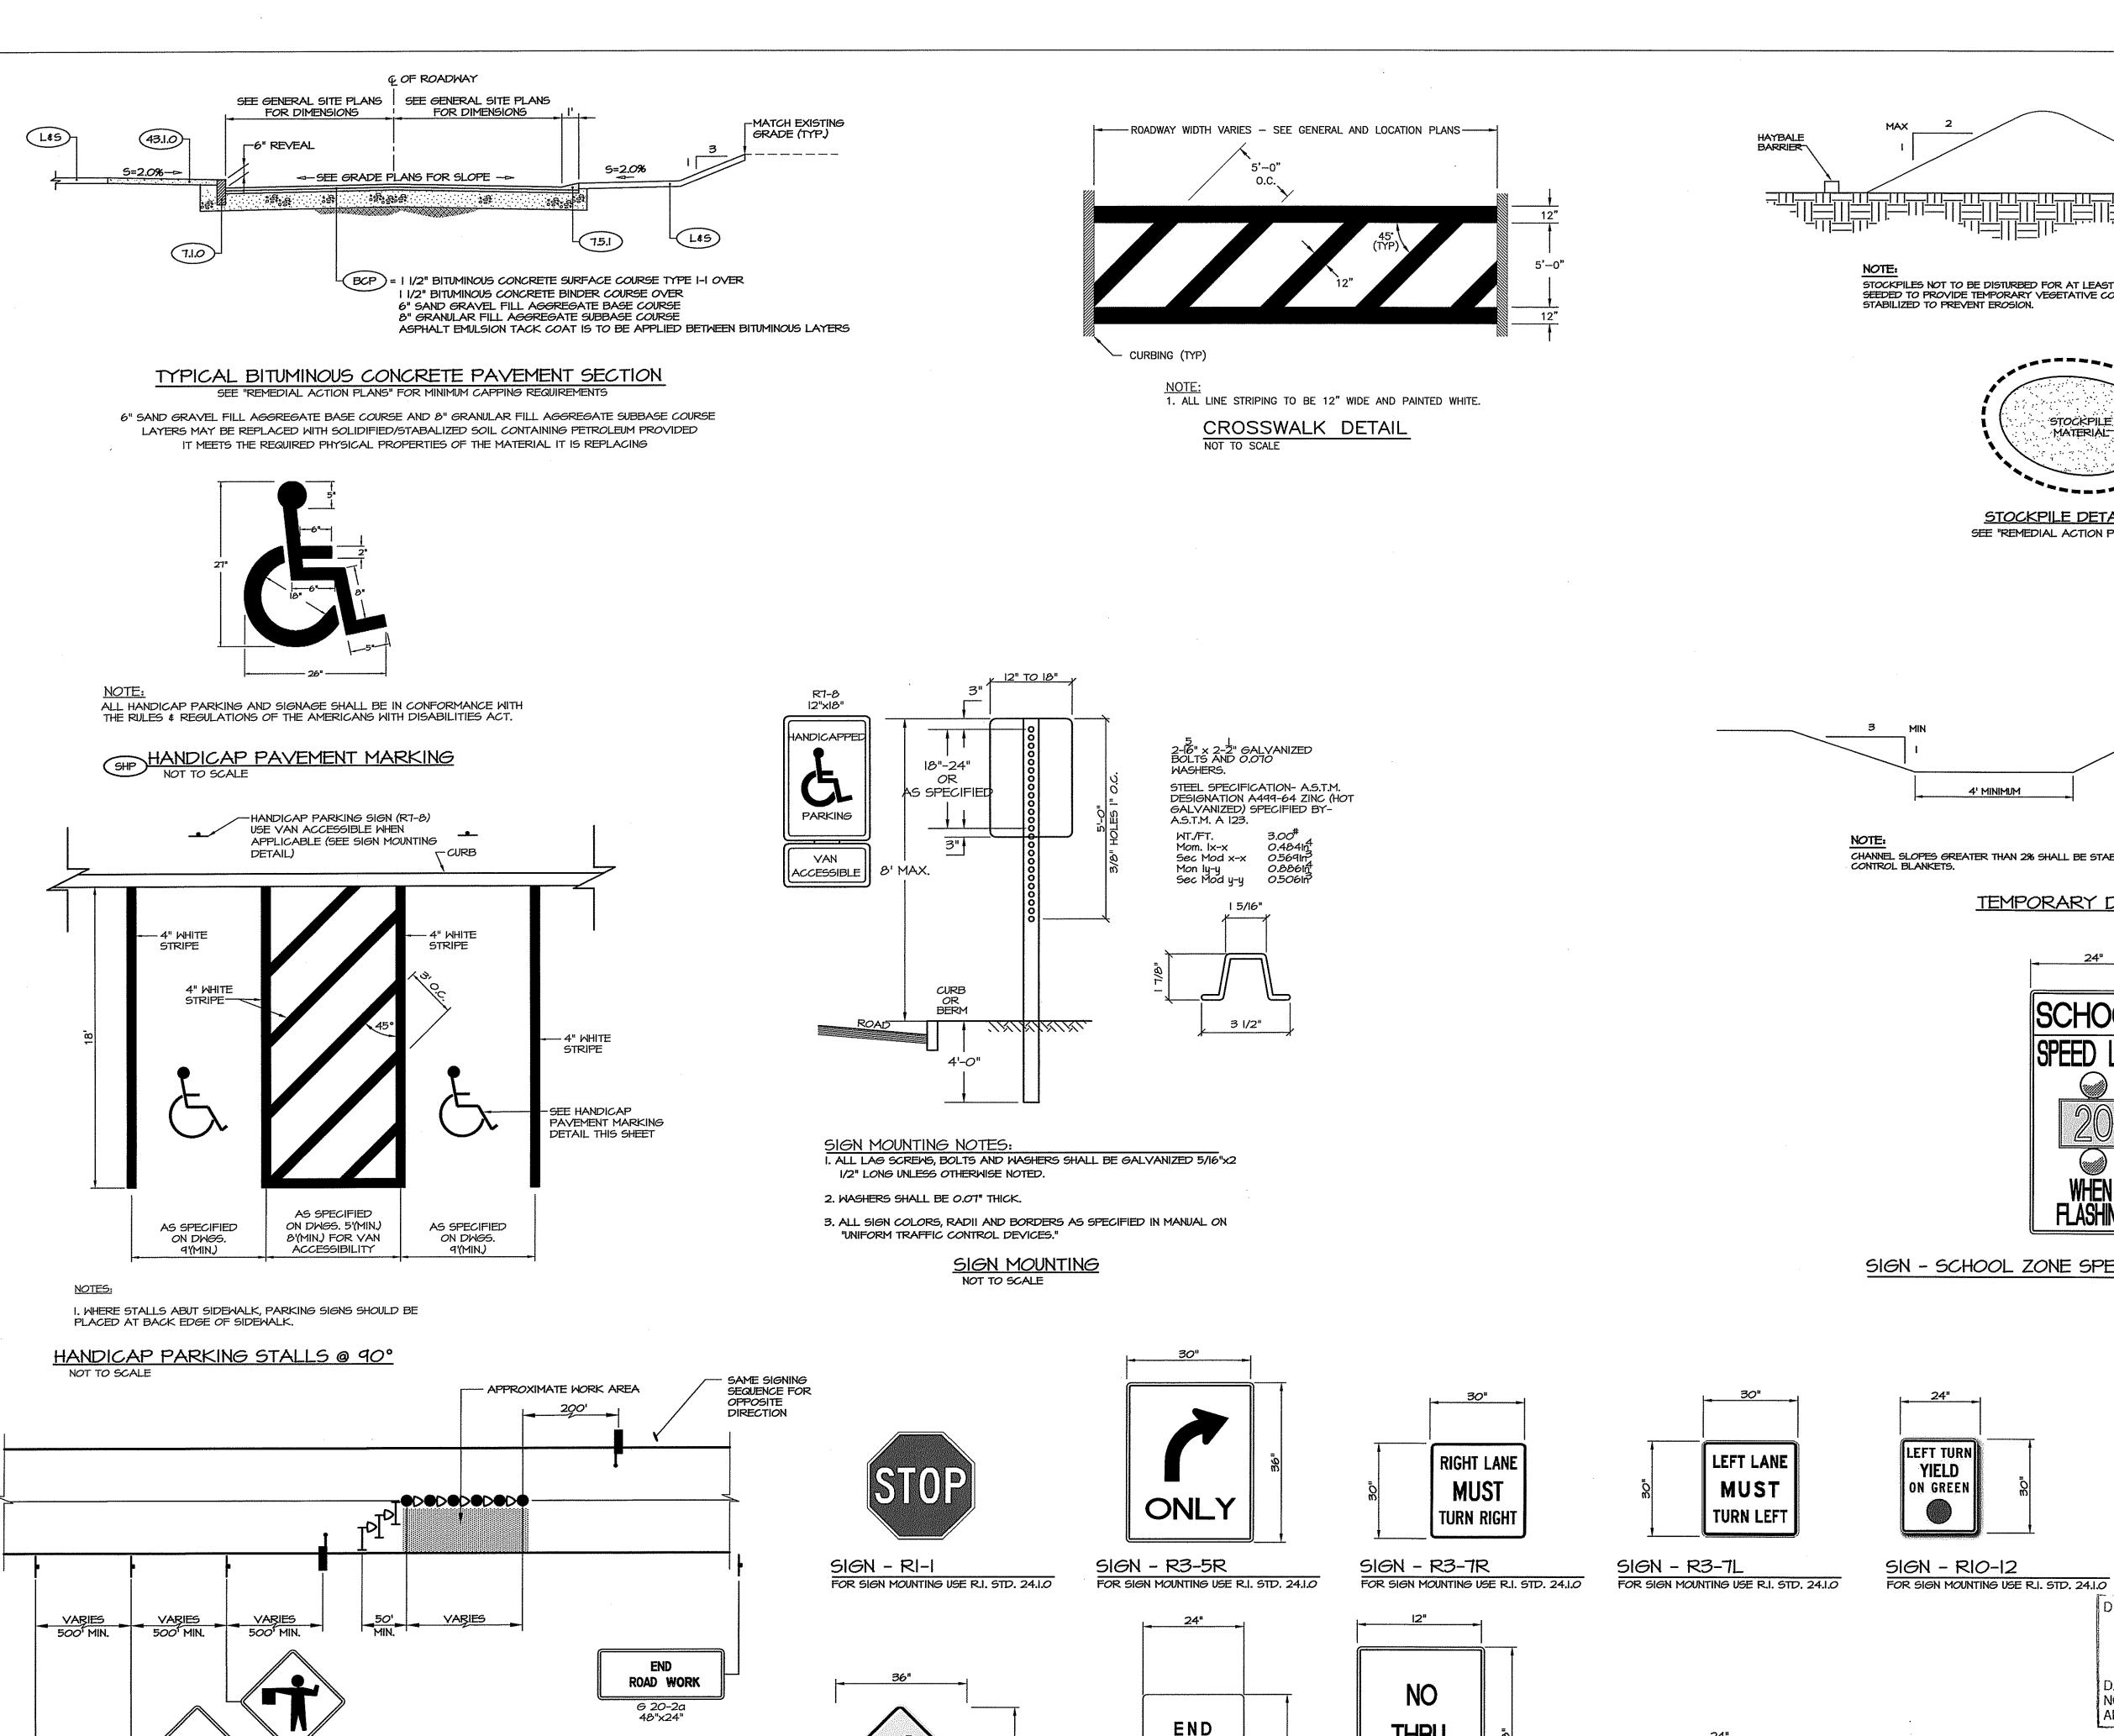

SIGN - SI-I

FOR SIGN MOUNTING USE R.I. STD. 24.I.O

1000 FT

TYPICAL ONE LANE OPERATION


ROAD

WORK


1. R.I. STD. 26.2.0 DRUMS AND/OR R.I. STD. 26.1.0 CONES SEPARATE WORK AREA. SPACING OF DRUMS AND CONES TO BE

2. SEE SPECIAL PROVISIONS FOR TEMPORARY CONSTRUCTION


DETERMINED BY THE ENGINEER.

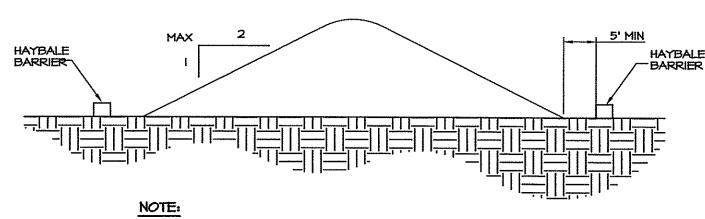

STOCKPILES NOT TO BE DISTURBED FOR AT LEAST 21 DAYS, SHALL BE SEEDED TO PROVIDE TEMPORARY VEGETATIVE COVER OR OTHERWISE STABILIZED TO PREVENT EROSION.

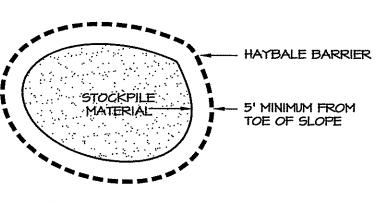


STOCKPILE DETAIL SEE "REMEDIAL ACTION PLANS"

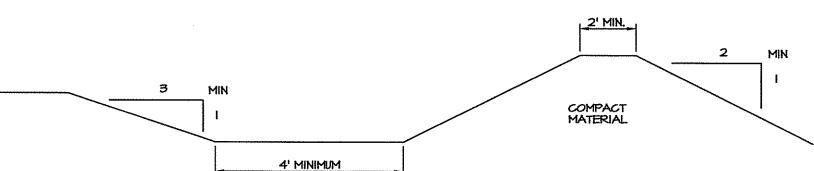

CHANNEL SLOPES GREATER THAN 2% SHALL BE STABILIZED WITH CRUSHED STONE OR EROSION CONTROL BLANKETS.

TEMPORARY DIVERSION

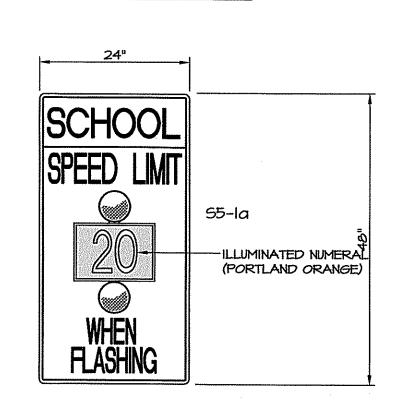


SIGN - R6-IR

FOR SIGN MOUNTING USE R.I. STD. 24.I.O

DEPARTMENT OF ENVIRONMENTAL MANAGEMENT OFFICE OF WATER RESOURCES FRESHWATER WETLANDS PROGRAM

APPROVED WITH CONDITIONS
AS SPECIFIED IN THE LETTER OF APPROVAL
DATED JUN 3 2008 FILE # 08-012 |
NO CHANGES ALLOWED WITHOUT PRIOR APPROVAL

SIGN - SCHOOL ZONE SPEED LIMIT SIGN CODE S5-IA

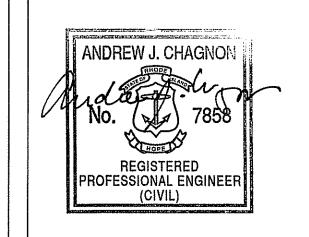

ARCHITECTURE INVOLUTION, IN 286 BOSTON POST ROAD 508-358-0790 (T

PARE

PARE CORPORATION

ENGINEERS - SCIENTISTS - PLANNERS

10 LINCOLN ROAD, SUITE 103

FOXBORO, MA 02035

508-543-1755

NEW

WOONSOCKET

MIDDLE

SCHOOL

Woonsocket, RI

HAMLET AVENUE,

FLORENCE DRIVE &

VILLA NOVA STREET

ASSESSOR'S PLAT 27

LOTS 13, 24, 26, 62, 63,

77, 78, 81, 91, 165, & 170


508-358-0791 (F

AI3@AI-3.COM

WAYLAND, MA 01778

RIDEM SUBMISSION

North Arrow

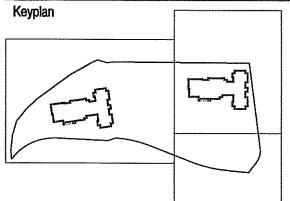

Drawing Name:


SITE DETAILS No.1

Scale: Not To Scale | Drawing Number: Job No.: 0701.00/06176.02 Date: APRIL, 2008 | Sheet 8 of 13

TRAFFIC

SIGN - SP-I FOR SIGN MOUNTING USE R.I. STD. 24.1.0 **AHEAD**

SIGN - W6-9P FOR SIGN MOUNTING USE R.I. STD. 24.I.O

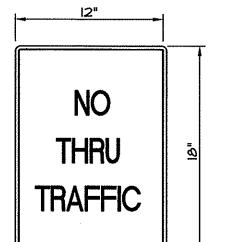


SCHOOL

ZONE

FOR SIGN MOUNTING USE R.I. STD. 24.I.O

SIGN - 55-2

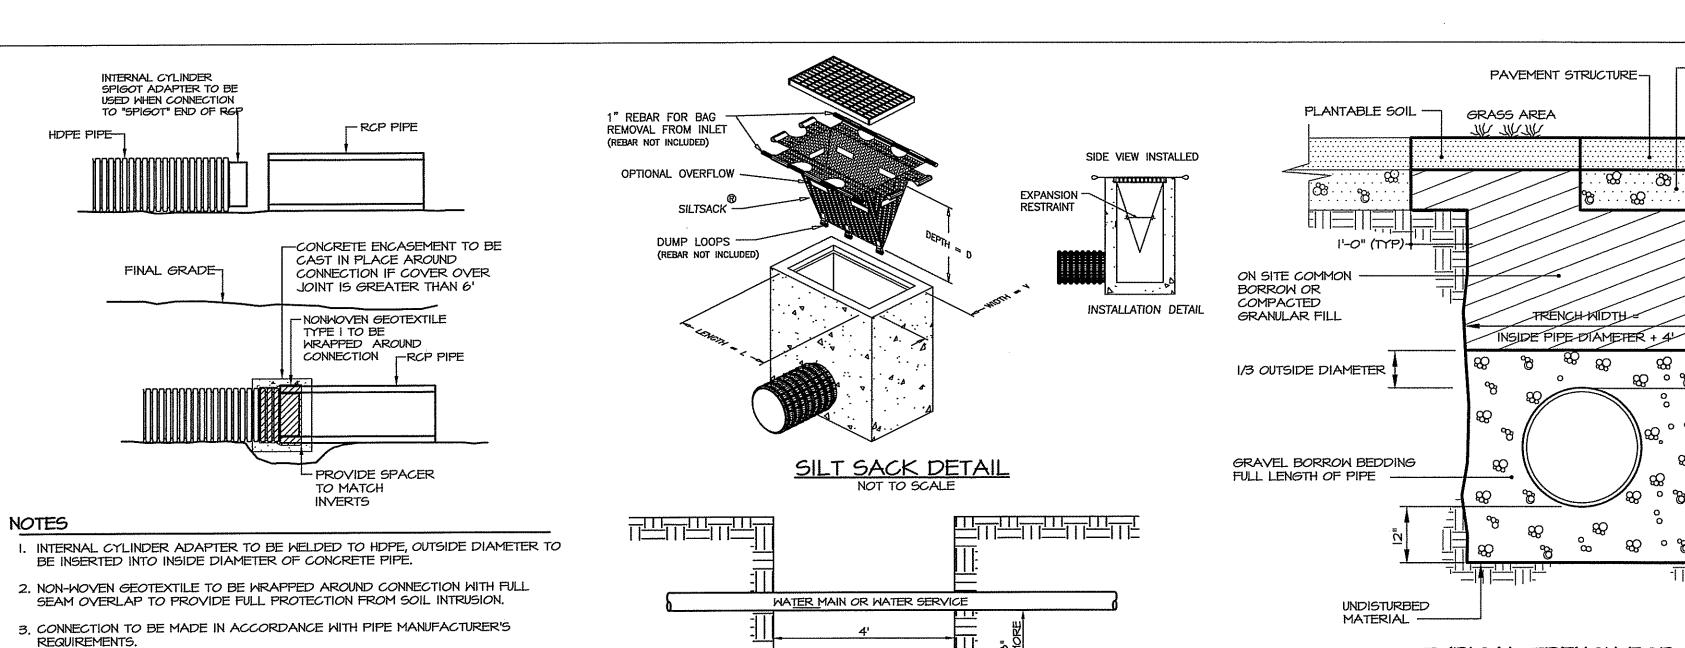

4 4

MINIMUM DISTANCES FOR SEWER

AND WATER LINE CROSSINGS

CONCRETE

DOCUMENTS AND SETTINGSVINICCALLIDESKTOPASKO 42-SUBLING 1/152/00 10:57 AM

TYPICAL TRENCH FOR SEWER AND DRAINAGE INSTALLATION

6" SAND GRAVEL FILL AGGREGATE BASE COURSE 6" GRANULAR FILL AGGREGATE SUBBASE COURSE

- SAWOUT EXIST. PAVEMENT

"COVER" AT ANY POINT SHALL BE DEFINED

AS THE VERTICAL DISTANCE FROM THE

LINE WHICH CONNECTS THE SURFACE OF

UNDISTURBED GROUND AT EITHER SIDE OF

THE TRENCH AND IS AT RIGHT ANGLES TO

UPPER MOST POINT OF THE PIPE TO A

THE DIRECTION OF THE PIPE

WHERE REQUIRED, (TYP)

<u>`</u> & }

88

GRASS AREAS PAYED AREAS 2" GREEN*/BLUE METALIZED DETECTABLE - BITUMINOUS PAVEMENT IDENTIFICATION TAPE W "CAUTION SEMER*/WATER LINE BURIED BELOW" BURIED ---- 12" GRAVEL BORROW BASE COVER I'-O" DEPTH -LOAM AND SEED-- SAW CUT EXIST. PAVEMENT (TYP.) COMMON BORROW FREE OF LARGE STONES, FROZEN MATERIAL, ETC., COMPACTED TO MIN. 95% MAXIMUM ON SITE COMMON ' DRY DENSITY BORROW OR COMPACTED GRANULAR FILL GRAVEL BORROW BEDDING OF APPROVED SELECTED MATERIAL TO TOP EXCAVATION PAY LIMIT GRAVEL BORROW BEDDIN FULL LENGTH OF PIPE -6" CRUSHED STONE (12" IF INSTALLED - OVER ROCK) 1'-0" PIPE O.D. SOIL UNDER GRAVEL BORROW BEDDING SHALL BE

UNDISTURBED OR COMPACTED W/ SEVERAL PASSES OF A VIBRATORY COMPACTOR

I. FOR WATER PIPE INSTALLATION THE METALIZED TAPE WILL BE BLUE WITH "CAUTION WATER LINE BURIED BELOW"


2. FOR PIPE INSTALLATION IN ROCK OR LEDGE MINIMUM TRENCH WIDTH SHOULD EQUAL THE DIAMETER OF THE PIPE PLUS IS INCHES ON EACH SIDE.

3. MINIMUM WIDTH OF TRENCH SHOULD BE 3 FEET.

4. PLACE 6" OF DRAINAGE STONE FROM BASE OF TRENCH TO TOP OF PIPE IF PIPE IS INSTALLED BELOW SEASONAL HIGH GROUND WATER.

5. SEE "REMEDIAL ACTION PLANS" FOR CAPPING REQUIREMENTS.

TYPICAL WATER TRENCH

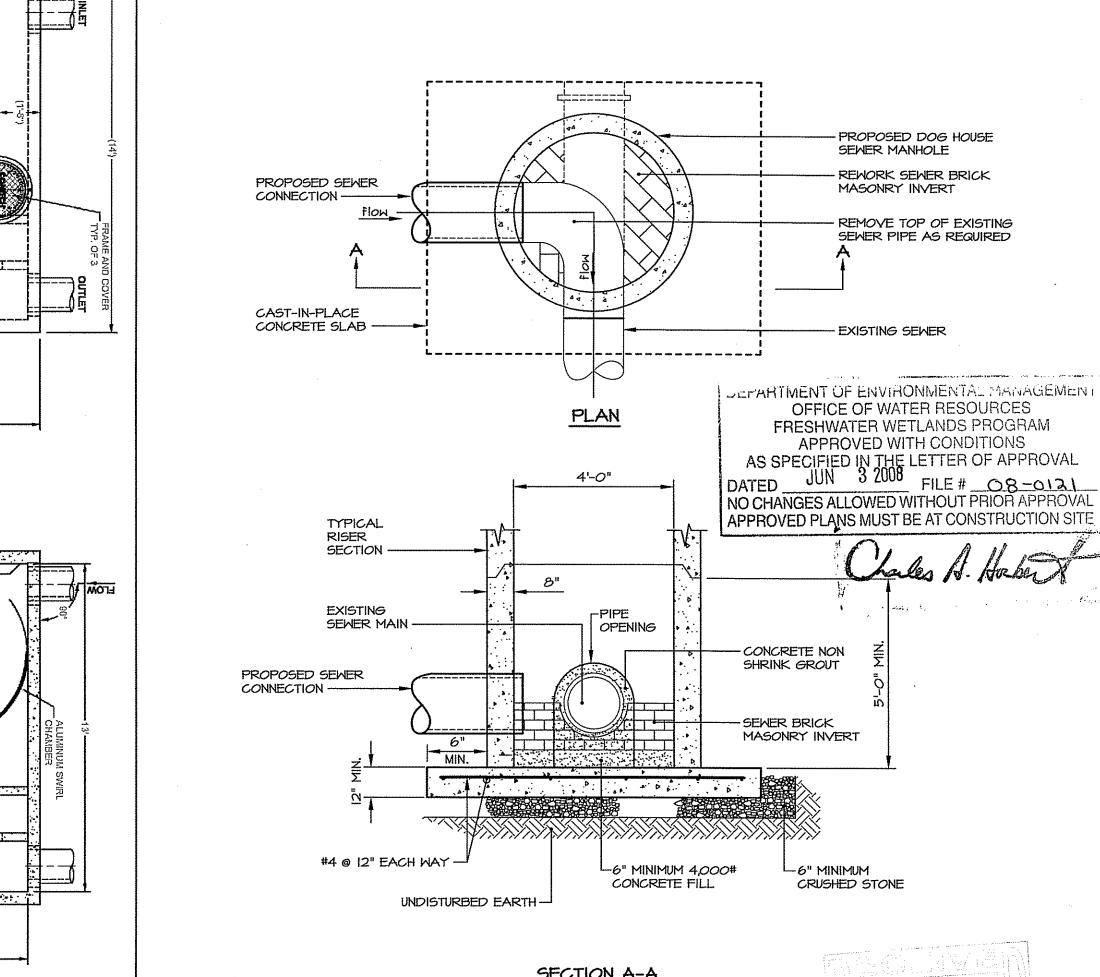

SECTION A-A

DOG-HOUSE MANHOLE BASE

ANDREW J. CHAGNON REGISTERED PROFESSIONAL ENGINEER (CIVIL)

ARCHITECTURE INVOLUTION, IN

PARE

PARE CORPORATION

ENGINEERS - SCIENTISTS - PLANNERS

10 LINCOLN ROAD, SUITE 103

FOXBORO, MA 02035

508-543-1755

NEW

WOONSOCKET

MIDDLE

SCHOOL

Woonsocket, RI

HAMLET AVENUE,

FLORENCE DRIVE &

VILLA NOVA STREET

ASSESSOR'S PLAT 27

LOTS 13, 24, 26, 62, 63,

77, 78, 81, 91, 165, & 170

508-358-0790 (T


508-358-0791 (F


AI3@AI-3.COM

286 BOSTON POST ROAD

WAYLAND, MA 01778

RIDEM SUBMISSION

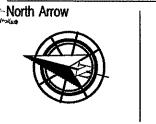

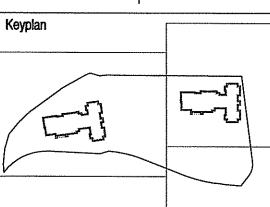

Drawing Name:

APR 2 1 2008

SITE DETAILS No.2

As Noted | Drawing Number:

Date: APRIL, 2008 | Sheet 9 of 13

—> SUBMITTAL VORTECHS MODEL 4000 - 35109-01

WOONSOCKET MIDDLE SCHOOL

WOONSOCKET, RI

SITE DESIGNATION: A

OR APPROVED EQUIVALENT


INTERNAL CYLINDER SPIGOT ADAPTER NOT REQUIRED IF HDPE IS CONNECTION


HDPE/RCP PIPE JOINT


NOT TO SCALE


TO "BELL" END OF RCP.

DOCUMENTS AND SETTINGSTRUCCALLIDESKTOPASSOROLSLIDENG 1/ISBOOR 1037 AM

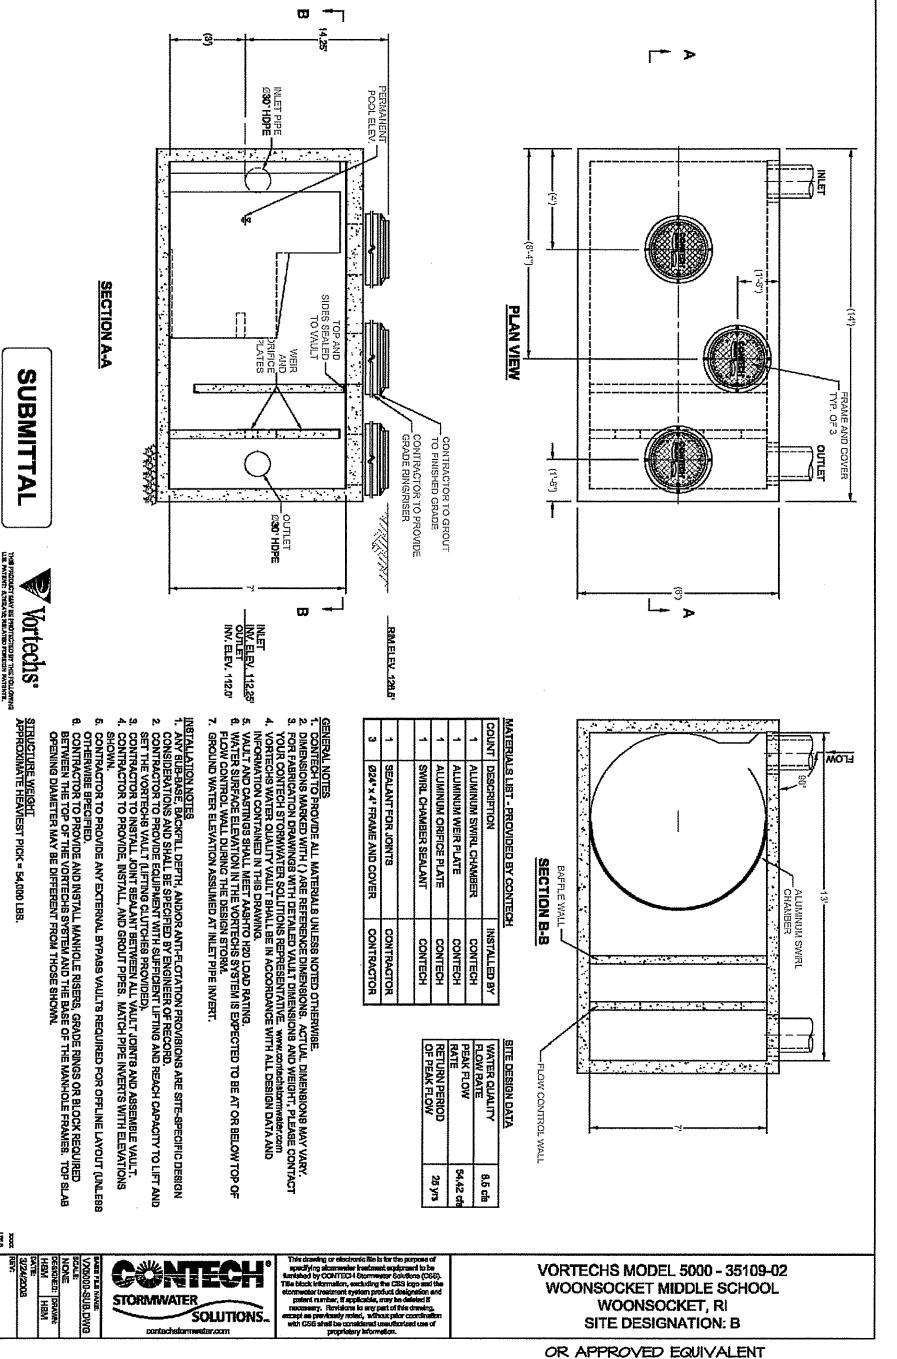


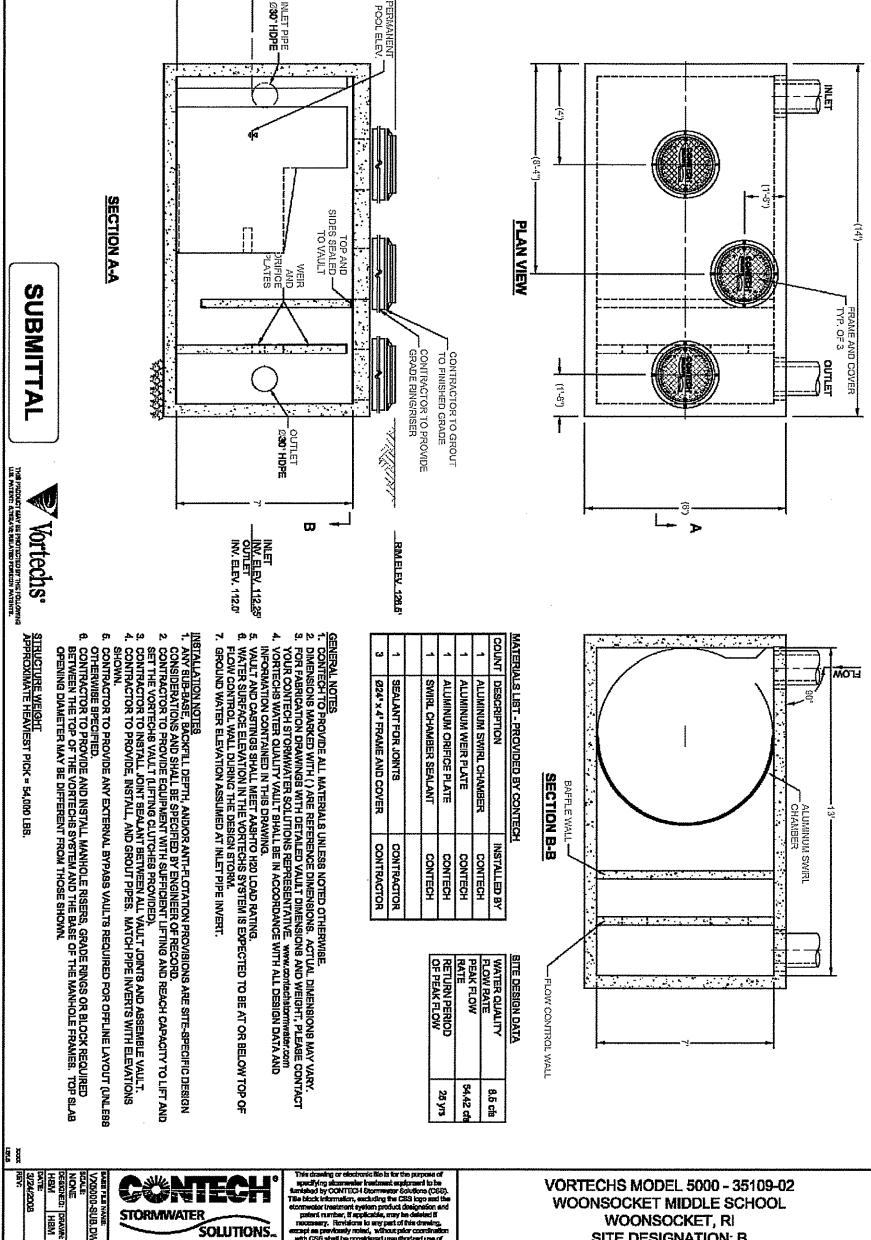

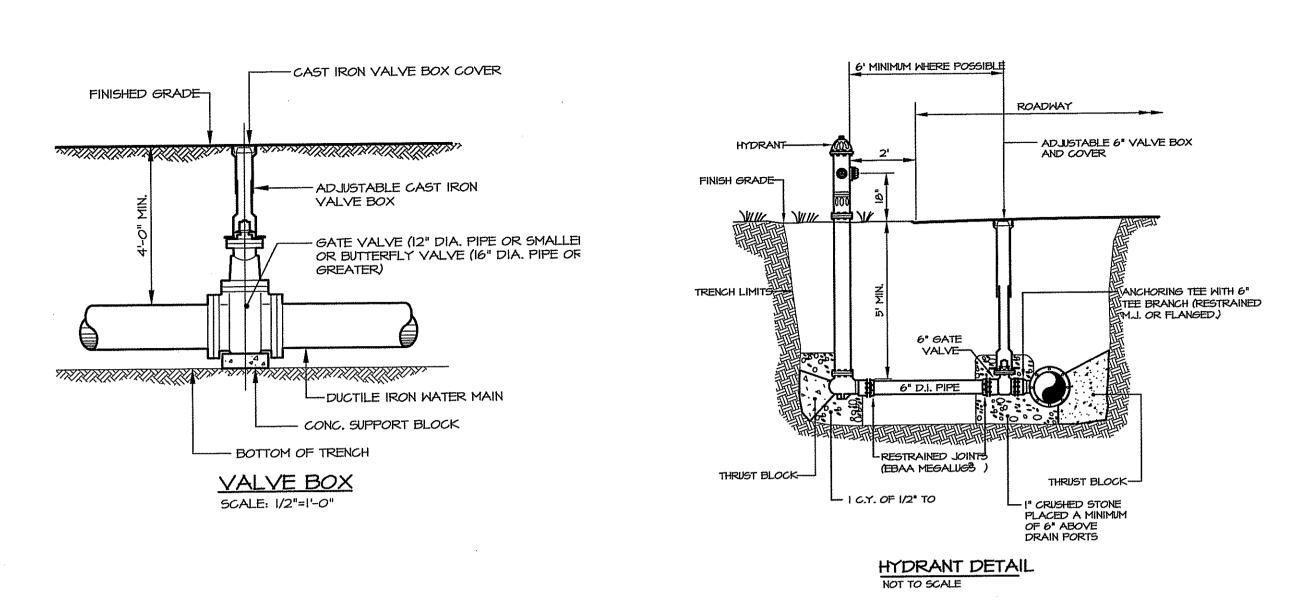

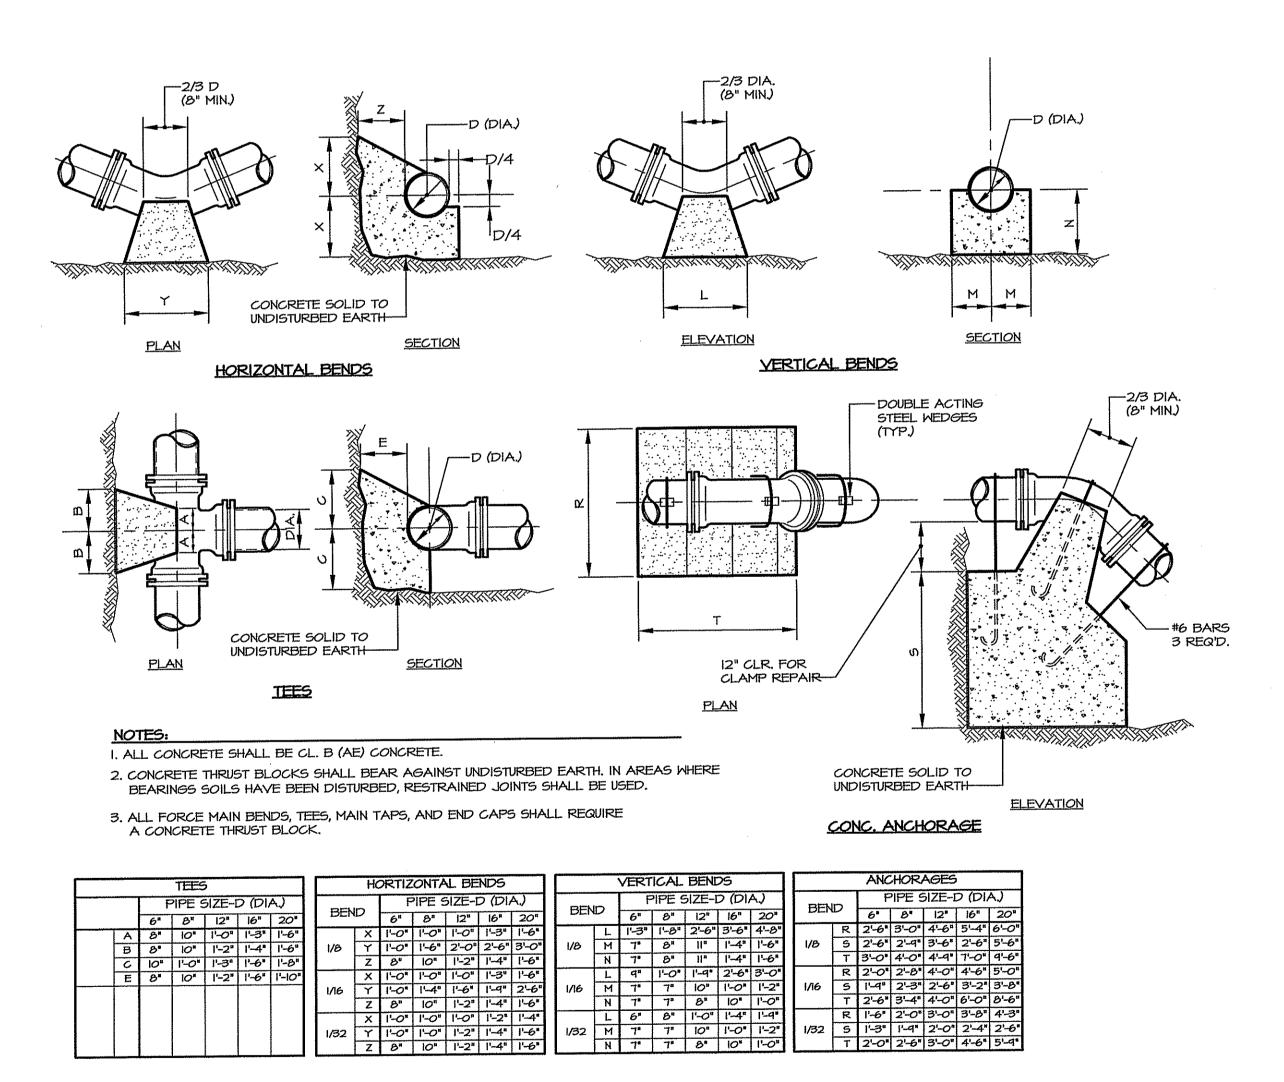



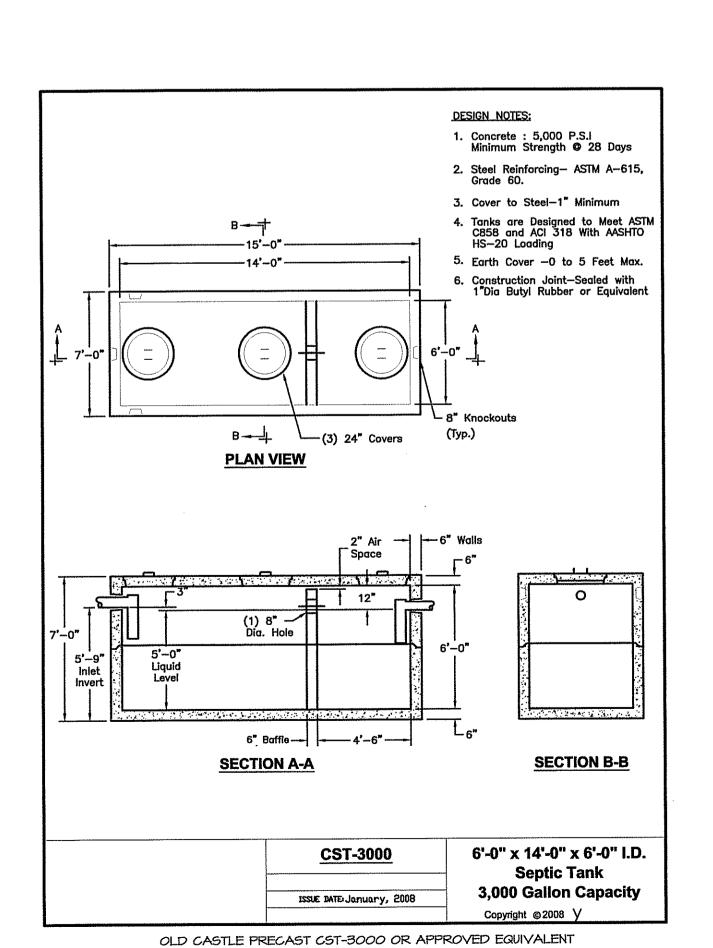

GREASE TRAP NOT TO SCALE


ARCHITECTURE INVOLUTION, 286 BOSTON POST ROAD WAYLAND, MA 01778 508-358-079I (F) AI3@AI-3.COM



NEW WOONSOCKET **MIDDLE SCHOOL** Woonsocket, RI

HAMLET AVENUE, FLORENCE DRIVE & **VILLA NOVA STREET**


ASSESSOR'S PLAT 27 LOTS 13, 24, 26, 62, 63, 77, 78, 81, 91, 165, & 170

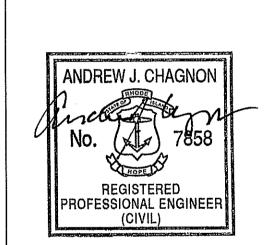

RIDEM SUBMISSION





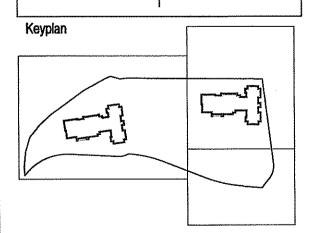

Drawing Name:

SITE DETAILS No.3

Scale: Not To Scale | Drawing Number:

APR 2 1 2008

DEPARTMENT OF ENVIRONMENTAL MANAGEMENT OFFICE OF WATER RESOURCES

FRESHWATER WETLANDS PROGRAM APPROVED WITH CONDITIONS

AS SPECIFIED IN THE LETTER OF APPROVAL

NO CHANGES ALLOWED WITHOUT PRIOR APPROVAL

APPROVED PLANS MUST BE AT CONSTRUCTION SITE

SEPTIC TAN

6'-0"x14'-0"x6'-0

3,000 GALLON CAPACIT

6'-0" x 14'-0' x 6'-0" I.D.

Septic Tank


3,000 Gallon Capacity


BOTTOM


CST-3000


ISSUE DATE January, 2008


OLD CASTLE PRECAST CST-3000 OR APPROVED EQUIVALENT

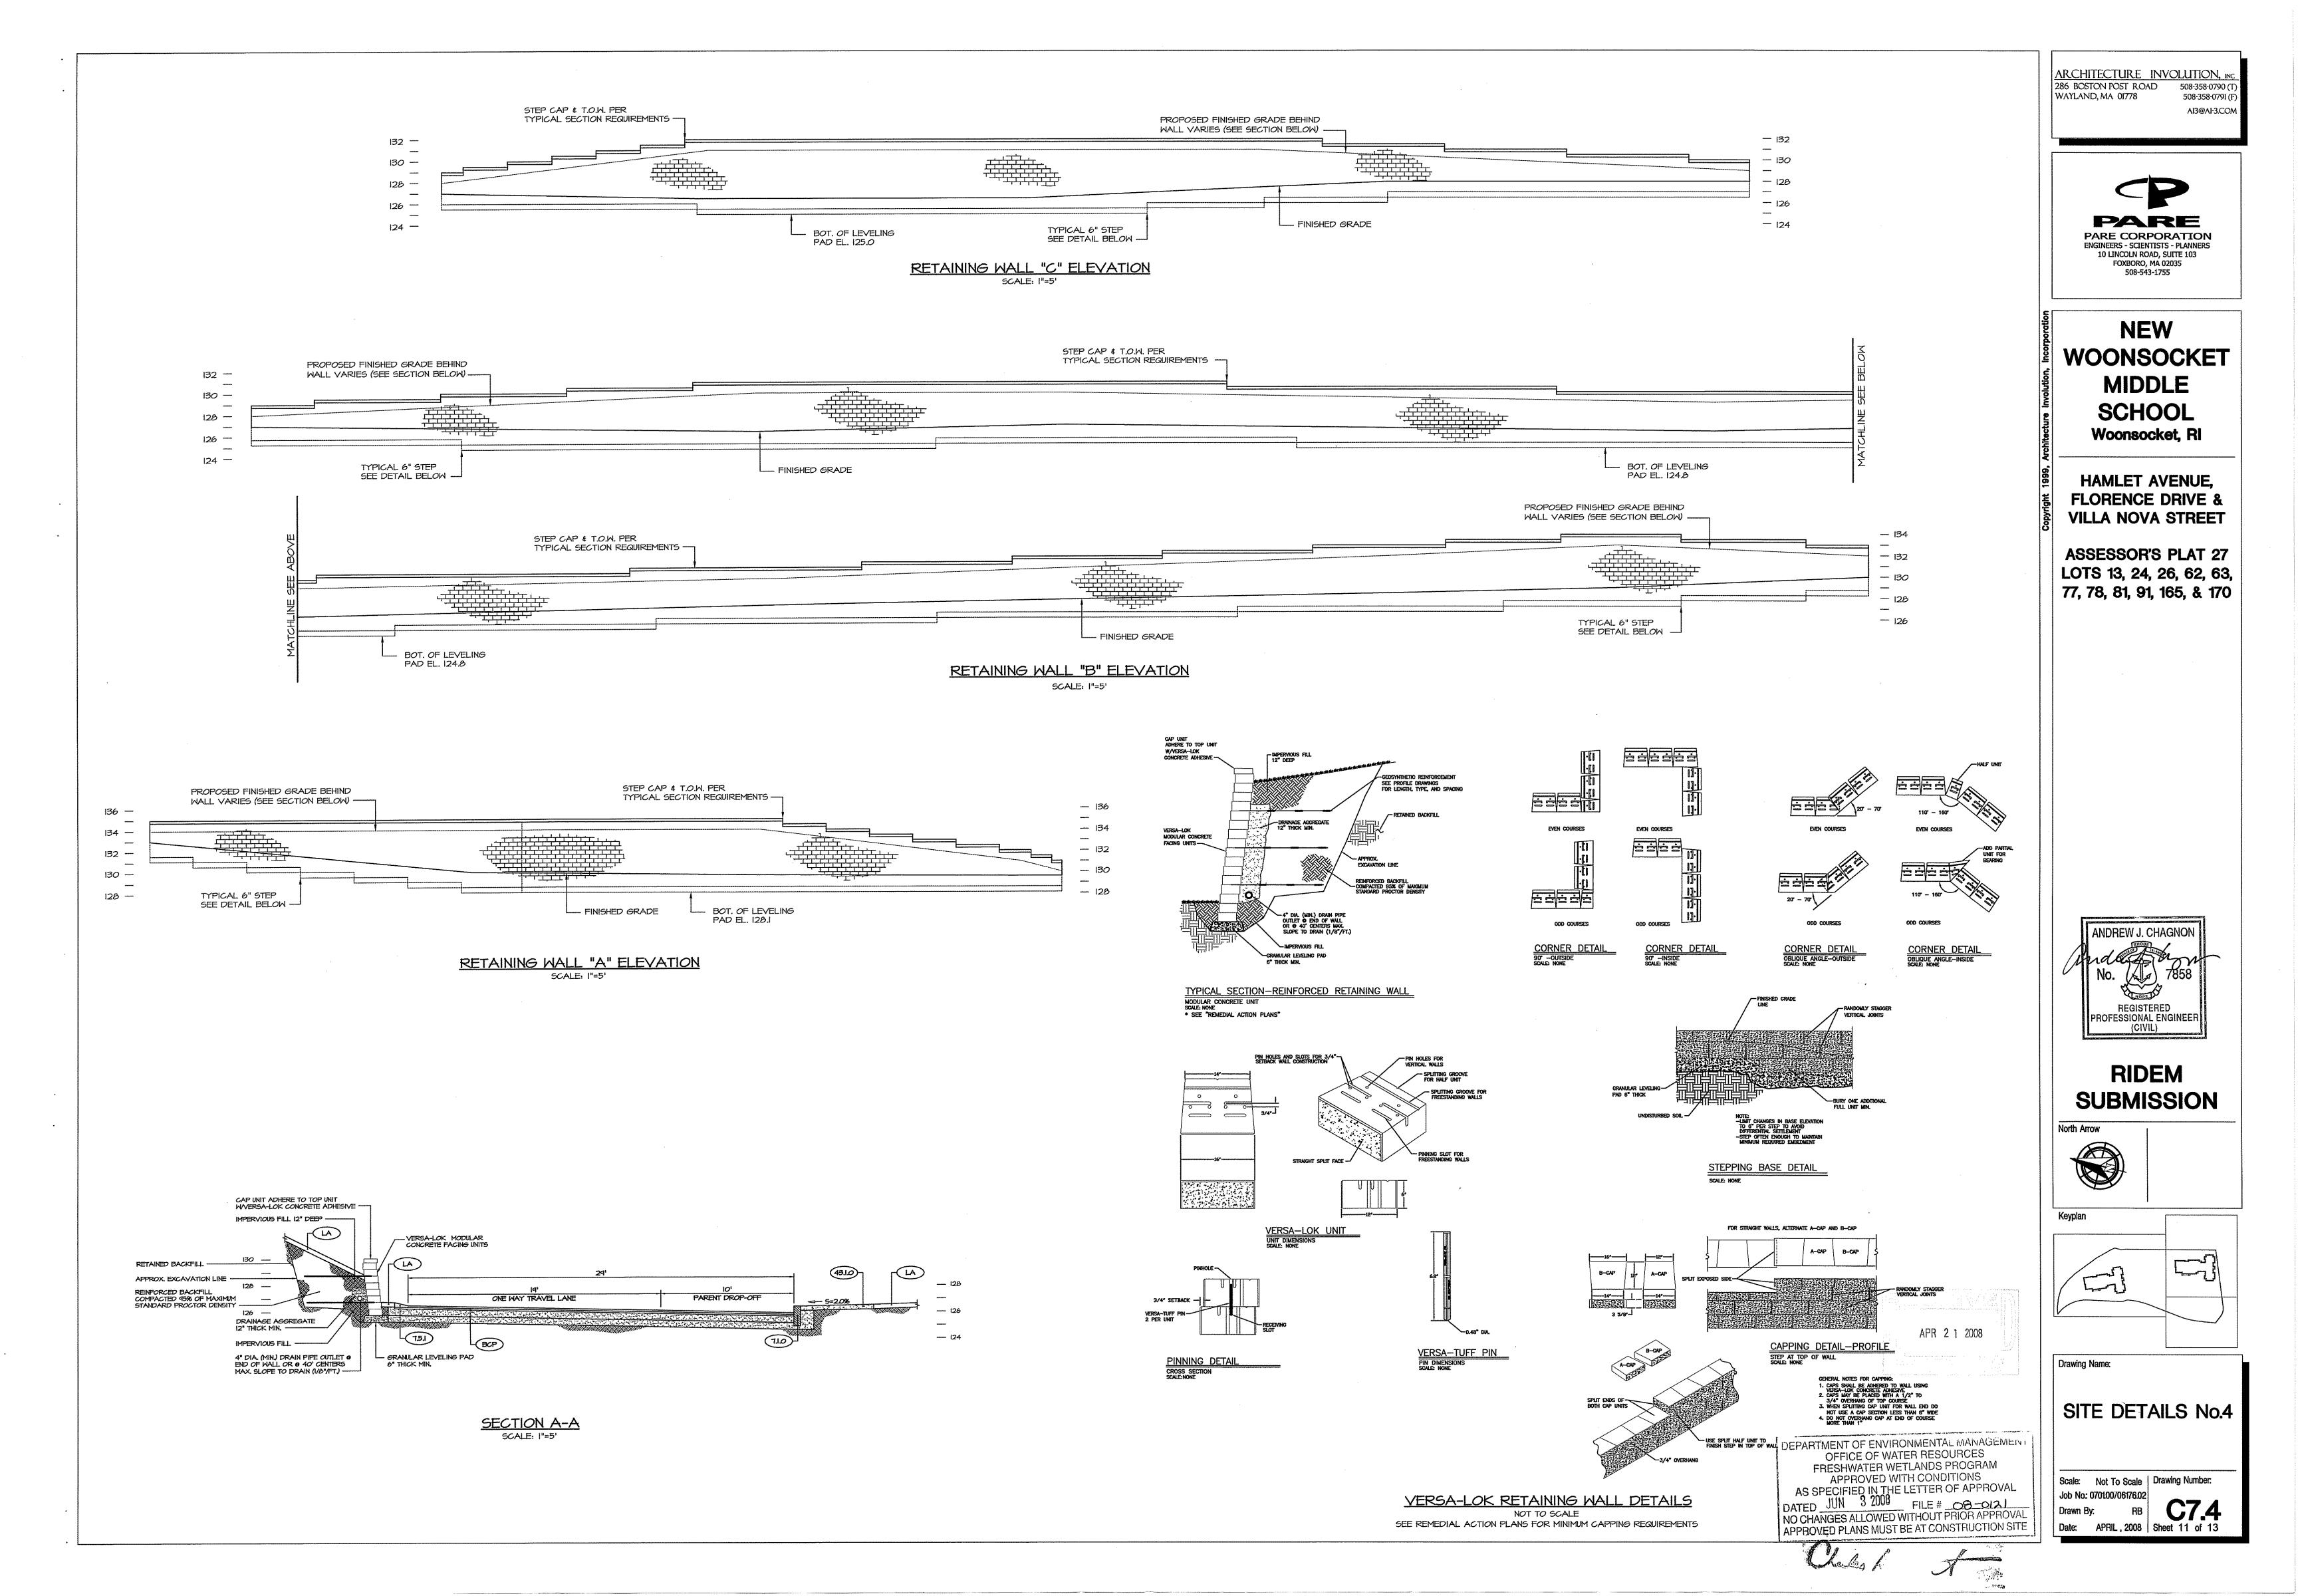


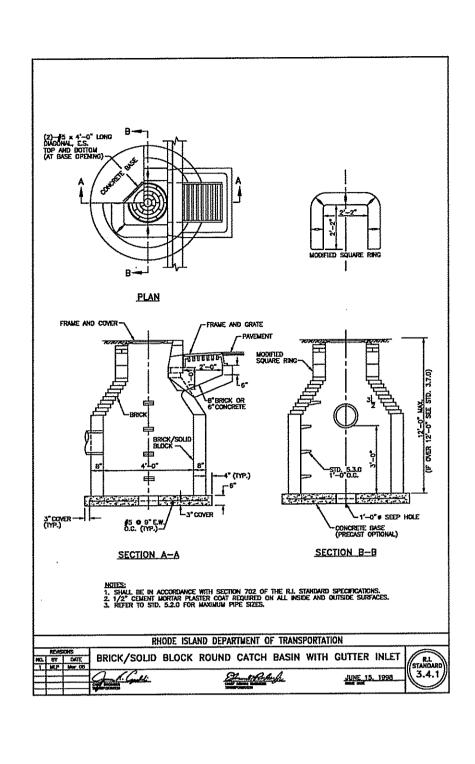

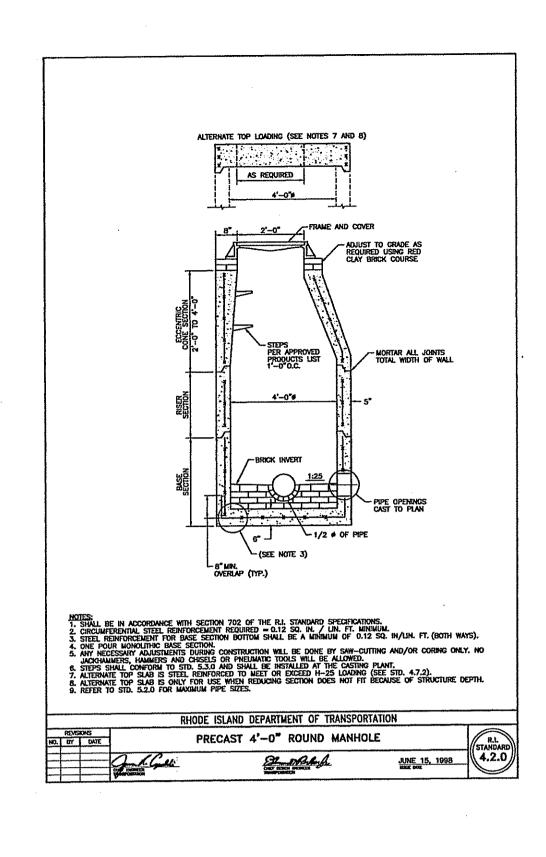

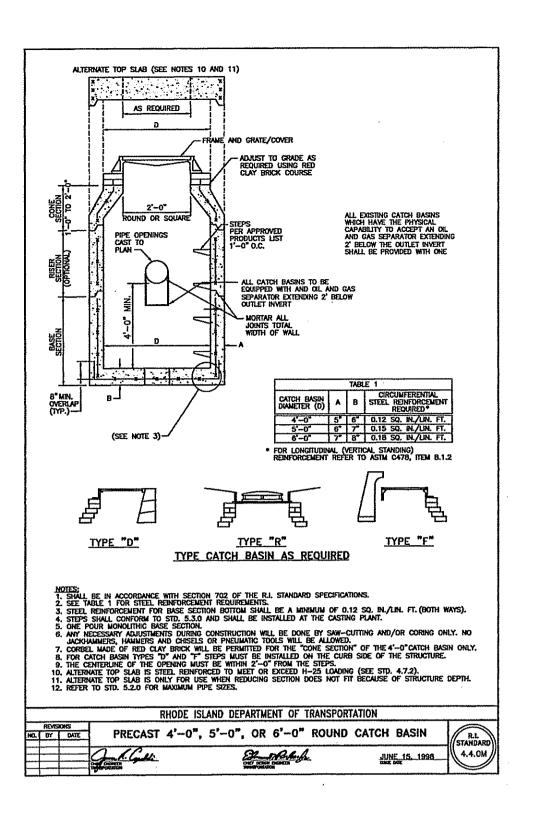

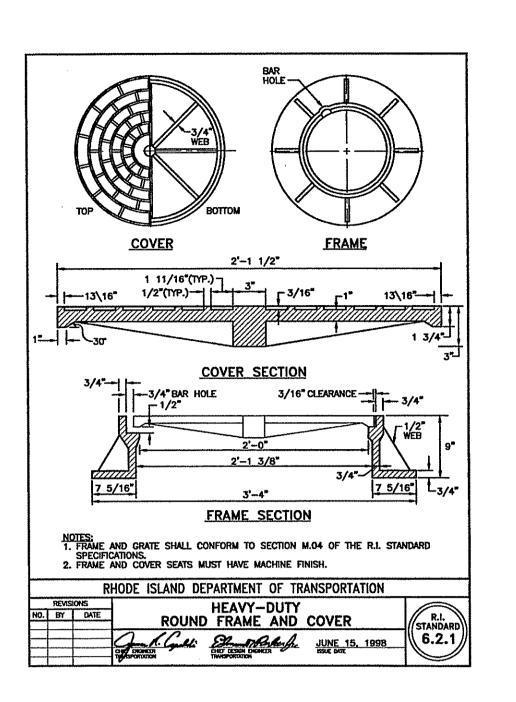

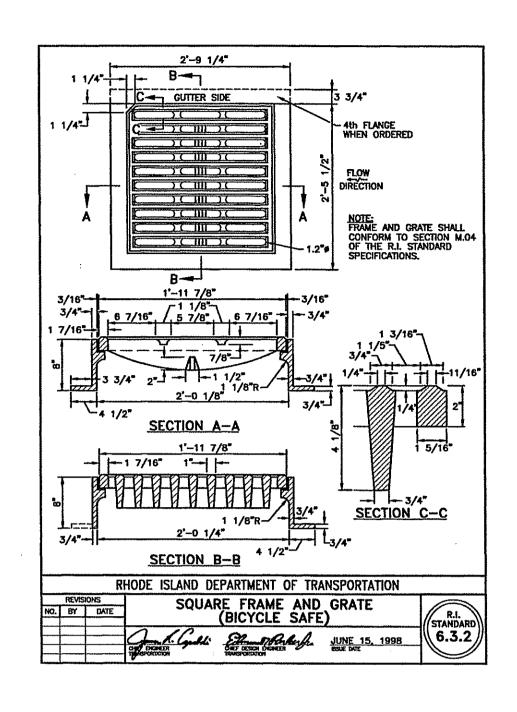



ARCHITECTURE INVOLUTION, IN


AI3@AI-3.COM

286 BOSTON POST ROAD WAYLAND, MA 01778

WOONSOCKET **MIDDLE** SCHOOL Woonsocket, RI


HAMLET AVENUE, FLORENCE DRIVE & **VILLA NOVA STREET**


ASSESSOR'S PLAT 27 LOTS 13, 24, 26, 62, 63, 77, 78, 81, 91, 165, & 170

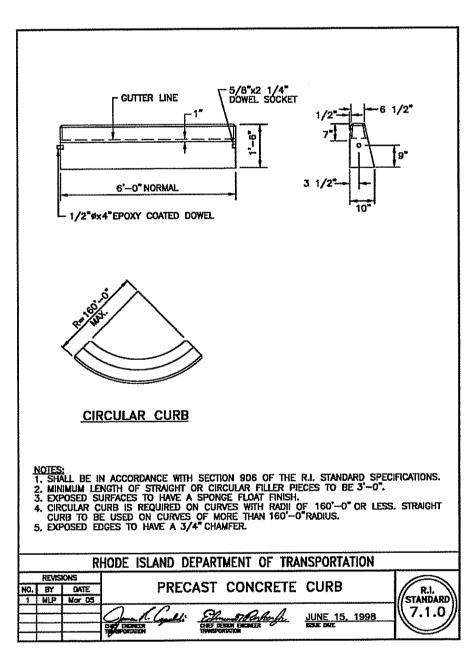



METAL CONNECTOR CABLE 1/8" ≠ (MIN.) —


2"x2"x4'--6"(MAX.)

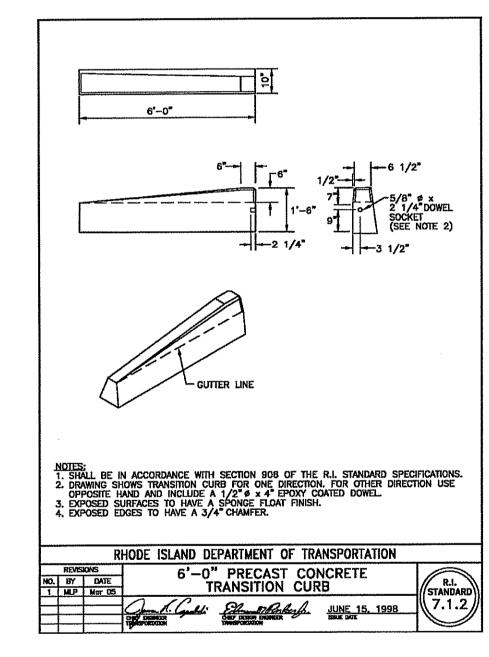

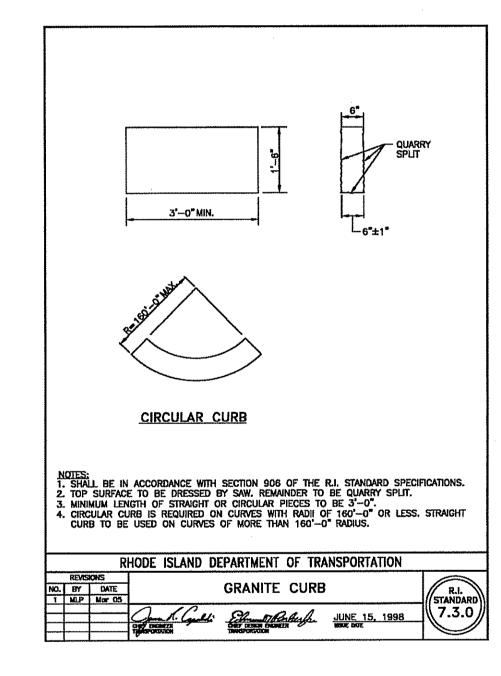


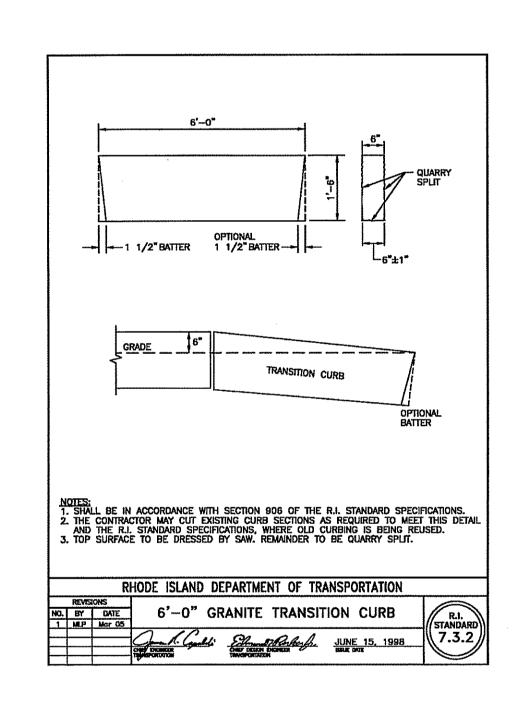


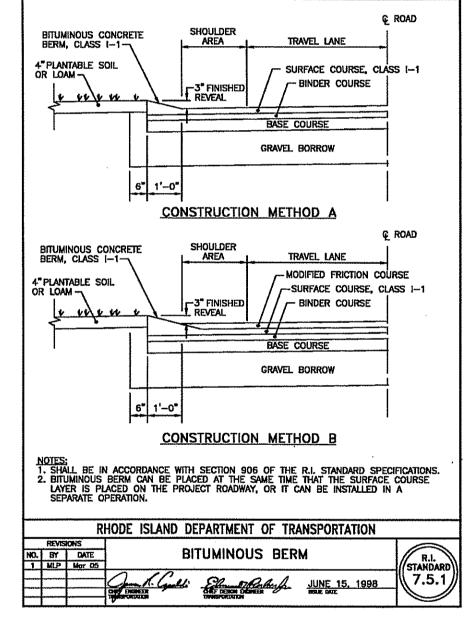


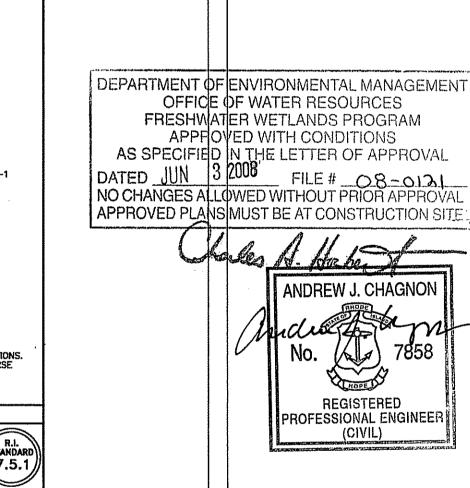



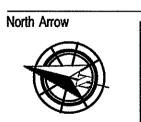

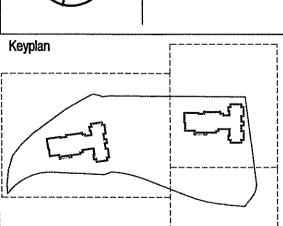


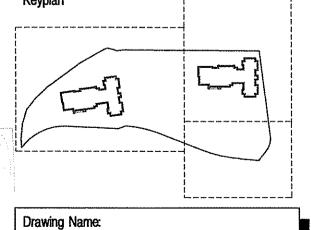



SITE DETAILS No.5


Scale: Not To Scale | Drawing Number: Job No.: 070100/06176.02


APRIL, 2008 | Sheet 12 of 13

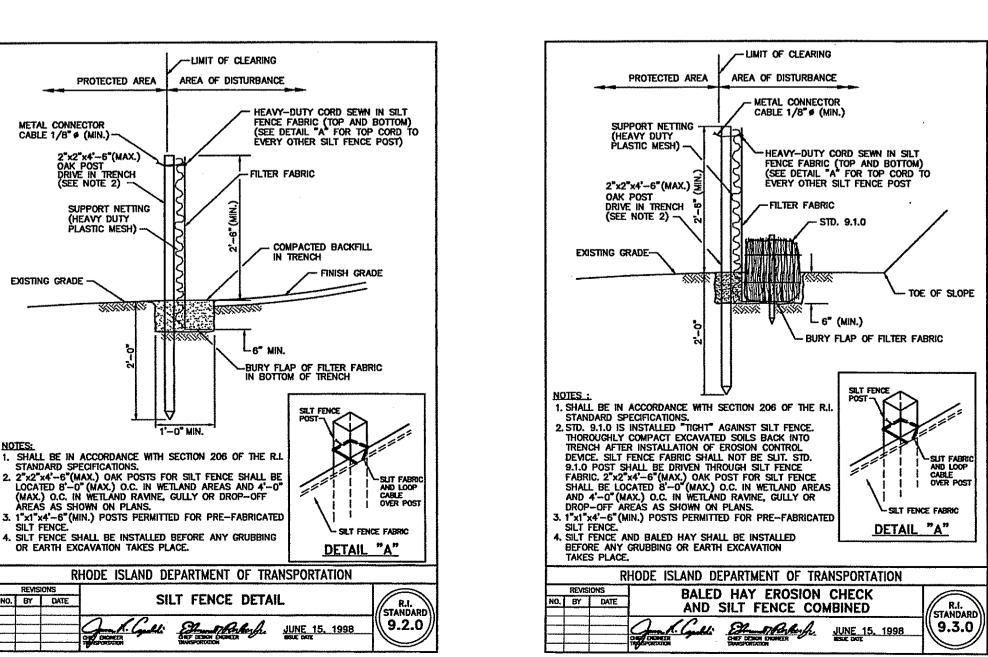


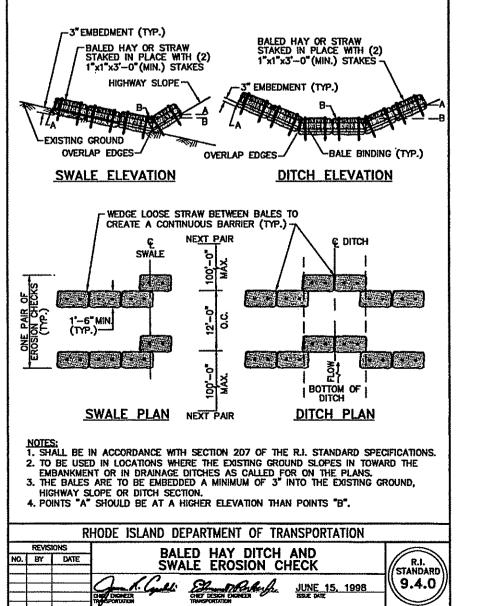


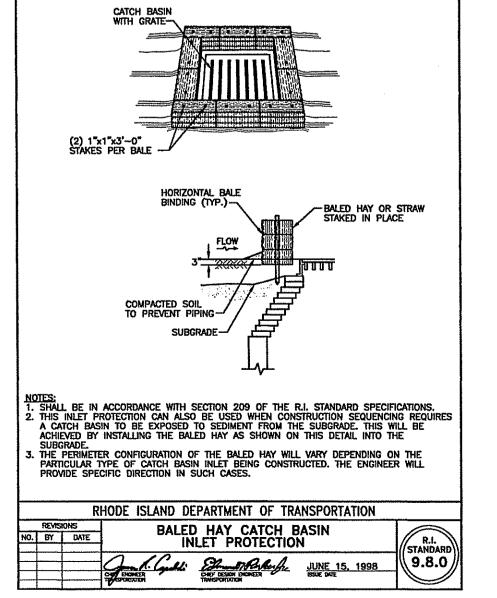


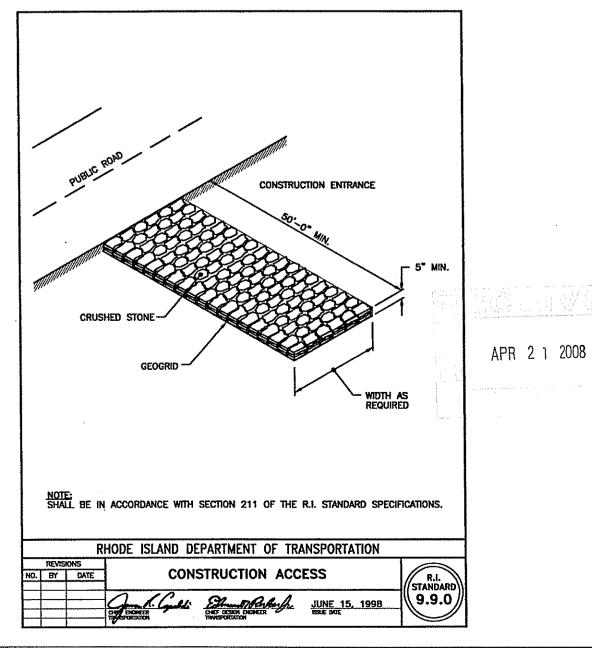


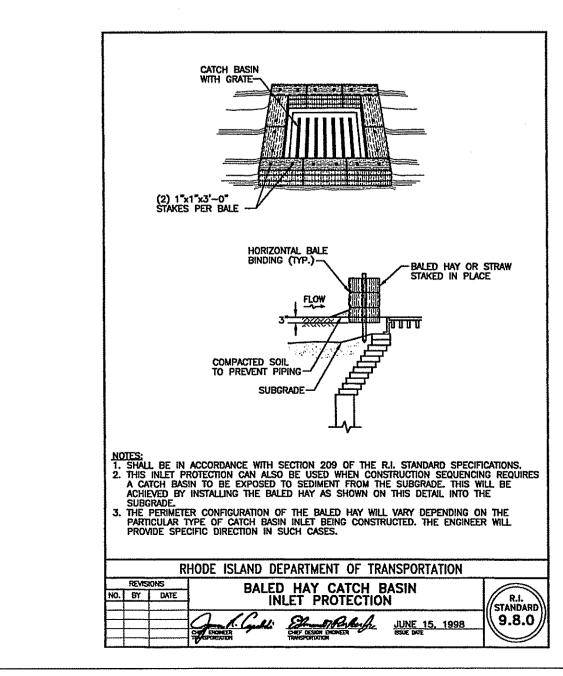


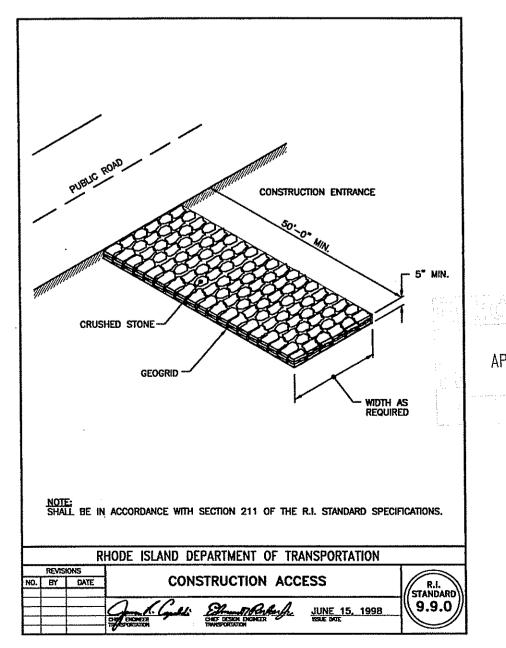


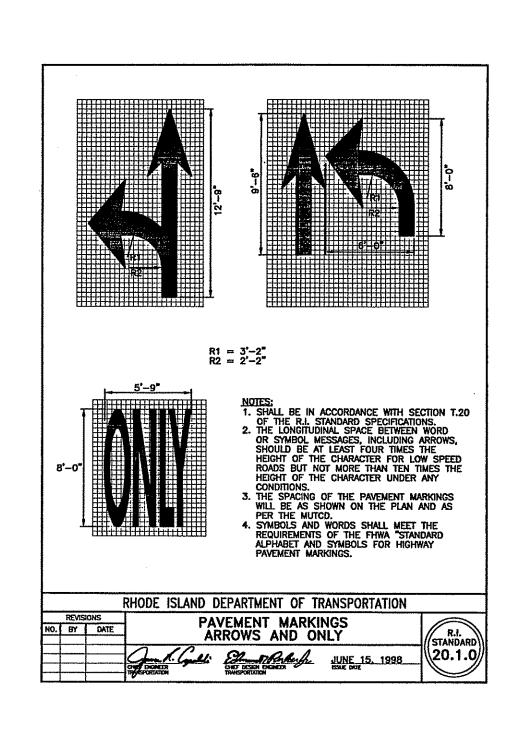


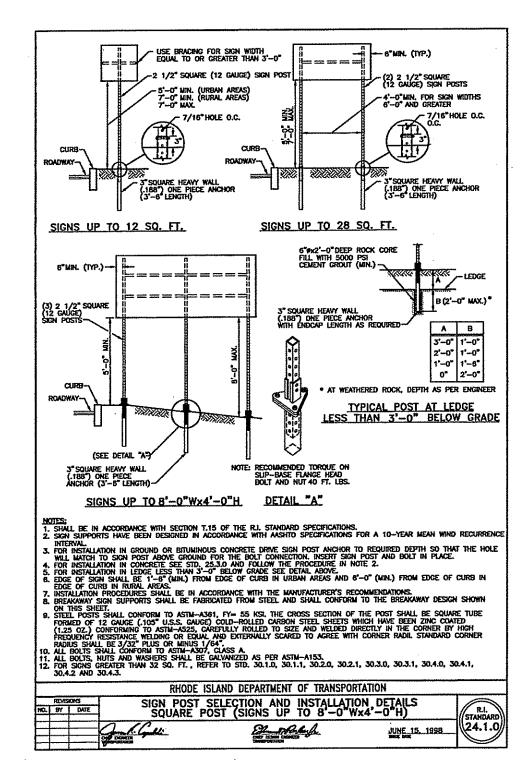

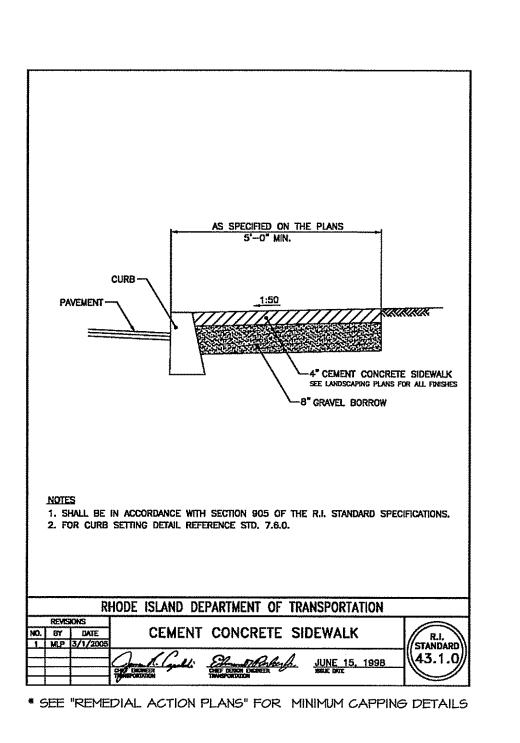

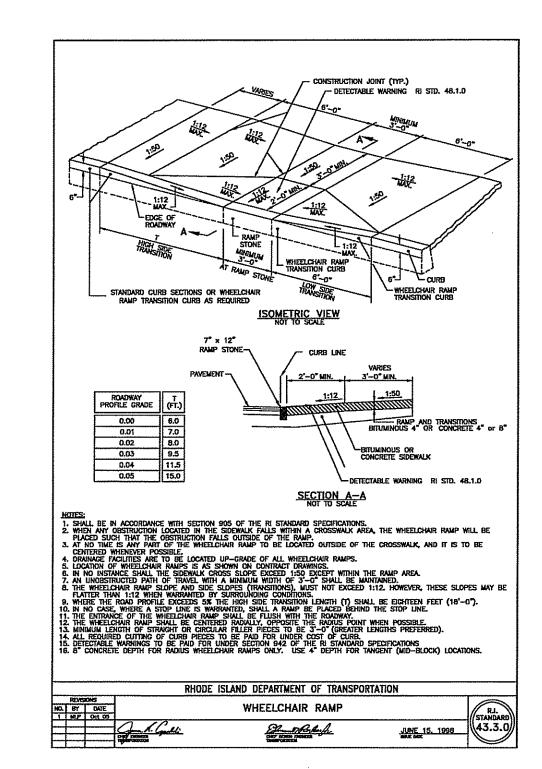

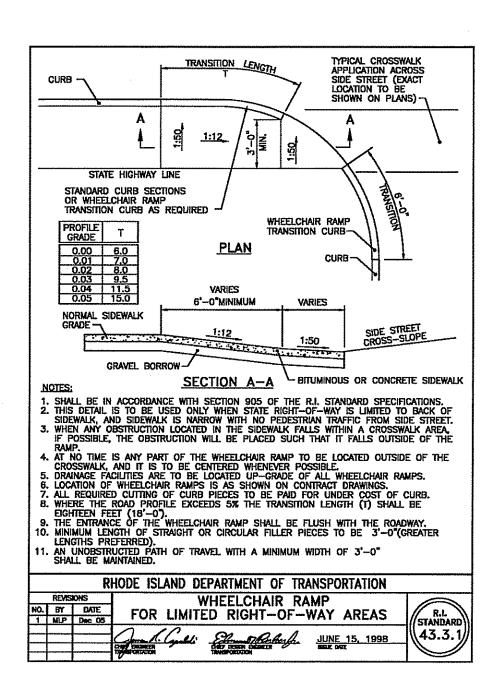

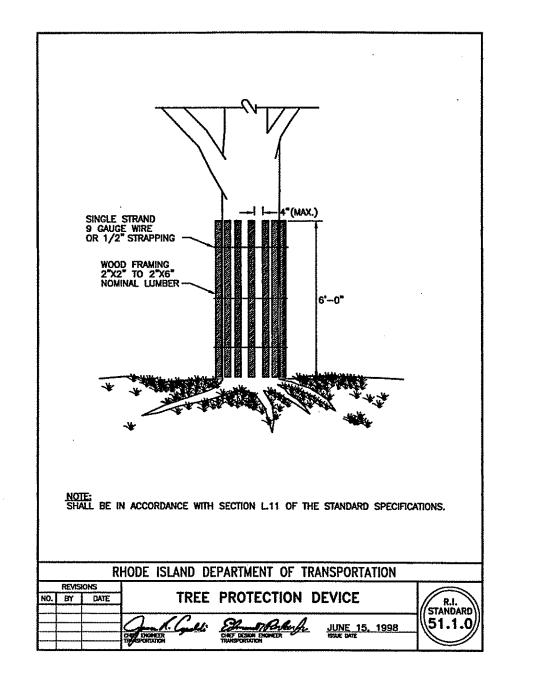


ARCHITECTURE INVOLUTION, INC 286 BOSTON POST ROAD 508-358-0790 (1 WAYLAND, MA 01778 508-358-0791 (F) Al3@Al-3.COM



NEW WOONSOCKET MIDDLE SCHOOL Woonsocket, RI

HAMLET AVENUE, FLORENCE DRIVE & **VILLA NOVA STREET**

ASSESSOR'S PLAT 27 LOTS 13, 24, 26, 62, 63, 77, 78, 81, 91, 165, & 170

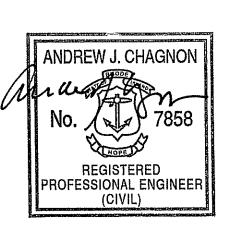

RIDEM SUBMISSION


DEPARTMENT OF ENVIRONMENTAL MANAGEMENT OFFICE OF WATER RESOURCES FRESHWATER WETLANDS PROGRAM

APPROVED WITH CONDITIONS AS SPECIFIED IN THE LETTER OF APPROVAL

DATED JUN 3 2008 FILE # _08-0121
NO CHANGES ALLOWED WITHOUT PRIOR APPROVAL

APPROVED PLANS MUST BE AT CONSTRUCTION SITE

APR 2 1 2008

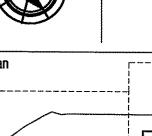

Keyplan

Drawing Name:

SITE DETAILS No.6

Scale: Not To Scale | Drawing Number: Job No: 0701.00/06176.02


Date: APRIL, 2008 | Sheet 13 of 13

APPROACH	DIRECTION	HOUSING		Φİ			Φ2			φЗ		FLASHIN
MINIMUM INTERVAL		1	10			10			10			OPERATIO
VEHICLE EXTENSION			2.4			2.6			2.4			
MAXIMUM I (FREE OPERATION)			10			31			30		<u> </u>	·
MAXIMUM 2 (NOT USED)						:						
YELLOW CLEARANCE				3.5			35			3		
RED CLEARANCE	1				-			1				
PEDESTRIAN WALK / CLEARANCE						4/27			4/26		<u> </u>	
											<u> </u>	
DAVISON AVENUE	NB	C, D	R	R	R	R	R	R	6	Y	R	FR
FLORENCE DRIVE	SB	H, I	R	R	R	R	R	R	6	Υ	R	FR
HAMLET AVENUE	EB-LT	E	(6 -	(- <u>-</u>	(R	(R	(R	(R-	⟨R	(R -	⟨R −	(FR-
HAMLET AVENUE	B	F, 6	6	Y@			Υ	R	R	R	R	FY
HAMLET AVENUE	MB	A, B	R	R	R	6	Y	R	R	R	R	FY
PEDESTRIAN CROSSING	N-5	PI, P4, P5, P8	DM	DM	DM	DM	DW	DM	WFDW	DM	DM	
PEDESTRIAN CROSSING	E-W	P2, P3, P6, P1	DM	DM	DM	WFDW	DM	DW	DM	DM	DM	
								-1-				
DETECTOR			NO	N - LC	<u>ck</u>	NO	N - LC	OK_	NO	N - LC		4
RECALL.				OFF		<u> </u>	SOFT		<u> </u>	SOFT	·····	-
				Φl			φ2			φЗ		4
			1			€	1	ı	₩	ı	ı	
				Ш					1	الـا	1	
SHING OPERATION PER MU.T.												

	• • • • • • • • • • • • • • • • • • • •	Ø 3
PHASE_	SEQUENCE	DIAGRA

		TRAFFIC SIGNAL LEGEND	
No.	SYMBOL	DESCRIPTION	QUANTITY
l a	-	ELECTRIC HANDHOLES-TYPE A-PRECAST, R.I. STD. 1820	EA
2 ae	N/A	2 INCH POLYVINYL CHLORIDE PLASTIC CONDUIT - OVERHEAD	LF
20		3 INCH POLYVINYL CHLORIDE PLASTIC CONDUIT (SCHEDULE 40) - UNDERGROUND	LF
2 k		3 INCH POLYVINYL CHLORIDE PLASTIC CONDUIT (SCHEDULE 40) - UNDER EXISTING PAVEMENT	LF
20		3 INCH POLYVINYL CHLORIDE PLASTIC CONDUIT (SCHEDULE 80) - UNDER EXISTING PAVEMENT	LF
		2 INCH RIGID STEEL CONDUIT - UNDERGROUND	LF
2 q 2 v	N/A	2 INCH RIGID STEEL CONDUIT - OVERHEAD	LF
3 b	×	ACTUATED CONTROLLER TS-2, TYPE! W6 PHASE ASSEMBLY GROUND MOUNTED INCLUDING FOUNDATION AND SIZE "P" CABINET STD IN.LO	EA
3 f	N/A	METER SOCKET W MANUAL BYPASS	EA
40	10/4	40 FOOT GAL. STEEL MAST ARM TRAFFIC SIGNAL POST AND FOUNDATION STD. 19.2.0	EA
4 h		DIAL MAST ARM (30x40) GAL STEEL TRAFFIC SIGNAL POST AND FOUNDATION STD 19.2.0	EA
41		TRAFFIC SIGNAL STANDARD, & FOOT, ALIMINUM PEDESTAL POLE AND FOUNDATION STD 19.4.0	EA
		I WAY 3 SECTION MAST ARM MOUNTED SIGNAL HEAD 12 INCH	EA
61		2 WAY PEDESTAL MOUNTED L.E.D. PEDESTRIAN SIGNAL HEAD 12 INCH	EA
6 r		I WAY PEDESTAL MOUNTED L.E.D. PEDESTRIAN SIGNAL HEAD 12 INCH	EA
6.5 6.t		I WAY BRACKET MOUNTED L.E.D. PEDESTRIAN SIGNAL HEAD 12 INCH	EA
	N/A	6 AWS SINGLE CONDUCTOR CABLE 600V INSULATION	LF
<u>7a</u>	N/A	14 AWS 2 CONDUCTOR TWISTED SHIELDED CABLE	LF
76		14 ANG 3 CONDUCTOR CABLE	LF ·
<u> 7 d</u>	N/A	14 AWG 5 CONDUCTOR CABLE	LF
70	N/A	14 ANG 7 CONDUCTOR CABLE	LF
7 #	N/A	TRAFFIC DETECTOR-LOOP STD. 19.6.0A	T TE
<u>9a</u>		TRAFFIC DETECTOR RELAY - LOOP 4 CHANNEL	EA
90	N/A		EA
9 d	N/A	PEDESTRIAN DETECTOR - PUSH-BUTTON WITH SIGN	


	HAMLET A	1 L-3 T		, —					'					RE-EM		
	APPROACH	DIRECTION	HOUSING		ΦI			Φ2			φЗ		1 11 425 1	Φ4		FLASH
1	MINIMUM INTERVAL:	DINLOTION	100010	6	<u> </u>		6			6						OPERAT
	VEHICLE EXTENSION			2.7			2.7			2.6			2.8			
	MAXIMUM I (FREE OPERATION)			17			20			20			30			
'	MAXIMUM 2 (NOT USED)			<u>-</u>												
	YELLOW CLEARANCE				4			4			35			4		
	RED CLEARANCE	<u> </u>			·				ī			1			1	
	PEDESTRIAN WALK / CLEARANCE	1					4/16			4/16						
	PEDESTRIANTIVER / OLEMONOL															
	CUMBERLAND STREET	NB-LT	A	(6 -	(Y -	(R	(R	(R-	(R	(R -	(R -	(R -	(€–	¥	(R	₹
.	CUMBERLAND STREET	NB	B, C	6	70		6	Y	R	R	R	Ŋ	6	Υ	R	F
	CUMBERLAND STREET	SB	D, E	R	R	R	6	۲	R	R	R	R	R	R	R	F
•	HAMLET AVENUE	EB	F. 6	6	Υ.	R	R	R	R	6	~	ĸ	R	R	R	FF
	PEDESTRIAN CROSSING	N-5	Pl, P2	DM	DM	DM	WFDW	DW	DW	DM	Σ	DW	DM	DM	DM	
	PEDESTRIAN CROSSING	E-W	P3 - P6	DM	DM	DM	DM	DW	DM	WITDW	DM	DM	DM	DM	DW	<u> </u>
	1 201011010101010															
	DETECTOR			NO	N - LO	CK	NO	N - LC	XX	NO	N - LO	CK		LOCK		1
	RECALL			OFF				MIN		OFF		MIN				
				φ1 φ2				43			04			1		
										_			100			1
				1	1	1	₩.	1	1	₩	li i	- 1	ישר ו	- liù	- 1	l
SI	HING OPERATION PER MU.T.	C.D. SECTION	ON 4D.12.	l		- 1	 	[- 1		11.				- 1 .	1
				1 —		- 1	1	î			, `	1	1		1.	1
BE	GREEN IF PHASE 2 IS NEXT.								- 1		᠋.			=		
	GIGNAL EQUIPMENT AND LOOPSHALL REMAIN.	S ARE EXIS	TING	_	7	111		<u> </u>	111		7	TÎ			111	
	NTERCONNECTION TIMING INFO	RMATION F	EFER TO	<u> </u>			<u> </u>			<u> </u>			<u> </u>	***************************************		J

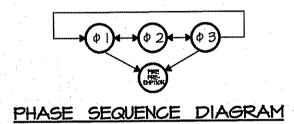


T4)65707090

	DE	TECT	OR I	OATA		
DETECTOR No.	No. SECTION / SIZE	RELAY NUMBER	SLOT	DELAY (SEC)	PHASE	REMARKS
1	1 - 6' x 40'	ı	2	5	3	PROPOSED
2	1-6' x 40'		2	3	3	PROPOSEI
3	1-6' x 40'		2	3	2	PROPOSEI
4	1-6' x 40'	I I	2	3	2	PROPOSEI
5	1-6' x 40'	2	4	. 3	3	PROPOSEI
	1-6' x 40'	2	4	3	2	PROPOSEI
7	1 - 6' x 40'	2	4	3	1	PROPOSEI

- ALL TRAFFIC SIGNAL EQUIPMENT, CONDUIT, WIRING, AND ASSOCIATED MATERIAL SHALL
 CONFORM TO PART T OF THE LATEST EDITION OF THE RHODE ISLAND DEPARTMENT OF
 TRANSPORTATION STANDARD SPECIFICATIONS FOR ROAD AND BRIDGE CONSTRUCTION.
- 3. ALL RED, YELLOW, AND GREEN SIGNAL DISPLAYS SHALL BE EQUIPPED WITH LED MODULES.
- 4. ALL TRAFFIC SIGNAL HEADS SHALL BE FURNISHED WITH BACK PLATES AS SHOWN.
- 5. THE PEDESTRIAN SIGNAL HEADS SHALL BE SOLID L.E.D. SYMBOLS.
- 6. FOR INTERCONNECTION TIMING INFORMATION, REFER TO DRAWING NUMBER CB.2.

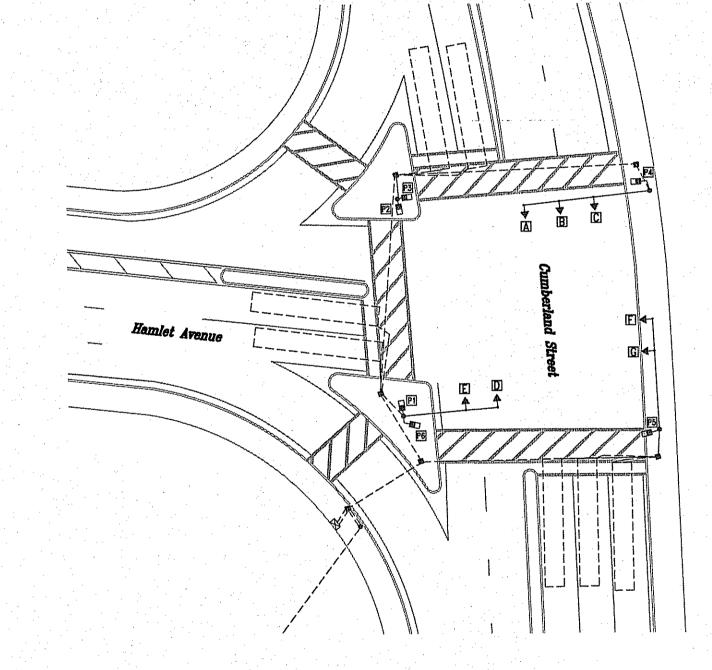

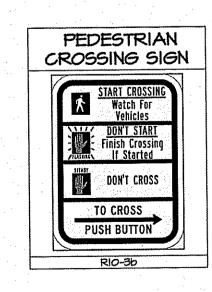

TWO SECTION

	PLAN NO	MONDAY THRU FRIDAY	SATURDAY	SUNDAY
AM PEAK	.	0600-1000		-
PM PEAK	2	1400-2000		
		0000-0600		
OPERATION		1000-1400		
OF LEVELION	*	2000-2400	0000-2400	0000-240

I. PEAK HOUR INFORMATION APPLIES TO BOTH INTERSECTIONS. FOR INTERCONNECTION PLAN DETAILS REFER TO DRAWING NUMBER CO.2.

APR 2 1 2008

ARCHITECTURE INVOLUTION, INC 286 BOSTON POST ROAD WAYLAND, MA 01778




NEW WOONSOCKET **MIDDLE** SCHOOL Woonsocket, RI


HAMLET AVENUE, FLORENCE DRIVE & VILLA NOVA STREET

ASSESSOR'S PLAT 27 LOTS 13, 24, 26, 62, 63, 77, 78, 81, 91, 165, & 170

RIDEM SUBMISSION



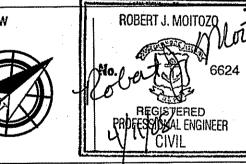


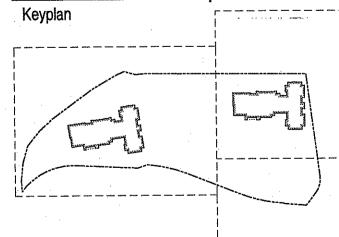

Drawing Name:

TRAFFIC SIGNAL PLAN

1'=30' | Drawing Number:

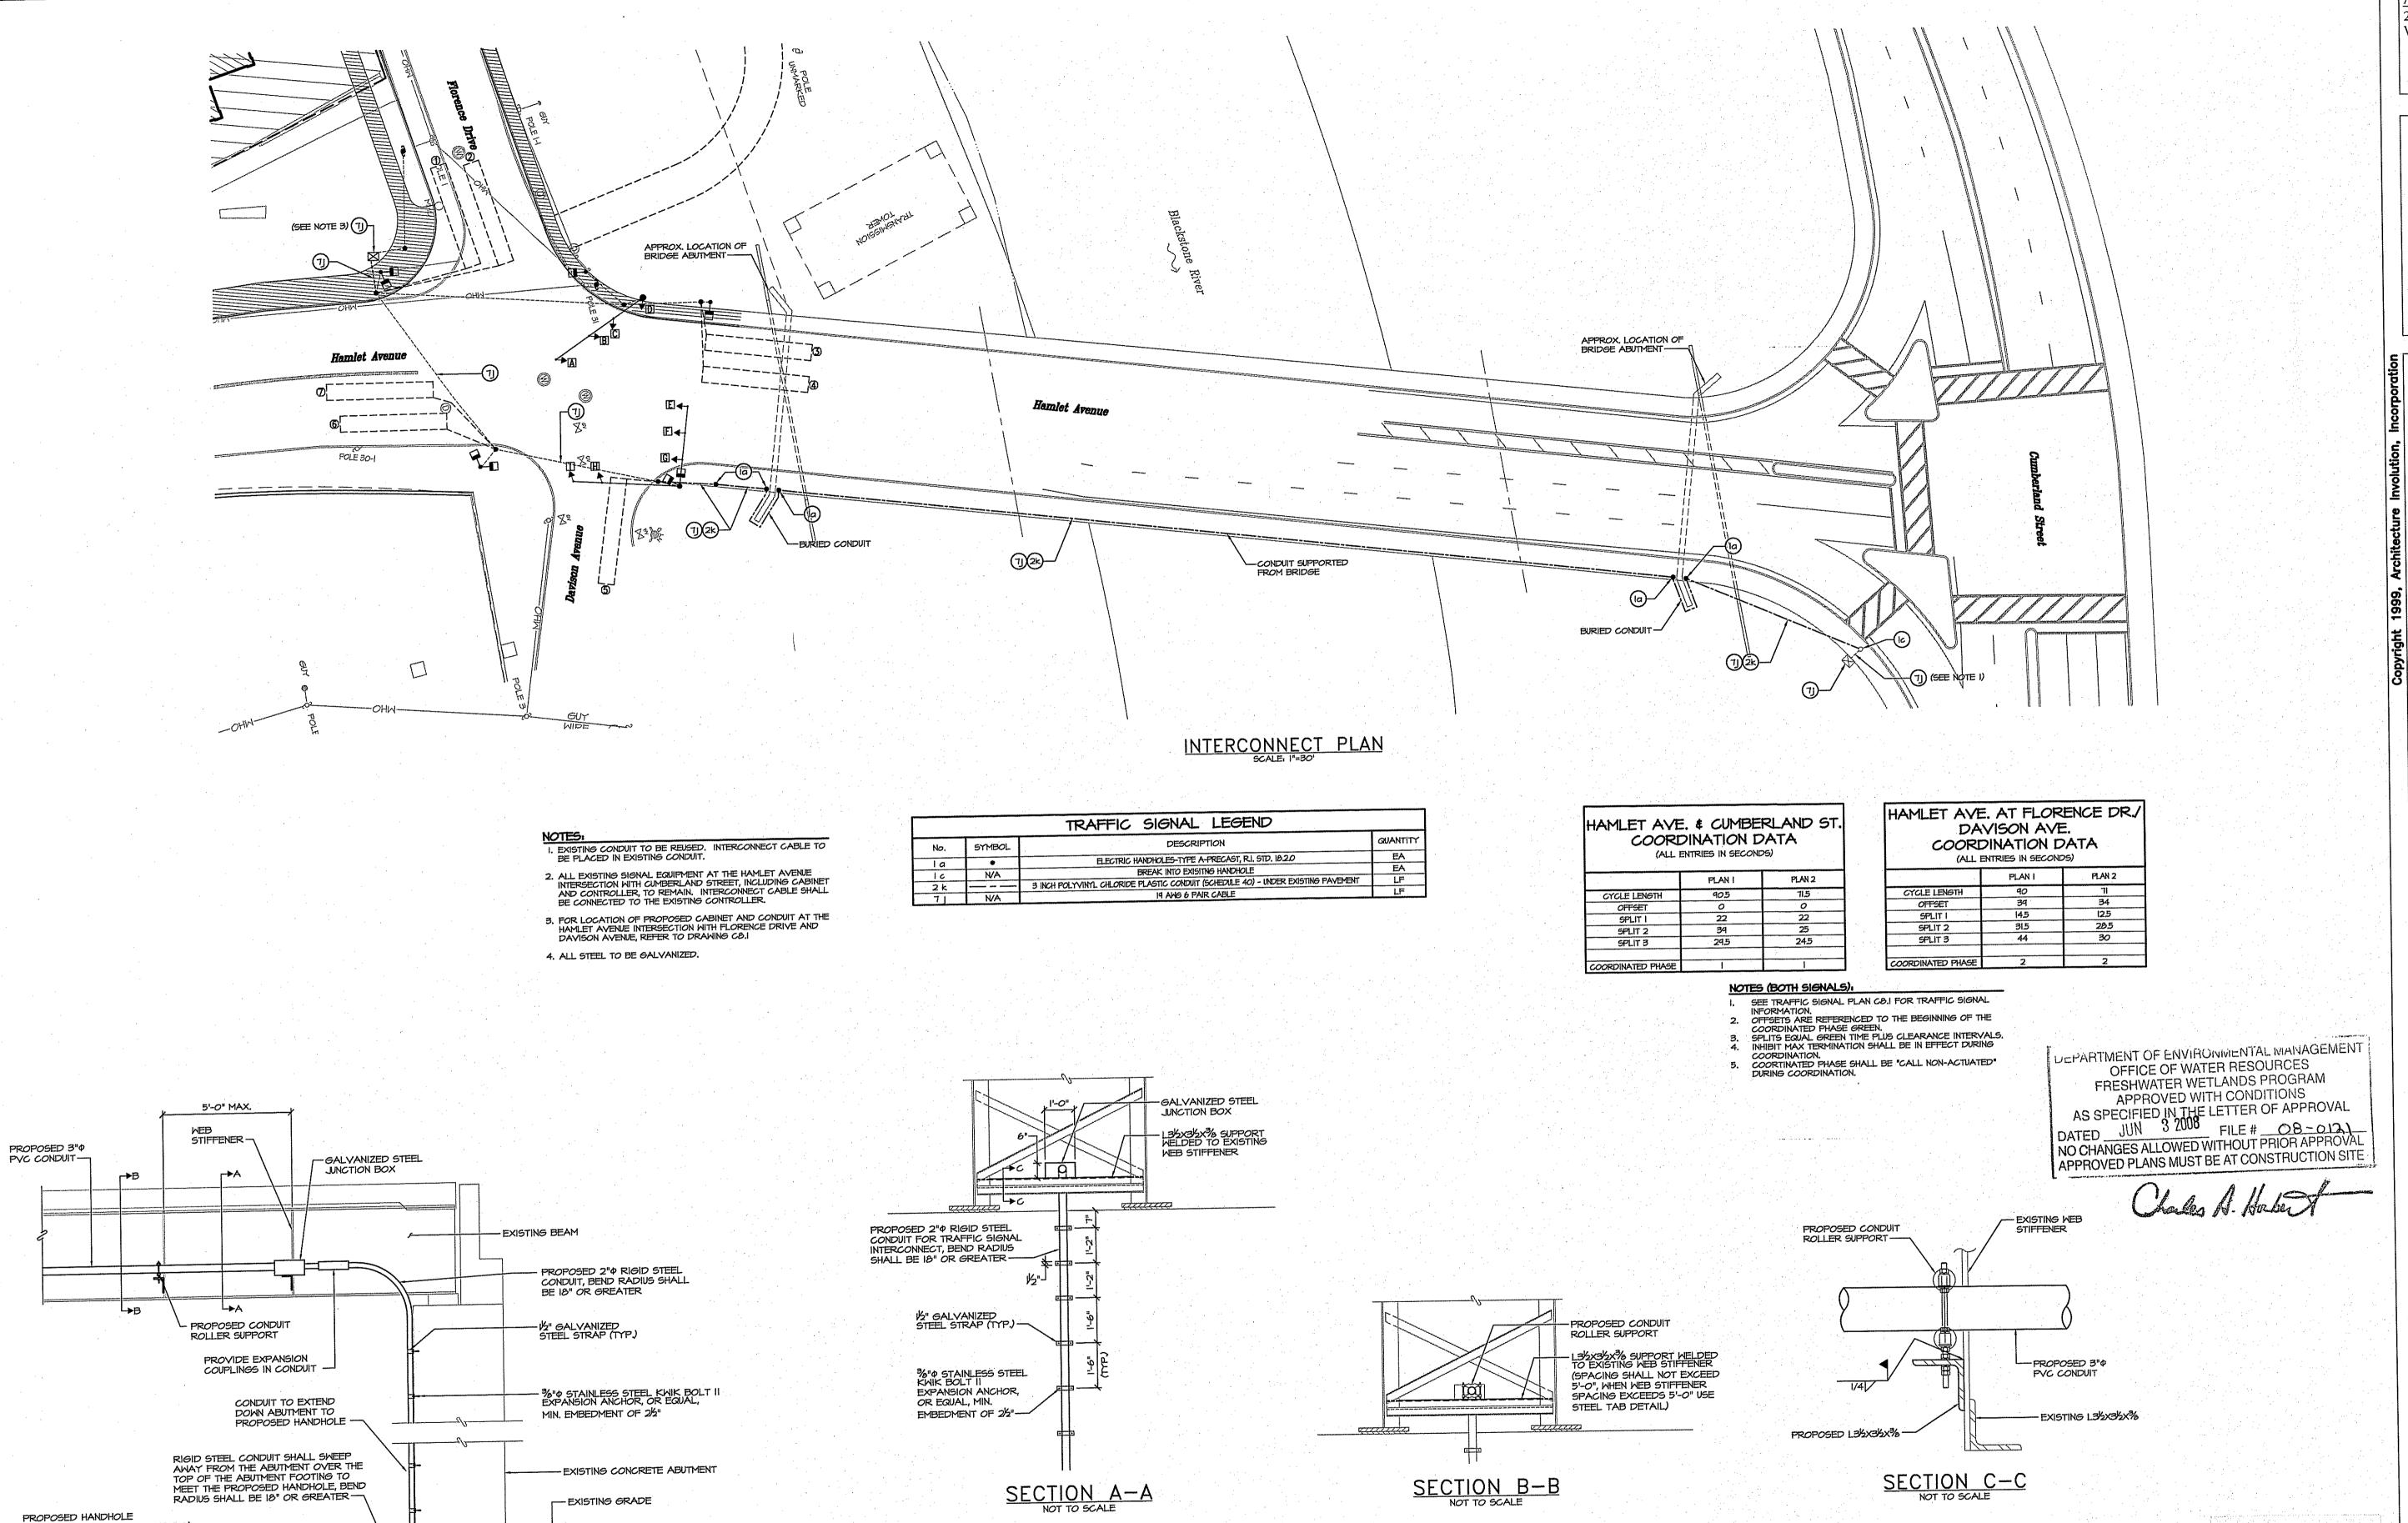

I. 3" POLYVINYL CHLORIDE PLASTIC CONDUIT (PVC) SHALL CONFORM TO SECTION T.06 OF THE RHODE ISLAND STANDARD SPECIFICATIONS FOR ROAD AND BRIDGE CONSTRUCTION.

2" RIGID STEEL CONDUIT AND FITTINGS SHALL CONFORM TO SUBSECTION MIS.04 OF THE RHODE ISLAND STANDARD SPECIFICATIONS FOR ROAD AND BRIDGE CONSTRUCTION.

3. GALVANIZED STEEL JUNCTION BOXES ARE TO BE FURNISHED AND INSTALLED ACCORDING TO THE LATEST RIDOT CODES AND SPECIFICATIONS.

(TYP. A-PRECAST, R.I. STD. 18.2.0) -

TYPICAL ABUTMENT

- EXISTING FOOTING

ARCHITECTURE INVOLUTION, INC 286 BOSTON POST ROAD WAYLAND, MA 01778 508-358-0791 (F -AI3@AI-3.COM



508-543-1755

NEW WOONSOCKET **MIDDLE** SCHOOL Woonsocket, RI

HAMLET AVENUE, FLORENCE DRIVE & **VILLA NOVA STREET**

ASSESSOR'S PLAT 27 LOTS 13, 24, 26, 62, 63, 77, 78, 81, 91, 165, & 170

RIDEM SUBMISSION



Keyplan

L...

Drawing Name:

APR 2 1 2008

PROPOSED 5"x8"x2" STEEL TAB -


---EXISTING GIRDER

STEEL TAB DETAIL NOT TO SCALE

PROPOSED L35X35X36 -

TRAFFIC SIGNAL INTERCONNECT PLAN AND DETAILS

AS NOTED | Drawing Number:

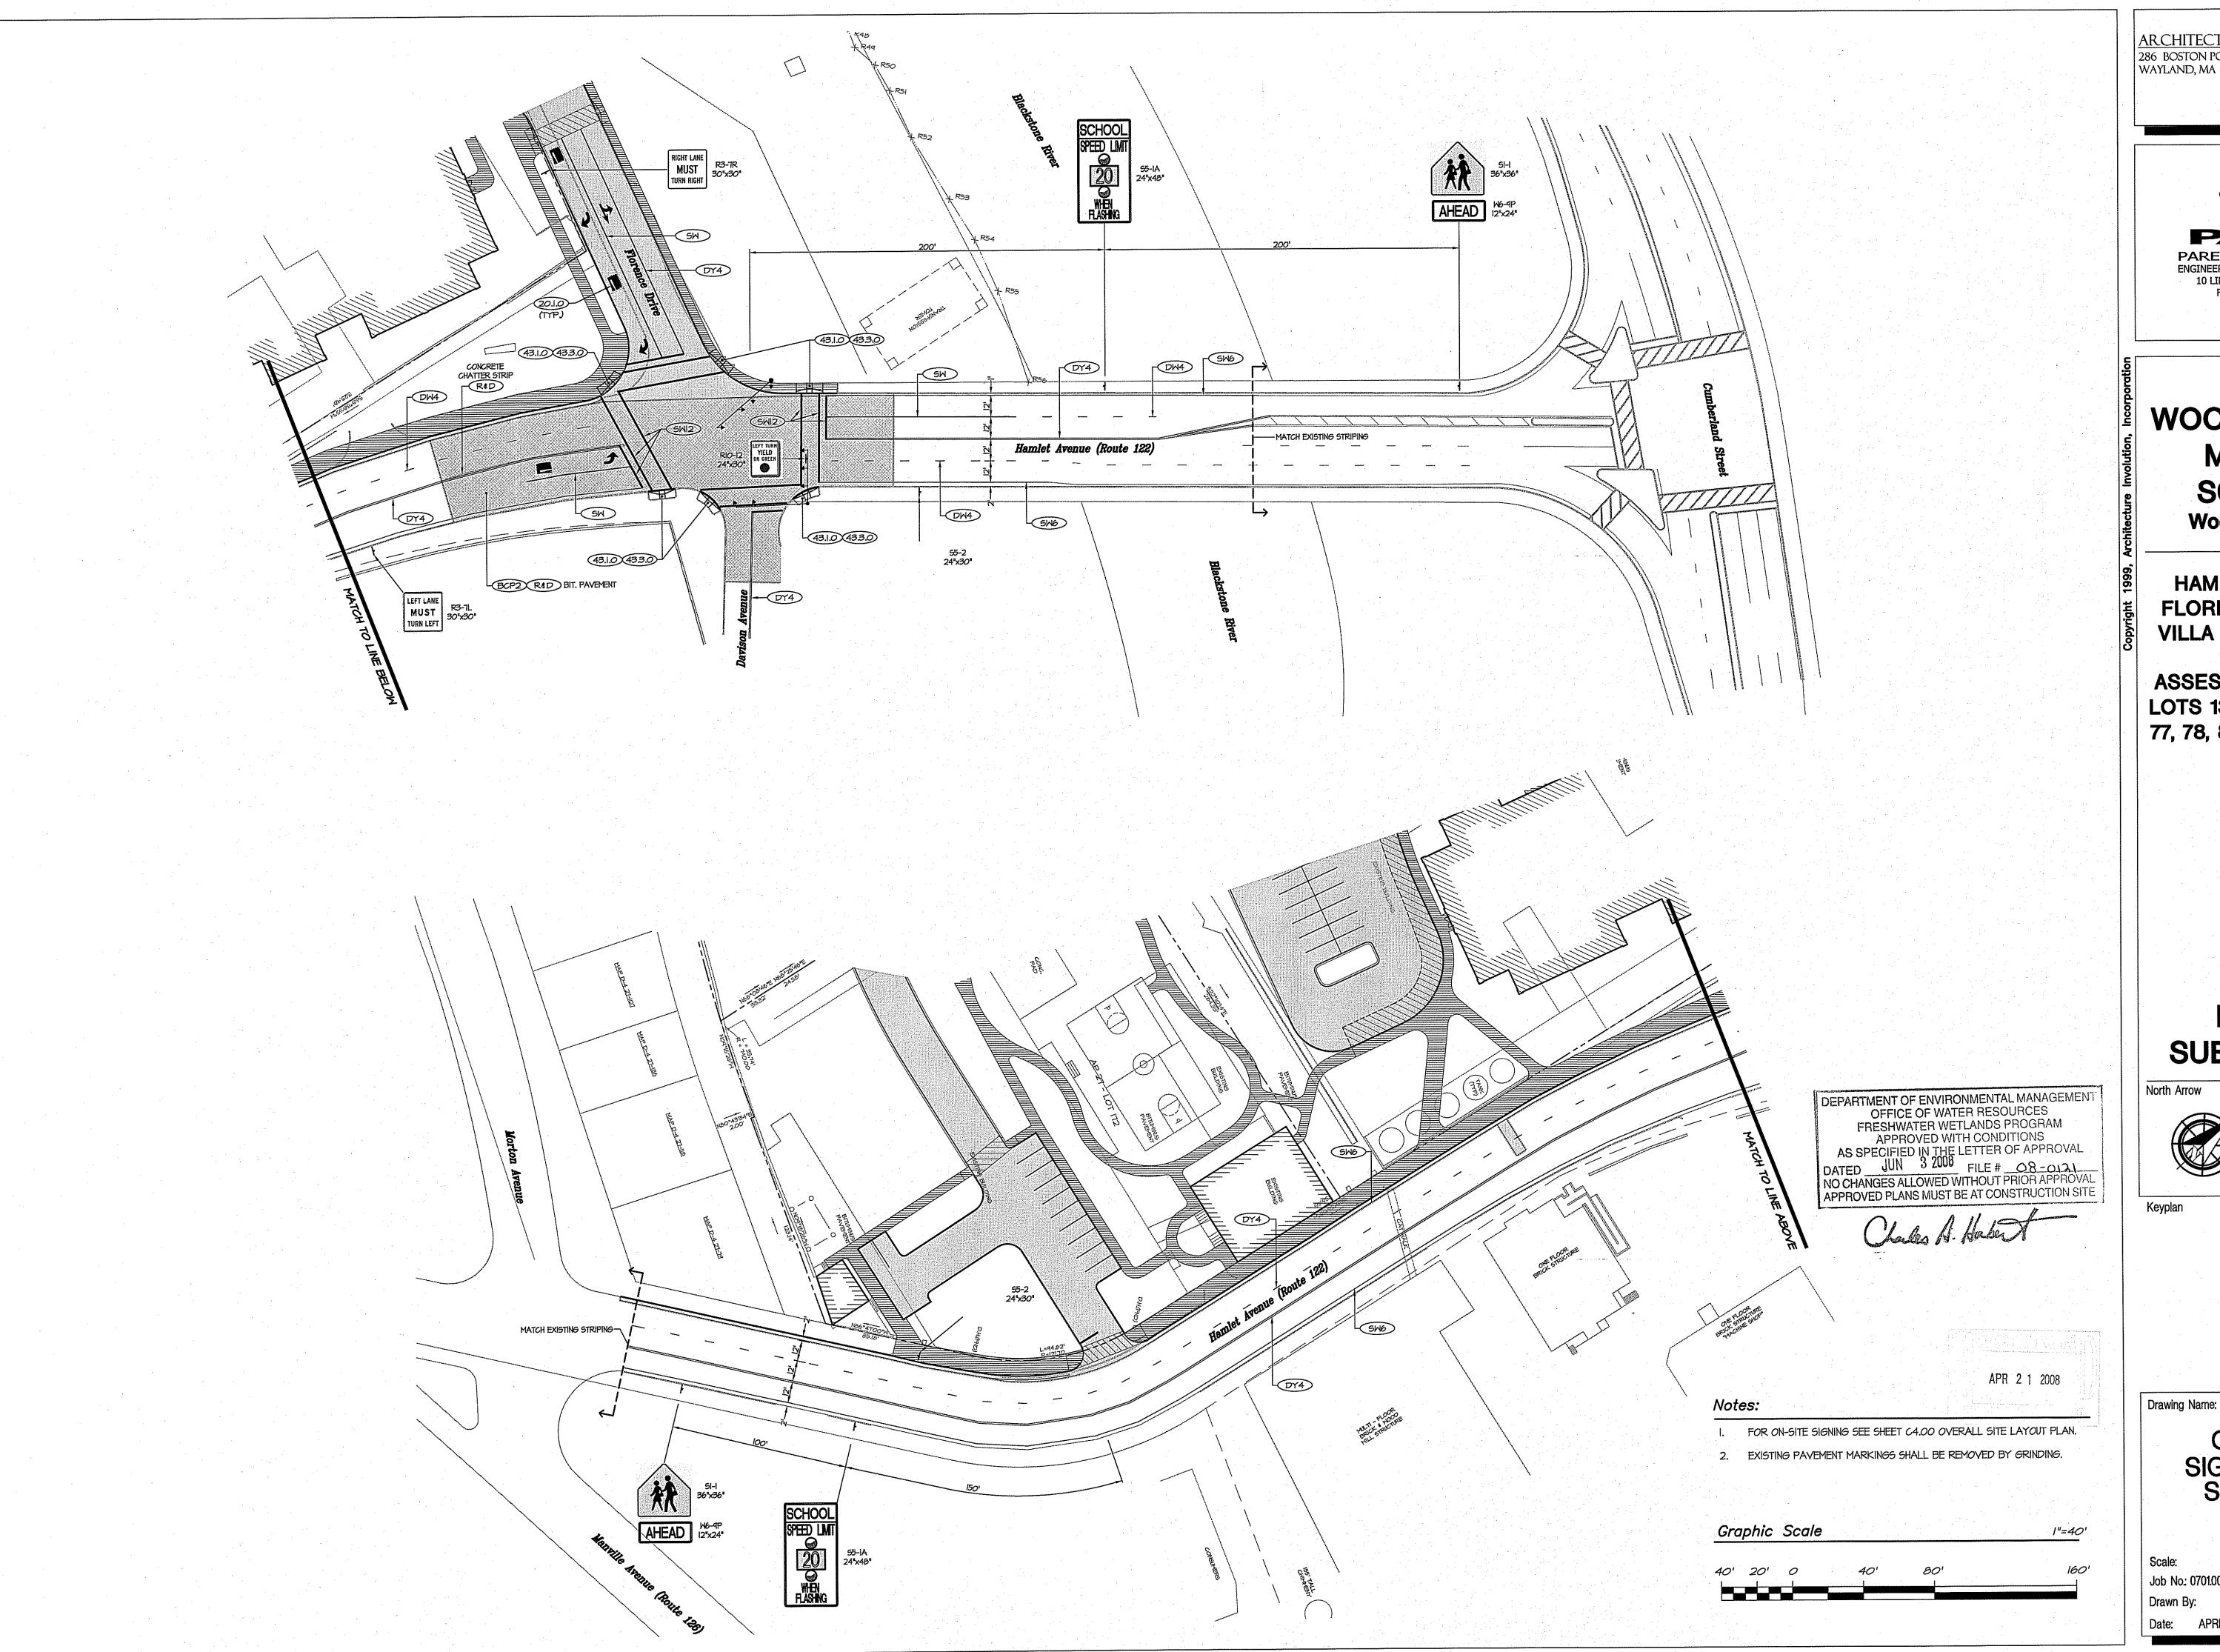

ARCHITECTURE INVOLUTION, INC. 286 BOSTON POST ROAD 508-358-0790 (TWAYLAND, MA 01778 508-358-0791 (F AI3@AI-3.CON



PARE CORPORATION
ENGINEERS - SCIENTISTS - PLANNERS
10 LINCOLN ROAD, SUITE 103
FOXBORO, MA 02035
508-543-1755

NEW WOONSOCKET **MIDDLE** SCHOOL Woonsocket, RI


HAMLET AVENUE, FLORENCE DRIVE & **VILLA NOVA STREET**

ASSESSOR'S PLAT 27 LOTS 13, 24, 26, 62, 63, 77, 78, 81, 91, 165, & 170

RIDEM SUBMISSION


North Arrow



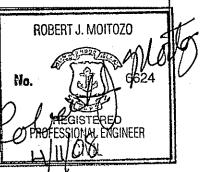

OFF-SITE SIGNING AND STRIPING PLAN

Job No.: 0701.00/06176.02

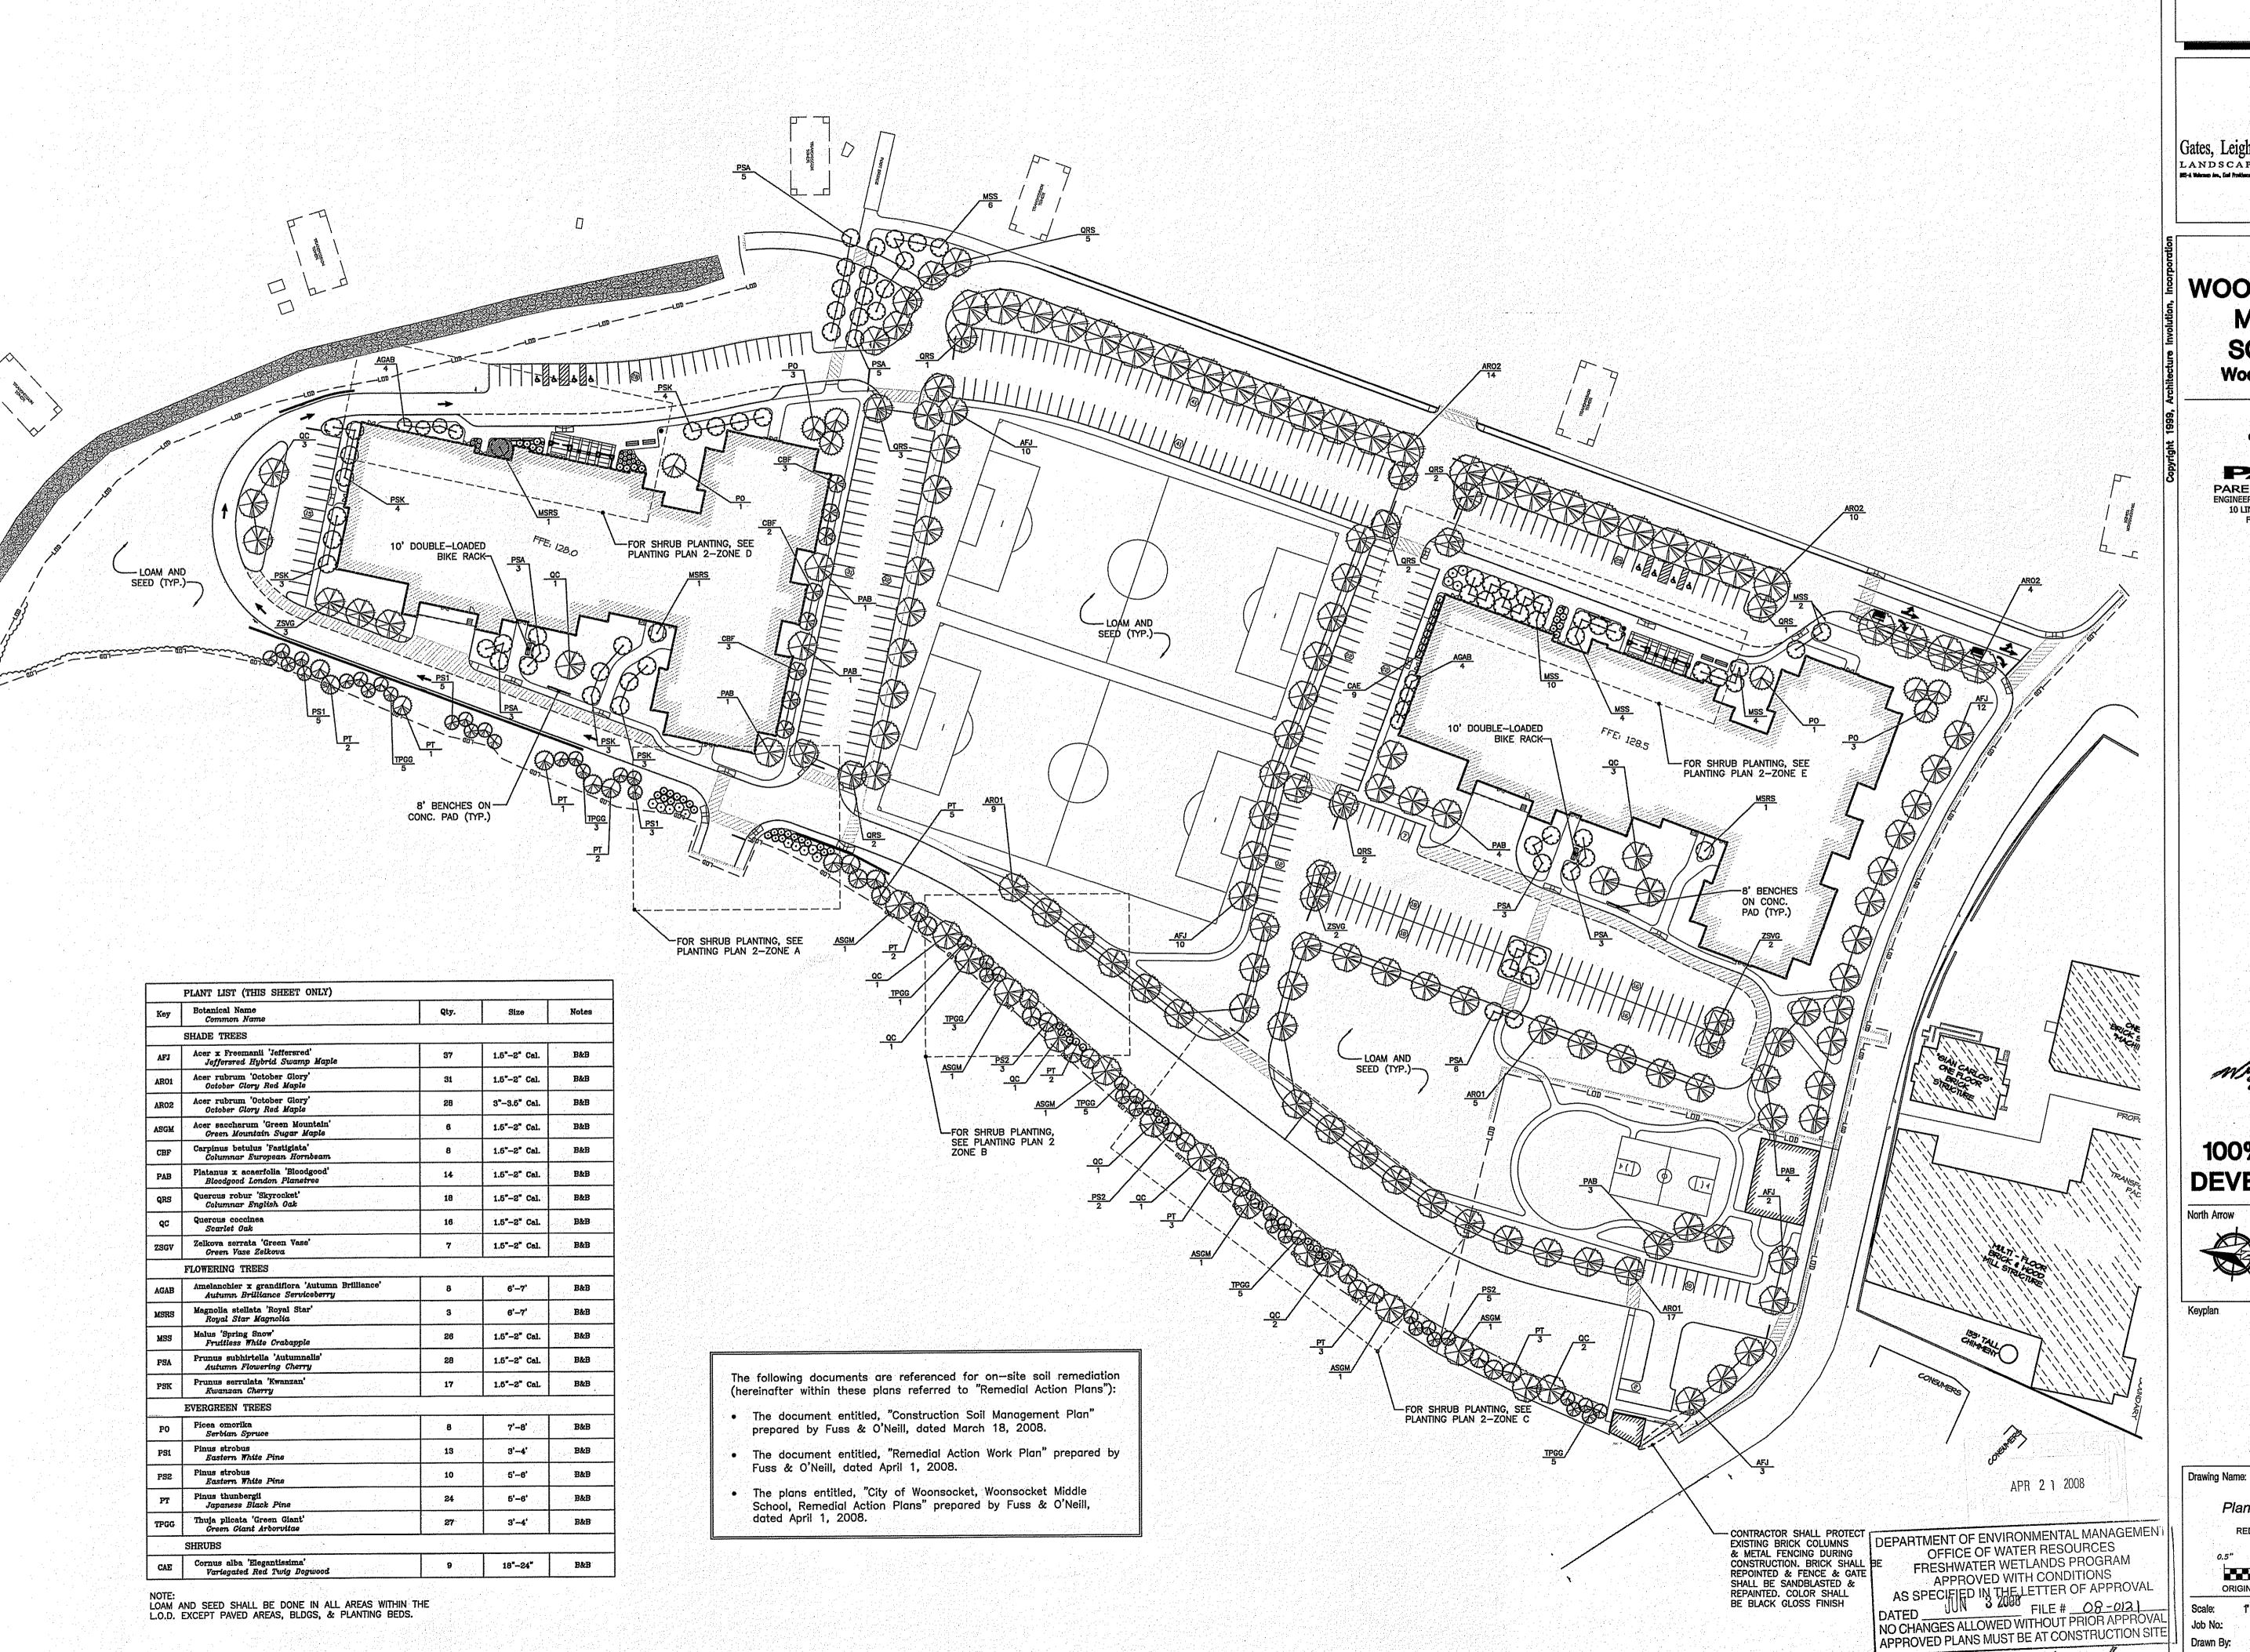

ARCHITECTURE INVOLUTION, IN 286 BOSTON POST ROAD 508-358-0790 WAYLAND, MA 01778



Gates, Leighton & Associates, In LANDSCAPE ARCHITECTUR
185-A WALLESS AND LEAR PROJECTION, 18 02014 PR.(40) 1023-2071 Enc(40) 1023-2071 E-mathylatelytes

NEW WOONSOCKET MIDDLE SCHOOL Woonsocket, RI





100% DESIGN **DEVELOPMENT**




Keyplan

Planting Plan 1

REDUCED PLAN ---

ORIGINAL PLAN SCALE

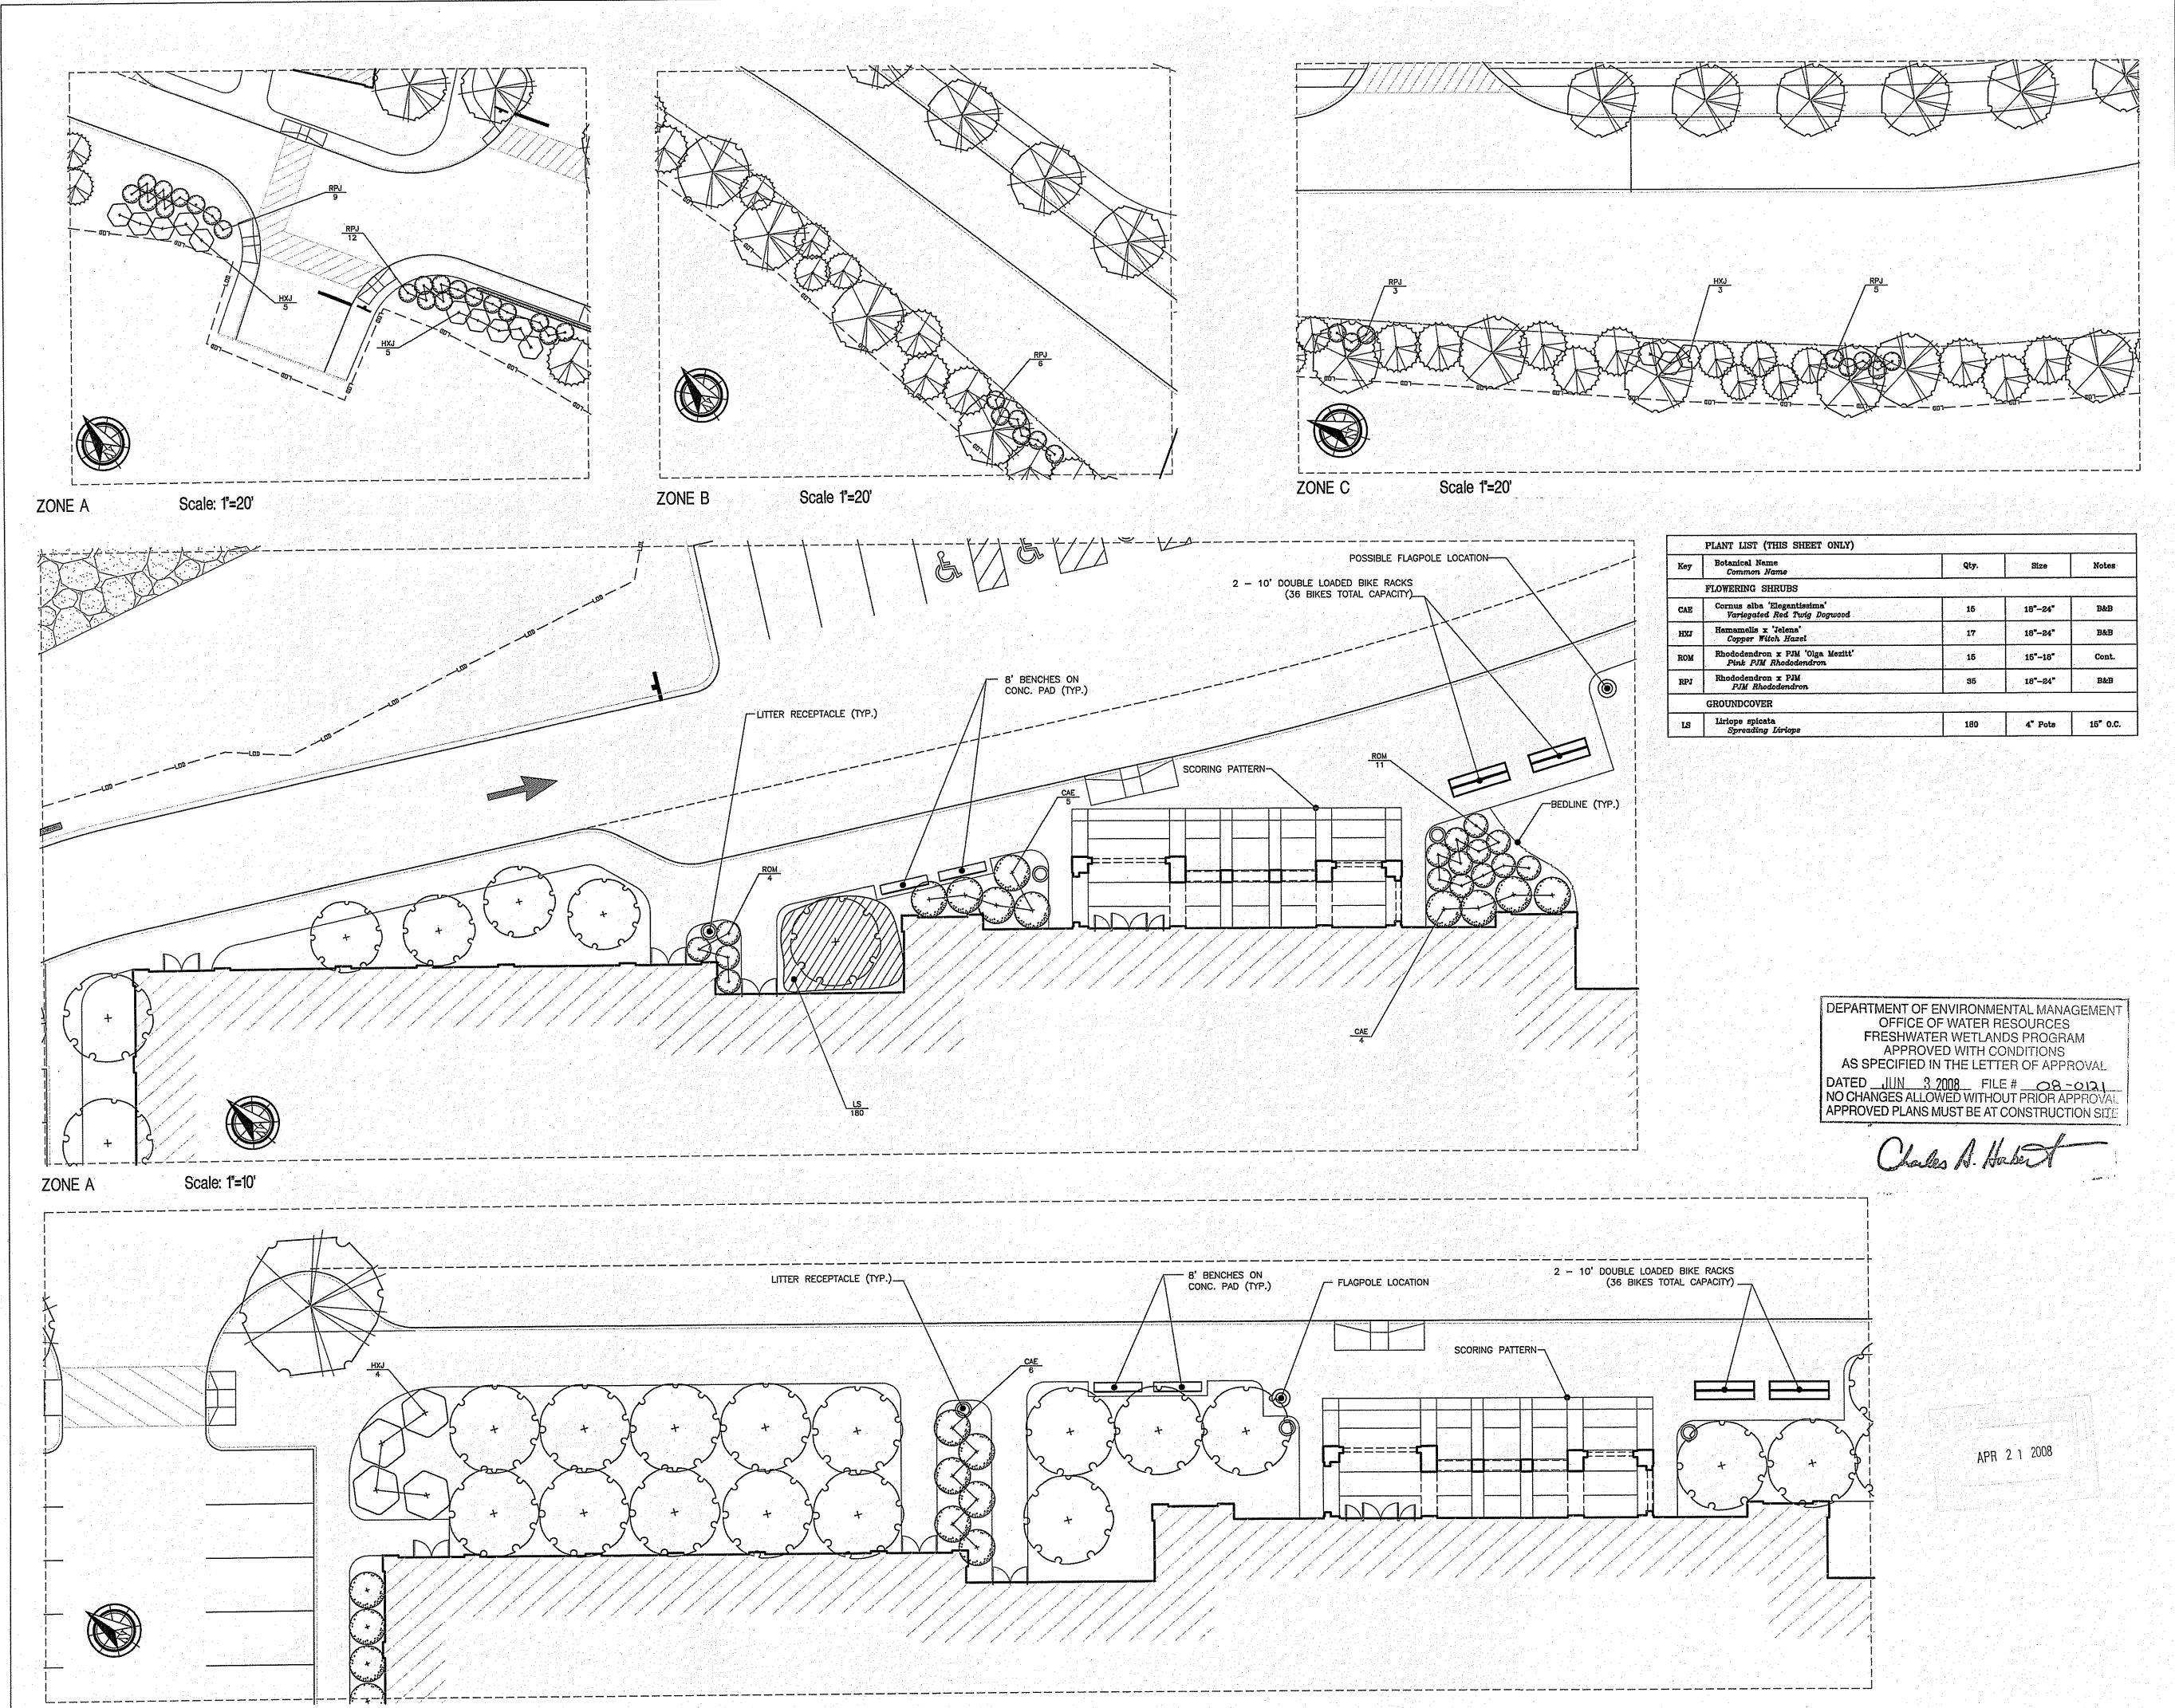

Scale 1"=10"

ZONE E

ARCHITECTURE INVOLUTION, IN

286 BOSTON POST ROAD 508-358-0790 (
WAYLAND, MA 01778 508-358-0791 (
A13@A1-3.CO



Gates, Leighton & Associates, Inc.

NEW
WOONSOCKET
MIDDLE
SCHOOL
Woonsocket, RI





North Arrow

Keyplan

Drawing Name:


Planting Pla

ORIGINAL PLAN SCALE

ORIGINAL PLAN SCALE


Drawing Numb

No: VARIES Drawing
No: 070100
wn By: SGG

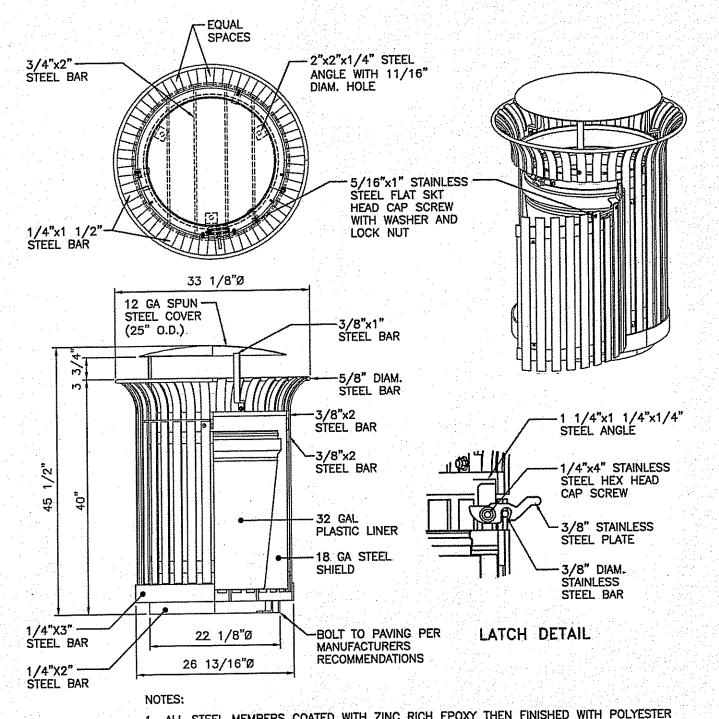


- 1. ALL STEEL MEMBERS COATED WITH ZINC RICH EPOXY THEN FINISHED WITH POLYESTER POWDER COATING, SEE SPECIFICATIONS FOR COLOR.
- 2. 1/2"x3 3/4" PLTD. EXPANSION ANCHOR BOLTS PROVIDED.
- 3. SEE SPECIFICATIONS FOR MANUFACTURER, MODEL, & FINISH
- 4. INSTALLATION TO BE COMPLETED IN ACCORDANCE WITH MANUFACTURE'S SPECIFICATIONS.


TRASH RECEPTACLE DETAIL

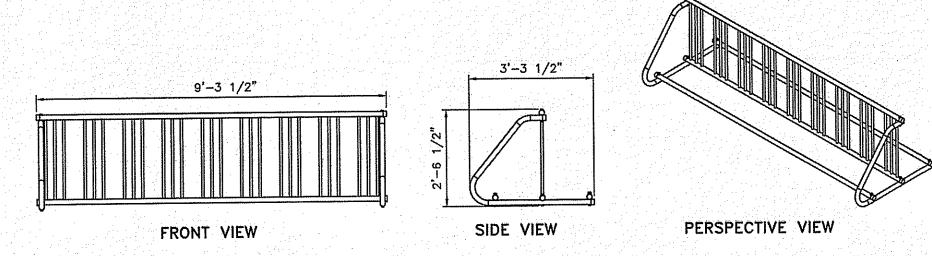

- 1. BIKE RACK SHALL BE MOUNTED AT LOCATION SHOWN ON PLAN WITH MANUFACTURER'S MOUNTING KIT, SEE SPECS.
- 2. INSTALLATION TO BE COMPLETED IN ACCORDANCE WITH MANUFACTURER'S SPECIFICATIONS.
- 3. SEE SPECIFICATIONS FOR MANUFACTURER, MODEL, & FINISH


BIKE RACK DETAIL NOT TO SCALE

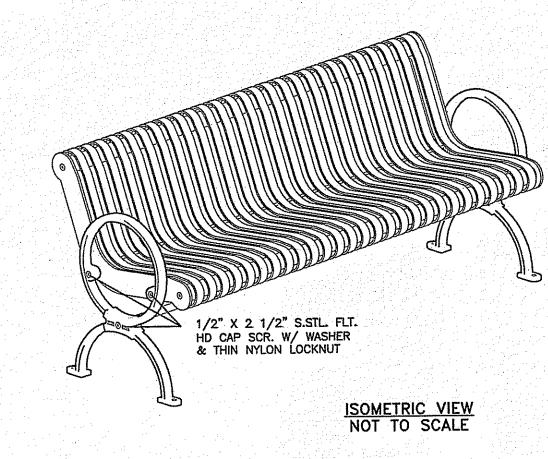

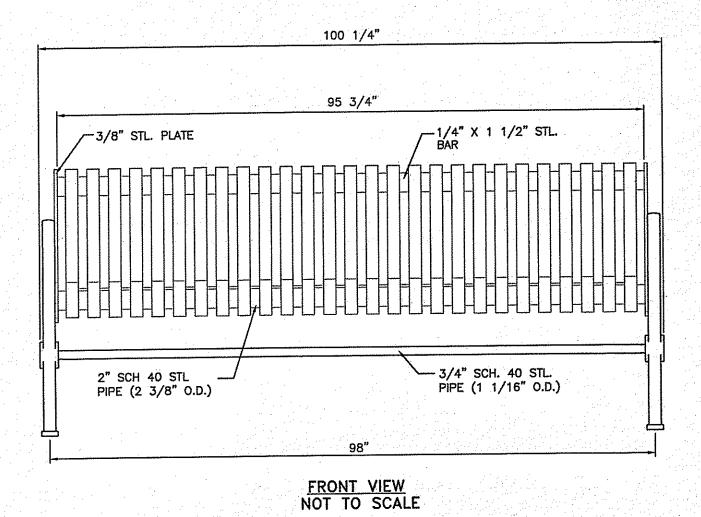

- 28 1/16" 1/2" X 1 1/2" . S.STL. FLT. HD. CAP SCR. 1/2" X 3" S.STL. FLT. HD. CAP SCR. 9/16" Ø HOLES 20 1/2" SIDE VIEW NOT TO SCALE
- 1. ALL STEEL MEMBERS COATED WITH ZINC RICH EPOXY THEN FINISHED WITH POLYESTER POWDER COATING, SEE SPECIFICATIONS FOR COLOR.
- 1. INSTALLATION TO BE COMPLETED IN ACCORDANCE WITH MANUFACTURER'S SPECIFICATIONS. 3. 1/2" X 3 3/4" EXPANSION ANCHOR BOLTS PROVIDED FOR S-2 OPTION. 4. SEE SPECIFICATIONS FOR MAUNFACTURER, MODEL, & FINISH

8' LONG BENCH WITH BACK NOT TO SCALE

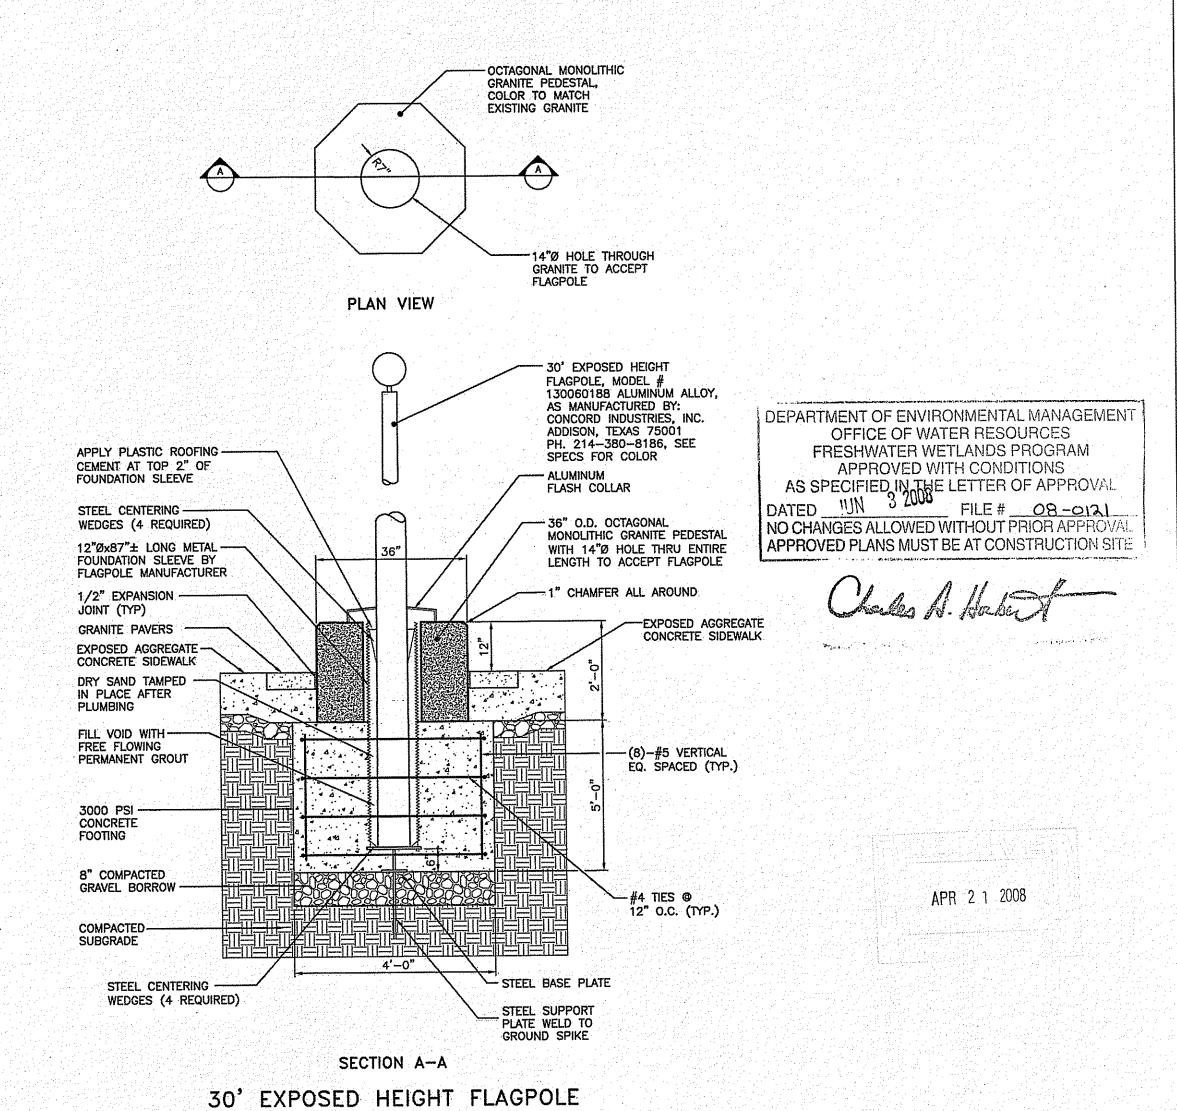

INSTALLATION DETAIL NOT TO SCALE


ARCHITECTURE INVOLUTION, IN 286 BOSTON POST ROAD 508-358-0790 (WAYLAND, MA 01778 508-358-0791 (



Gates, Leighton & Associates, Inc. LANDSCAPE ARCHITECTUR

> NEW WOONSOCKET MIDDLE SCHOOL Woonsocket, RI




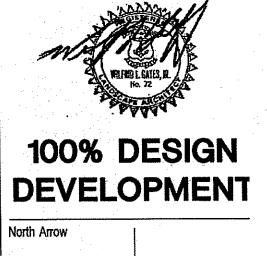

Keyplan


Drawing Name:


Hardscape Details REDUCED PLAN

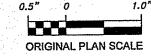

Job No: Drawn By:

Date: MAR. 28, 2008

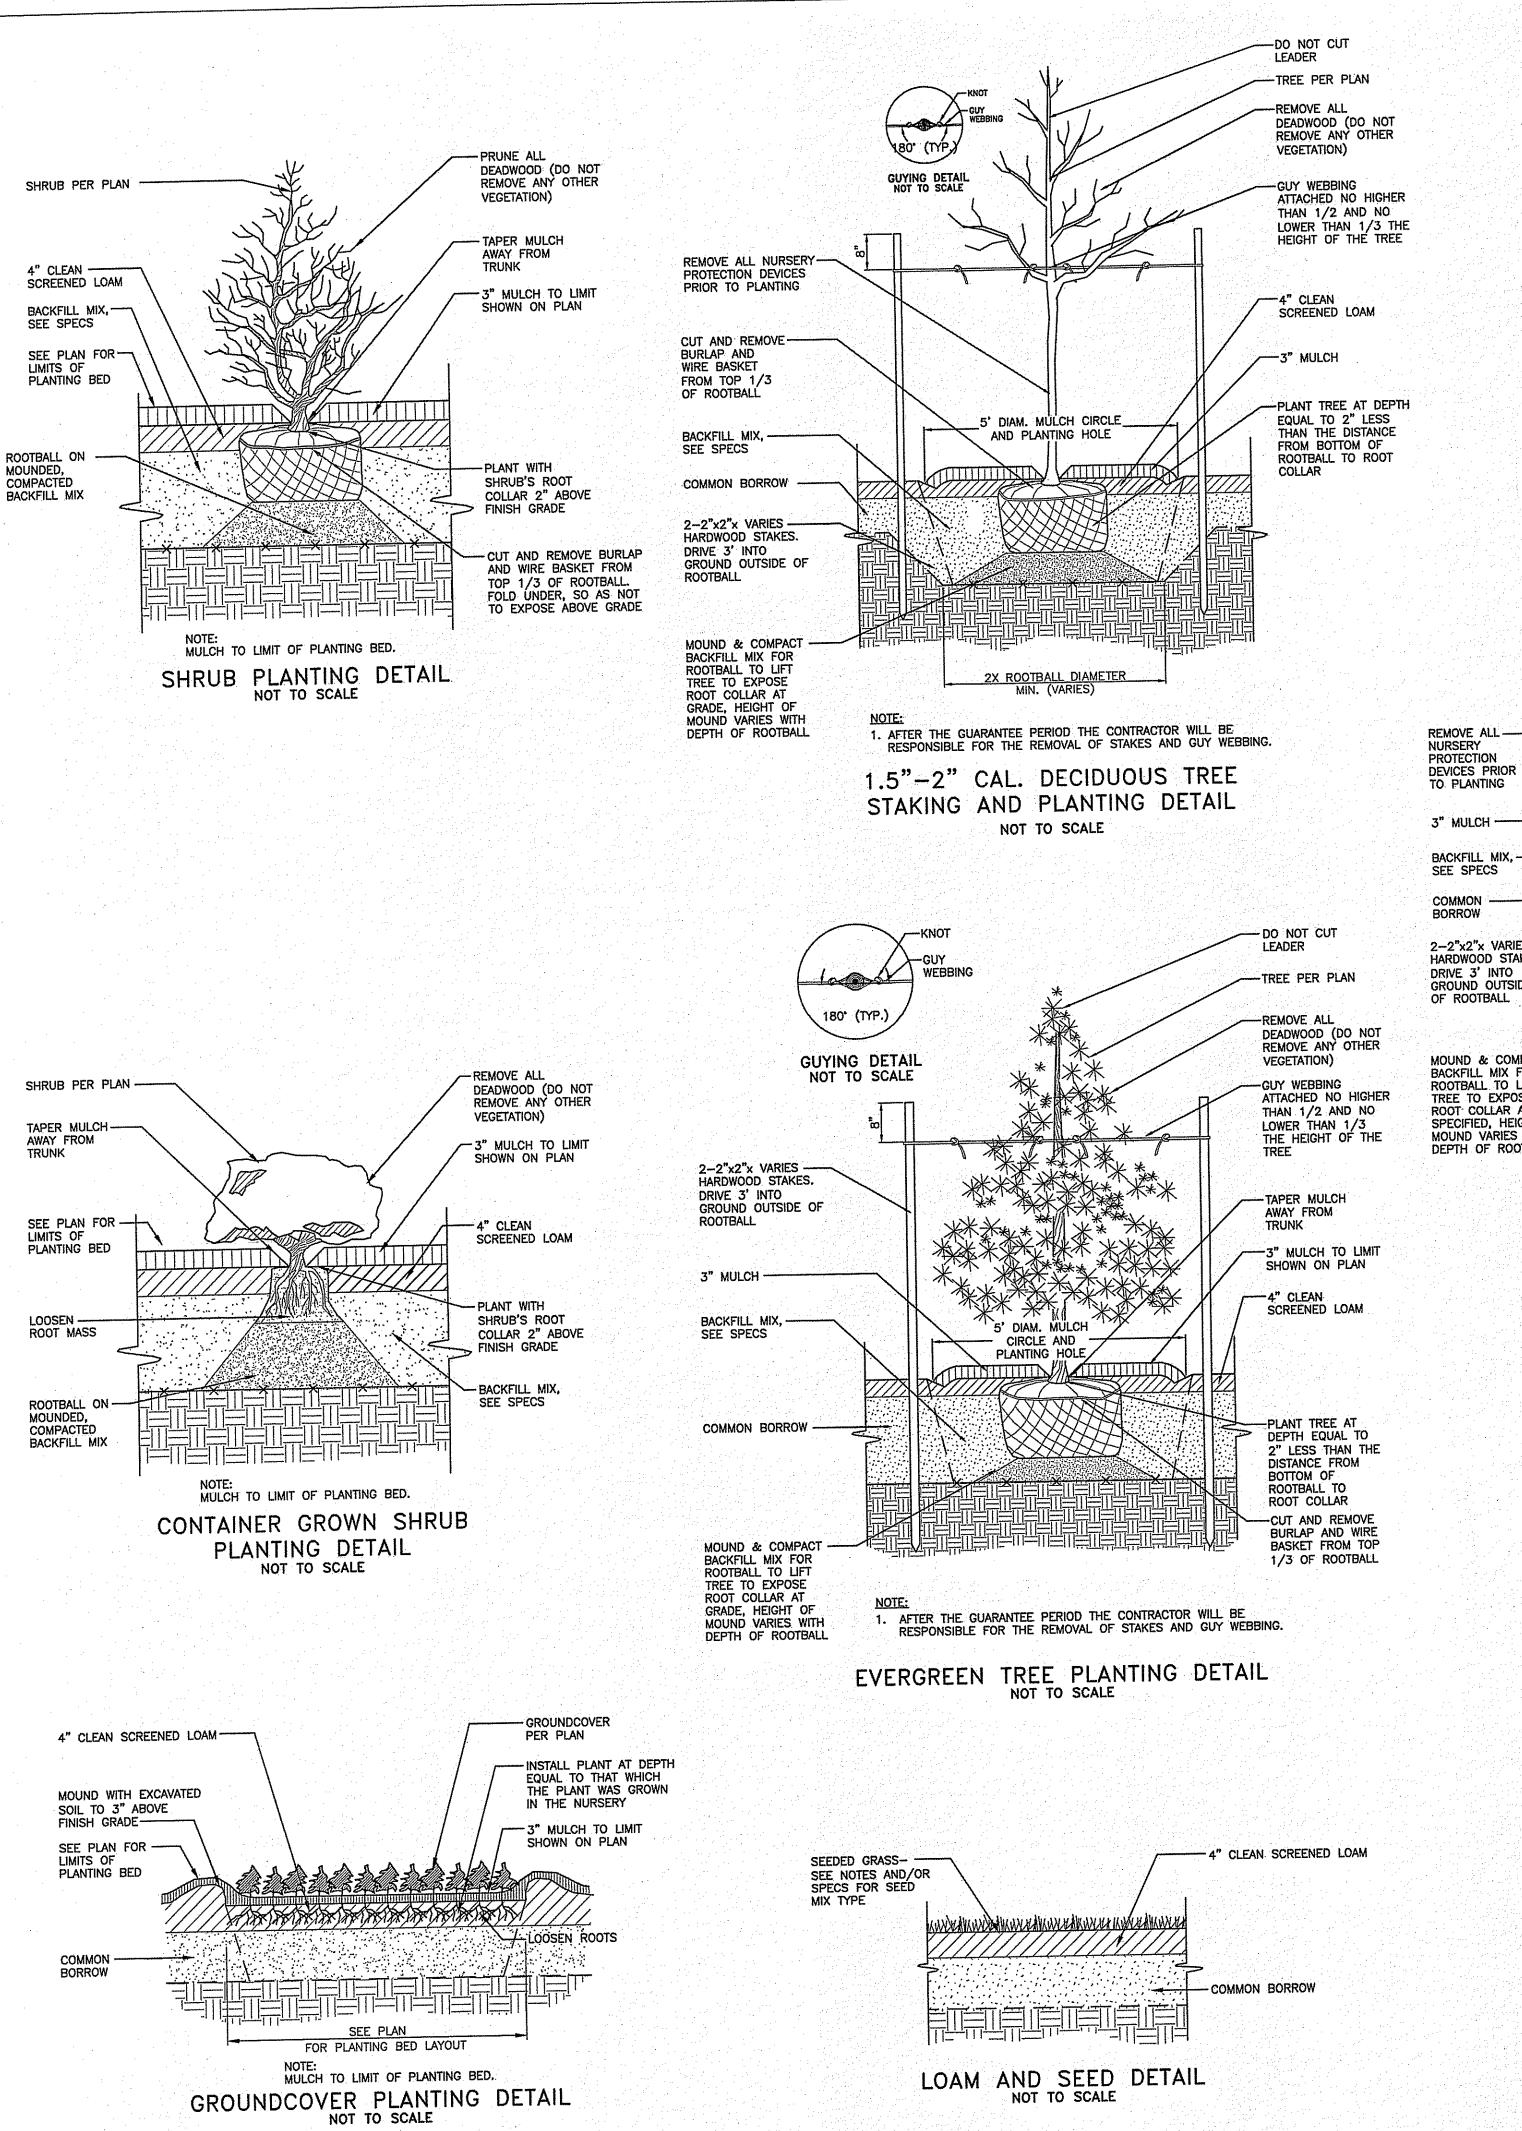

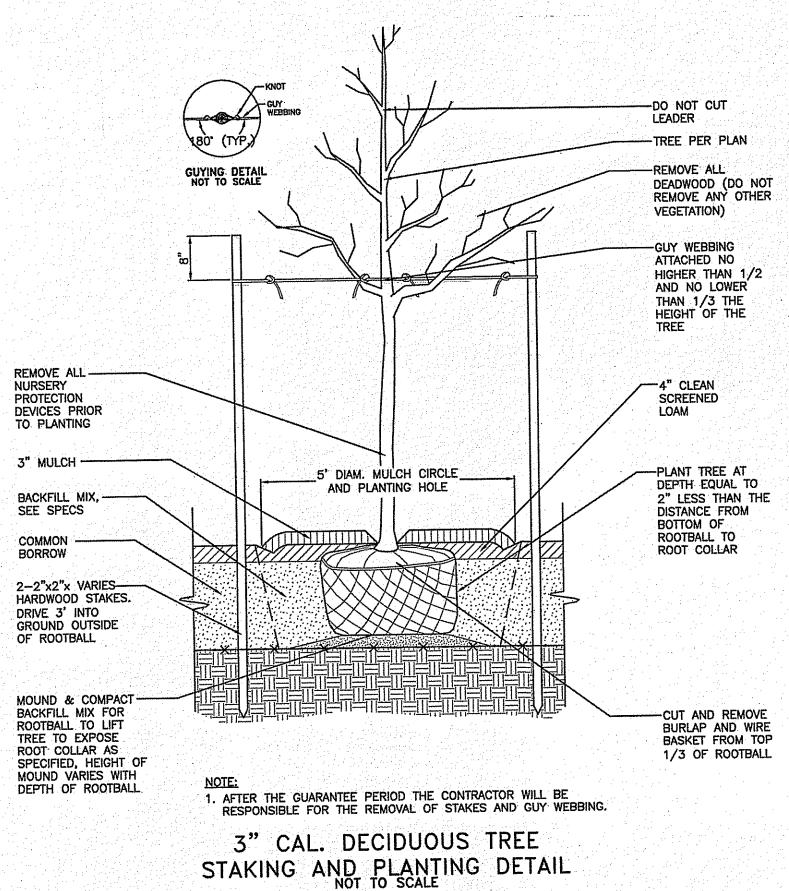

-'VEE' CUT

--- 3" MULCH

NOTE: LOCATE BEDLINE AS SHOWN ON PLAN.

BEDLINE EDGE DETAIL
NOT TO SCALE

-4" CLEAN SCREENED LOAM

TAMP EDGE OF LOAM

LAWN -

COMMON BORROW-


1" SOIL REVEAL -

DEPARTMENT OF ENVIRONMENTAL MANAGEMENT OFFICE OF WATER RESOURCES
FRESHWATER WETLANDS PROGRAM
APPROVED WITH CONDITIONS
AS SPECIFIED IN THE LETTER OF APPROVAL
DATED JUN 3 2008
FILE # __O8_-O.D.L
NO CHANGES ALLOWED WITHOUT PRIOR APPROVAL
APPROVED PLANS MUST BE AT CONSTRUCTION SITE

APR 2 1 2008

FOR MINIMUM CAPPING DETAILS, REFER TO THE REMEDIAL ACTION WORK PLANS.


ARCHITECTURE INVOLUTION, I 286 BOSTON POST ROAD 508-358-0790 (508-358-0791 (F) WAYLAND, MA 01778 AI3@AI-3.COM

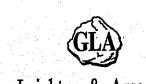

Gates, Leighton & Associates, Inc. LANDSCAPE ARCHITECTURE

> NEW WOONSOCKET **MIDDLE** SCHOOL Woonsocket, Ri



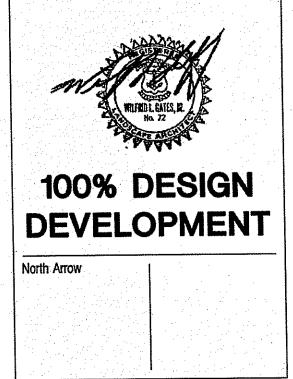

Keyplan

Drawing Name: Landscape Details REDUCED PLAN ORIGINAL PLAN SCALE Scale: Drawn By

Date: MAR. 28, 2008