

ZONING CRITERIA	
ZONING DISTRICT	R40
MINIMUM LOT AREA	40,000 SQ. FT.
MINIMUM LOT FRONTAGE	150'
MINIMUM FRONT YARD SETBACK	40'
MINIMUM SIDE YARD SETBACK	15'
MINIMUM REAR YARD SETBACK	40'
MAXIMUM BUILDING COVERAGE	15%
MAXIMUM BUILDING HEIGHT	35'

- GENERAL NOTES:**
1. THE LOCATION AND DEPTH OF EXISTING UTILITIES ARE APPROXIMATE AND HAVE BEEN PLOTTED FROM THE LATEST AVAILABLE INFORMATION. THE UTILITY LOCATIONS ARE APPROXIMATE AND MAY NOT BE ALL INCLUSIVE. THE CONTRACTOR SHALL CHECK AND VERIFY THE LOCATIONS OF ALL EXISTING UTILITIES, BOTH OVERHEAD AND UNDERGROUND, AND "DIG-SAFE" MUST BE NOTIFIED PRIOR TO COMMENCING ANY CONSTRUCTION OPERATIONS. RESTORATION AND REPAIR OF DAMAGE TO EXISTING UTILITIES SHALL BE THE RESPONSIBILITY OF THE CONTRACTOR WITH NO ADDITIONAL COST TO THE OWNER. NO EXCAVATION SHALL COMMENCE UNTIL ALL INVOLVED UTILITY COMPANIES AND/OR TOWN WHOSE FACILITIES MIGHT BE AFFECTED BY ANY WORK TO BE PERFORMED BY THE CONTRACTOR ARE NOTIFIED AT LEAST 72 HOURS IN ADVANCE.
 2. THIS SITE LIES IN A ZONE X AS PER FIRM FLOOD INSURANCE RATE MAP PROVIDENCE COUNTY PANEL 135 OF 451 MAP NUMBER 44007C135G EFFECTIVE DATE MARCH 2 2009.
 3. WETLANDS SHOWN HEREIN WERE DELINEATED BY NATURAL RESOURCE SERVICES INC. PO BOX 311 HARRISVILLE RHODE ISLAND ON APRIL 12 2017.
 4. THIS SITE DOES NOT LIE WITHIN ANY KNOWN AGRICULTURAL USE, SILVICULTURAL USE, NATURAL HERITAGE OR FARMLAND CONSERVATION AREAS.
 5. THERE ARE NO KNOWN EASEMENTS OR RIGHTS OF WAY WITHIN OR ADJACENT TO THIS PARCEL.
 6. THE CONTOURS SHOWN HEREIN ARE BASED UPON NAVD 88 DATUM.
 7. THERE ARE NO KNOWN HISTORIC CEMETERIES WITHIN OR IMMEDIATELY ADJACENT TO THIS PARCEL.
 8. PREVIOUS RHODE ISLAND DEPARTMENT OF ENVIRONMENTAL MANAGEMENT APPLICATION NO. 99-0029. DATED APRIL 23, 1999.
 9. AREA IS WITHIN THE A-80 AQUIFER OVERLAY DISTRICT AREA.
 10. AREA IS WITHIN THE COMMUNITY WELLHEAD AREA.



- REFERENCES:**
1. PLAN ENTITLED "PLAN OF LAND OWNED BY THOMAS V. & MICHELLE M. BLISS BURRILLVILLE RHODE ISLAND SCALE 1"=50' DATED JUNE 1989 SHEET ONE OF TWO" BY ROBERT C. COURNOYER & ASSOCIATES INC.
 2. PLAN ENTITLED "PLAN & PROFILE TO ACCOMPANY SEWER EXTENSION PERMIT FOR THOMAS V. & MICHELLE M. BLISS AP 212 LOT 14 808 STEERE FARM ROAD BURRILLVILLE RHODE ISLAND SCALE 1"=40' DATED APRIL 2009 SHEET 1 OF 2" BY NATIONAL SURVEYORS-DEVELOPERS INC.



BENCH MARK:
SPIKE IN POLE #44
ELEVATION 477.41
NAVD 88 DATUM

BENCH MARK:
SPIKE IN POLE #43
ELEVATION 485.10
NAVD 88 DATUM

"I CERTIFY THAT THE INFORMATION SHOWN HEREON HAS BEEN OBTAINED BY AN ACTUAL SURVEY ON THE GROUND, THAT IT IS CORRECT AND THIS SURVEY AND PLAN CONFORM TO A CLASS STANDARD AS ADOPTED BY THE RHODE ISLAND BOARD OF REGISTRATION FOR PROFESSIONAL LAND SURVEYORS."
BY: *Norbert A. Therien*
NORBERT A. THERIEN P.L.S.

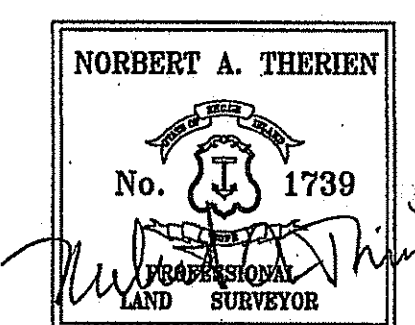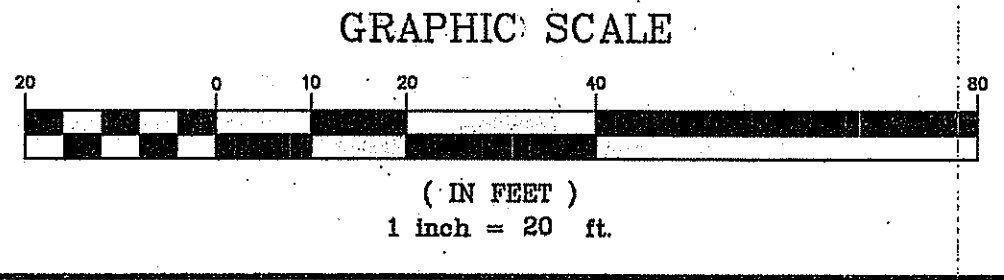

NATIONAL Surveyors-Developers Inc.
42 Hamlet Ave., Woonsocket, R.I. (401) 769-7779

LIGHTNING RIDGE FARM INC.
ASSESSORS MAP 212 LOT 31
STEERE FARM ROAD
BURRILLVILLE, RHODE ISLAND

EXISTING CONDITIONS

DRAWN BY: W.C.R.	CHECKED BY: N.A.T.	FIELD BY: J.N.R.C.
MAY 2017	JOB No. 2017-75	SHEET 1 OF 3



DEPARTMENT OF ENVIRONMENTAL MANAGEMENT
OFFICE OF WATER RESOURCES
FRESHWATER WETLANDS PROGRAM
REVIEWED SITE PLAN APPLICATION NO.: 17-0129
DATED JUN 30 2017
SEE LETTER OF SAME DATE.
Marlene D. Senesek

Kindly be advised that this Permit is not equivalent to a verification of the type or extent of freshwater wetlands on site.


NO.	DATE	DESCRIPTION	BY

LEGEND
NOT TO SCALE

	BOUNDARY
	ABUTTER
	MAJOR CONTOUR
	MINOR CONTOUR
	TREELINE
	WETLANDS EDGE
	50' PERIMETER WETLAND
	100' RIVERBANK WETLAND
	STREAM
	BUILDING ENVELOPE
	DRAINAGE LINE
	EXISTING SEWER LINE
	EXISTING WATER LINE
	PROPOSED SEWER LINE
	PROPOSED WATER LINE
	LIMITS OF DISTURBANCE / EROSION CONTROL
	IRON PIN
	BOUND
	DRILL HOLE
	UTILITY POLE
	WATER VALVE
	HYDRANT
	SOIL EVALUATION HOLE

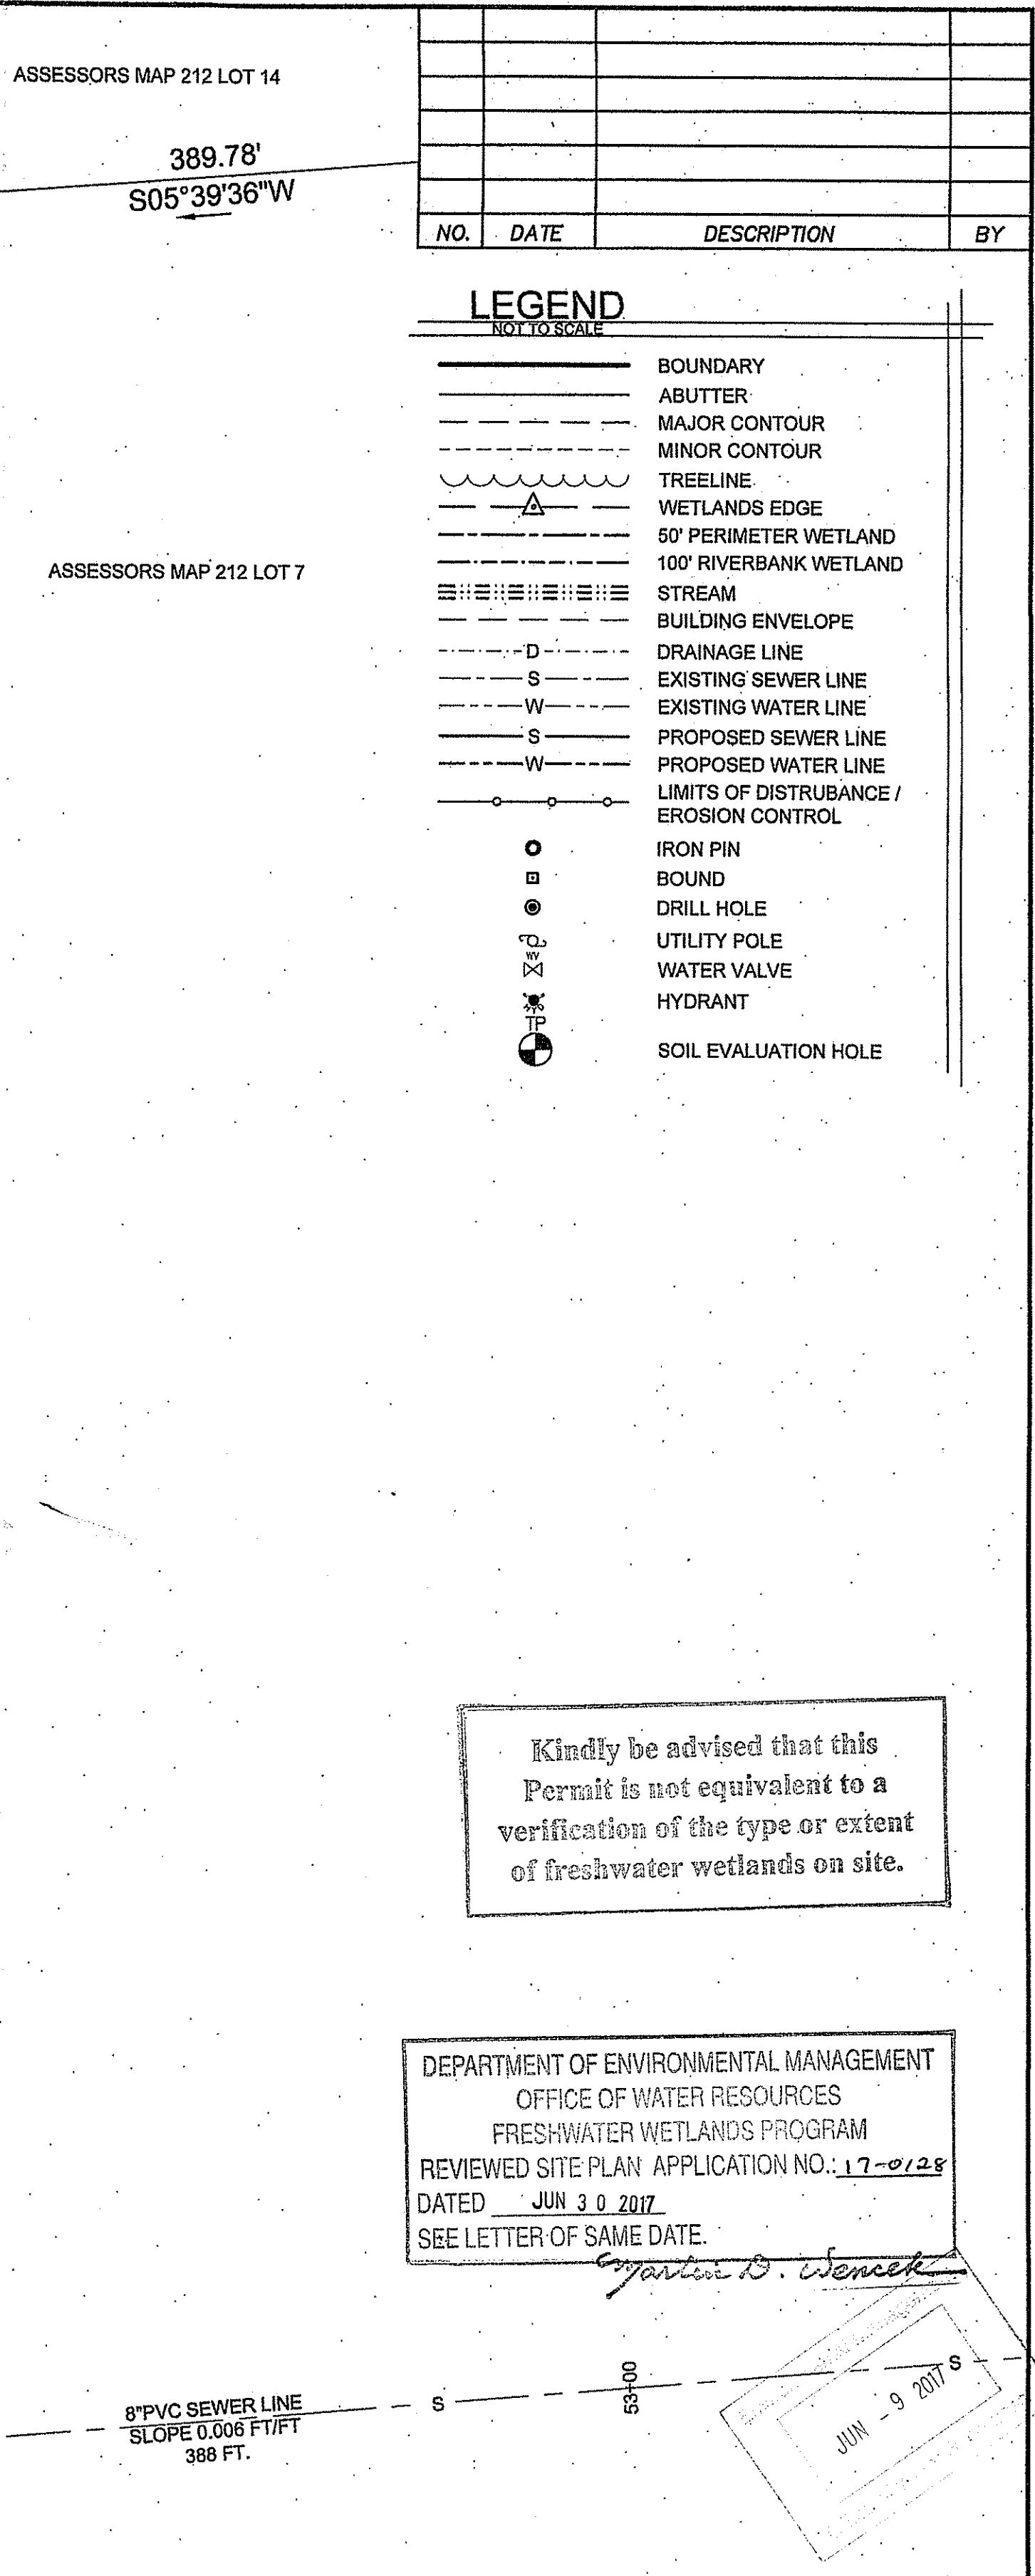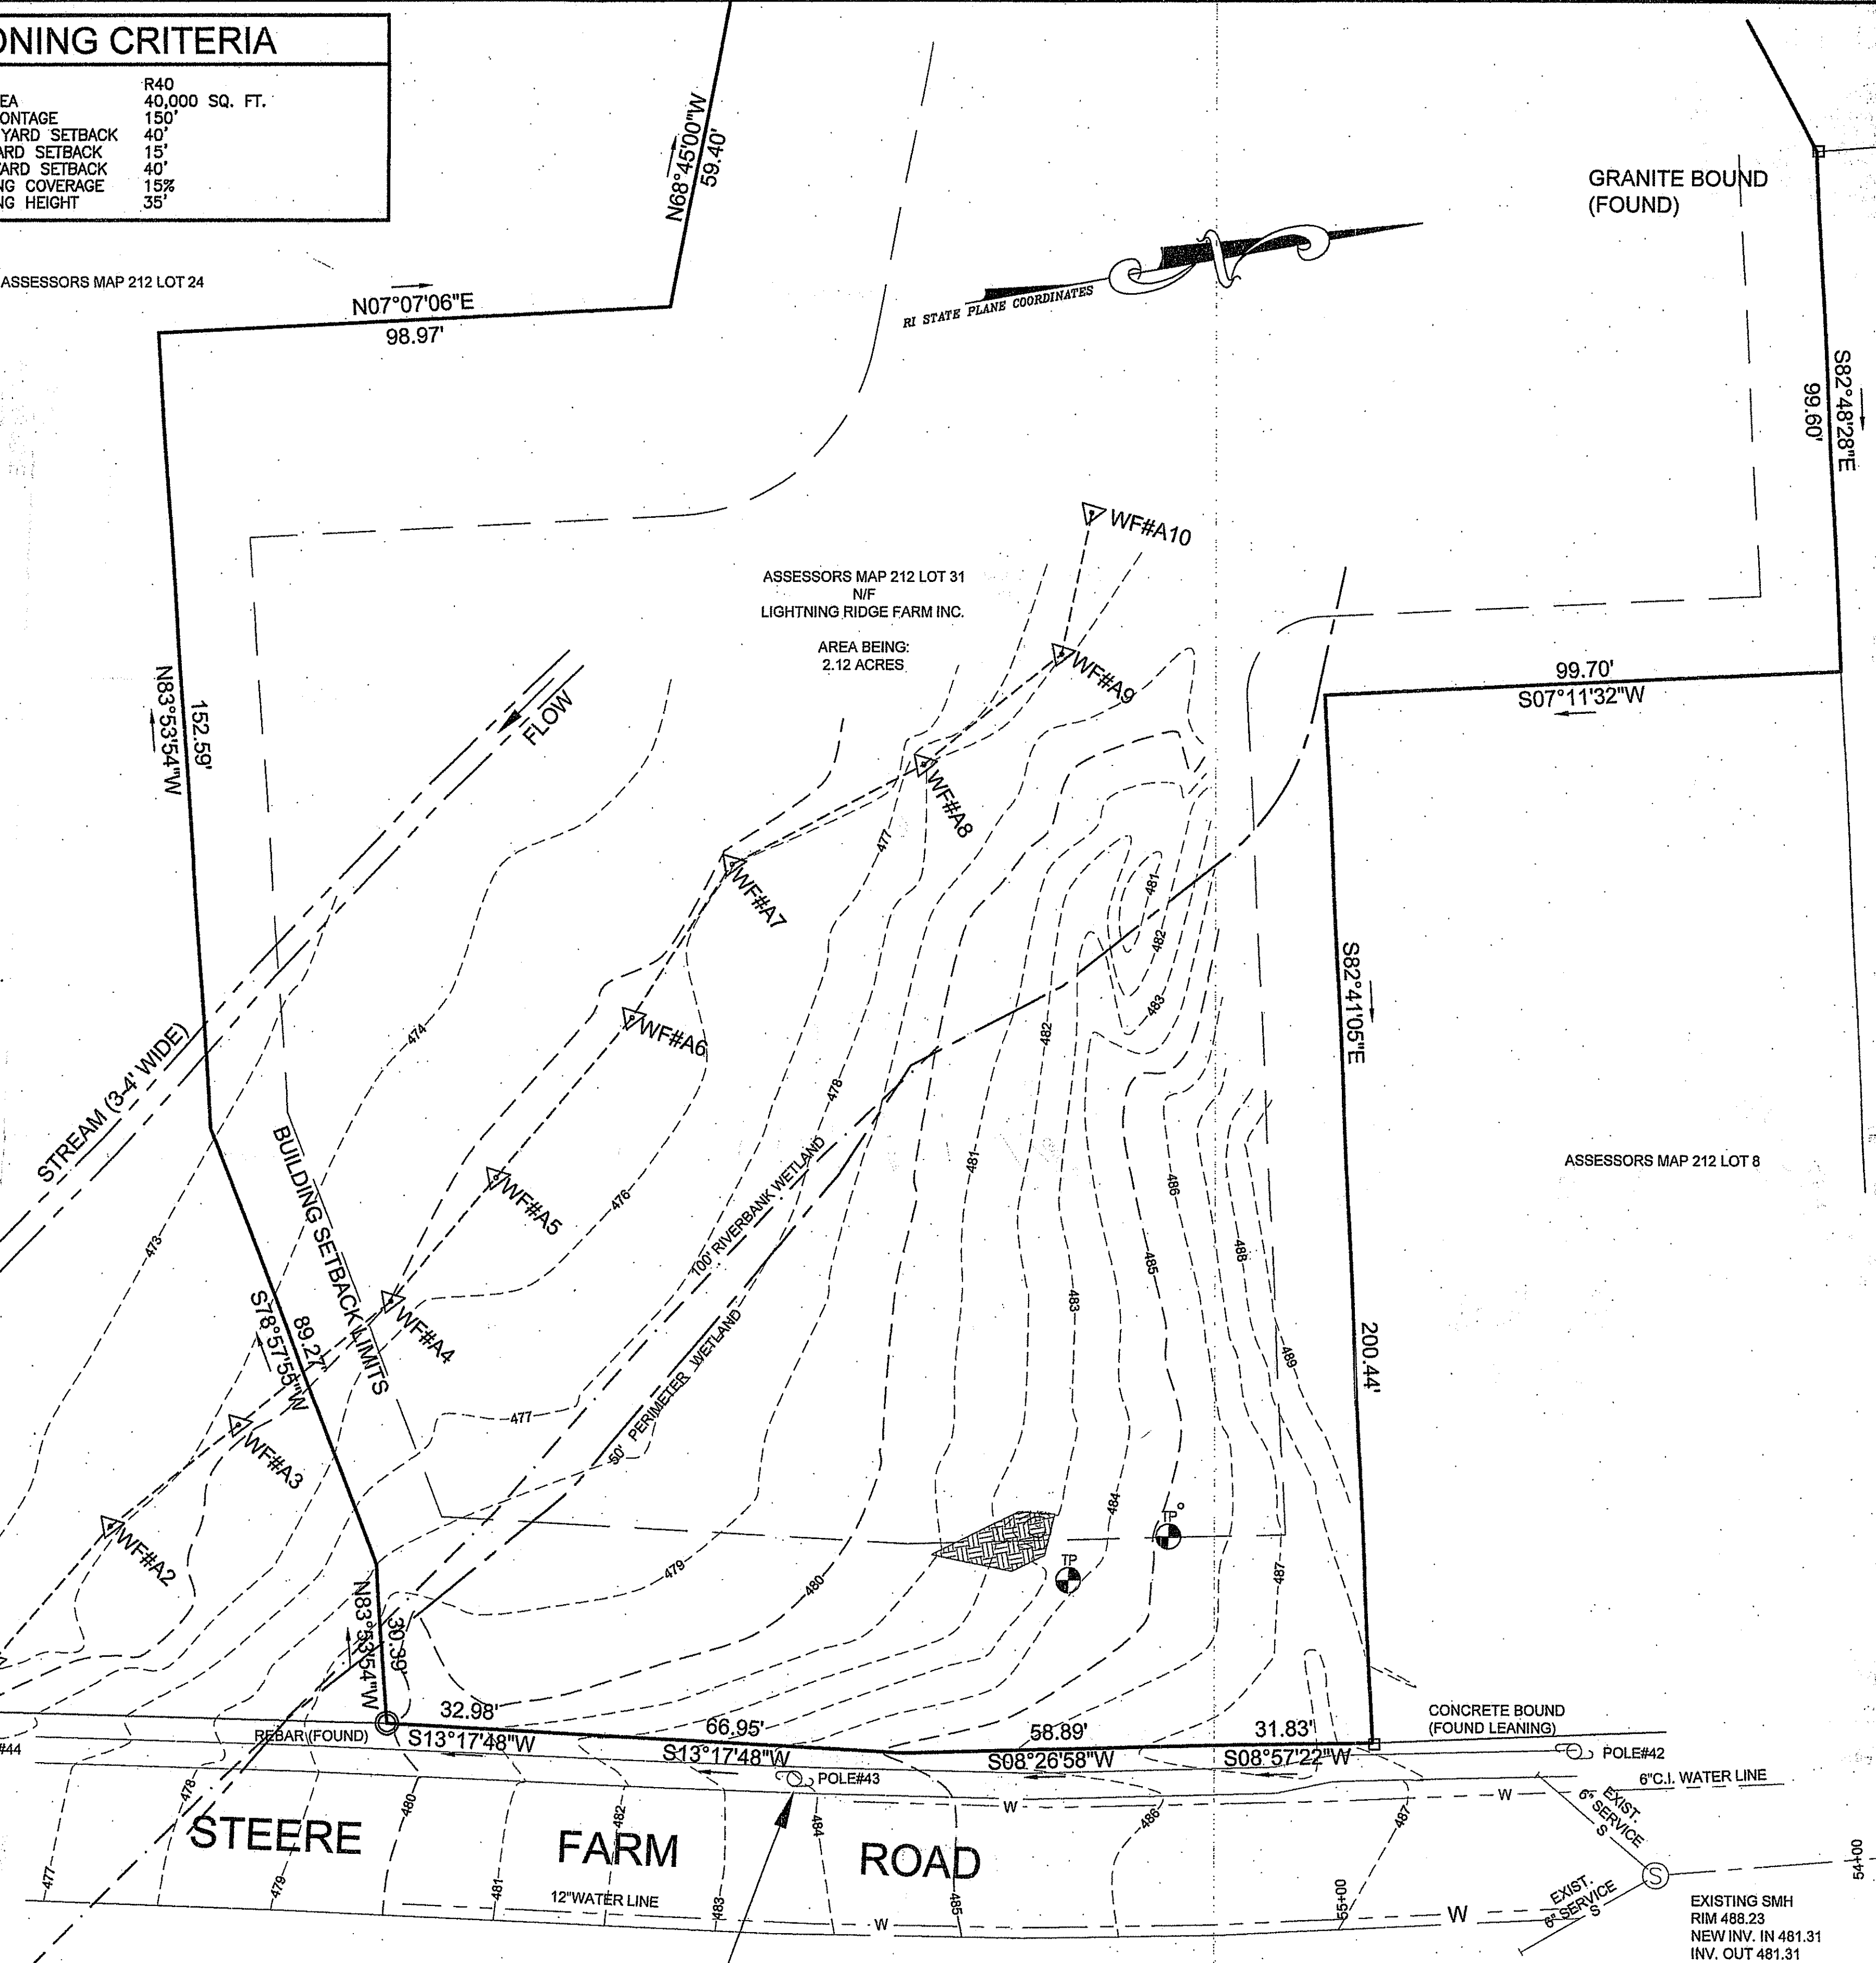

JUN 9 2017 S

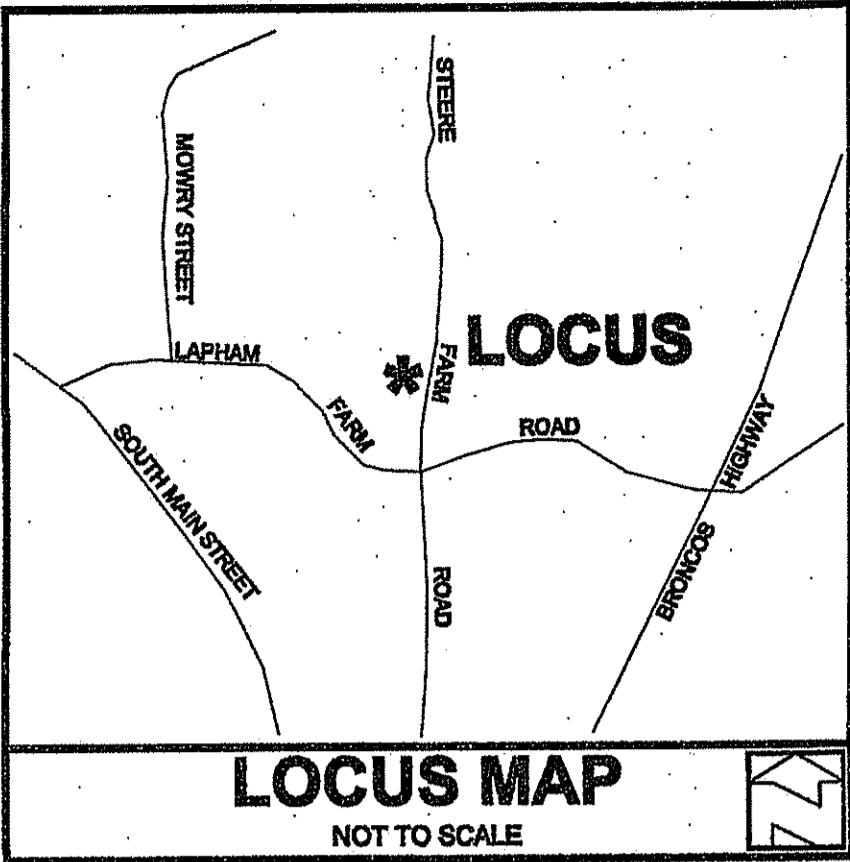


ZONING CRITERIA	
ZONING DISTRICT	R40
MINIMUM LOT AREA	40,000 SQ. FT.
MINIMUM LOT FRONTAGE	150'
MINIMUM FRONT YARD SETBACK	40'
MINIMUM SIDE YARD SETBACK	15'
MINIMUM REAR YARD SETBACK	40'
MAXIMUM BUILDING COVERAGE	15%
MAXIMUM BUILDING HEIGHT	35'

GENERAL NOTES:


1. THE LOCATION AND DEPTH OF EXISTING UTILITIES ARE APPROXIMATE AND HAVE BEEN PLOTTED FROM THE LATEST AVAILABLE INFORMATION. THE UTILITY LOCATIONS ARE APPROXIMATE AND MAY NOT BE ALL INCLUSIVE. THE CONTRACTOR SHALL CHECK AND VERIFY THE LOCATIONS OF ALL EXISTING UTILITIES, BOTH OVERHEAD AND UNDERGROUND, AND "DIG-SAFE" MUST BE NOTIFIED PRIOR TO COMMENCING ANY CONSTRUCTION OPERATIONS. RESTORATION AND REPAIR OF DAMAGE TO EXISTING UTILITIES SHALL BE THE RESPONSIBILITY OF THE CONTRACTOR WITH NO ADDITIONAL COST TO THE OWNER. NO EXCAVATION SHALL COMMENCE UNTIL ALL INVOLVED UTILITY COMPANIES AND/OR TOWN WHOSE FACILITIES MIGHT BE AFFECTED BY ANY WORK TO BE PERFORMED BY THE CONTRACTOR ARE NOTIFIED AT LEAST 72 HOURS IN ADVANCE.
2. THIS SITE LIES IN A ZONE X AS PER FIRM FLOOD INSURANCE RATE MAP PROVIDENCE COUNTY PANEL 136 OF 461 MAP NUMBER 4407C136G EFFECTIVE DATE MARCH 2 2009.
3. WETLANDS SHOWN HEREIN WERE DELINEATED BY NATURAL RESOURCE SERVICES INC. PO BOX 311 HARRISVILLE RHODE ISLAND ON APRIL 12 2017.
4. THIS SITE DOES NOT LIE WITHIN ANY KNOWN AGRICULTURAL USE, SILVICULTURAL USE, NATURAL HERITAGE OR FARMLAND CONSERVATION AREAS.
5. THERE ARE NO KNOWN EASEMENTS OR RIGHTS OF WAY WITHIN OR ADJACENT TO THIS PARCEL.
6. THE CONTOURS SHOWN HEREIN ARE BASED UPON NAVD 88 DATUM.
7. THERE ARE NO KNOWN HISTORIC CEMETERIES WITHIN OR IMMEDIATELY ADJACENT TO THIS PARCEL.
8. PREVIOUS RHODE ISLAND DEPARTMENT OF ENVIRONMENTAL MANAGEMENT APPLICATION NO. 99-0028, DATED APRIL 23, 1999.
9. AREA IS WITHIN THE A-80 AQUIFER OVERLAY DISTRICT AREA.
10. AREA IS WITHIN THE COMMUNITY WELLHEAD AREA.

REFERENCES:

1. PLAN ENTITLED: "PLAN OF LAND OWNED BY THOMAS V. & MICHELLE M. BLISS BURRILLVILLE RHODE ISLAND SCALE 1"=50' DATED JUNE 1989 SHEET ONE OF TWO" BY ROBERT C. COURNOYER & ASSOCIATES INC.
2. PLAN ENTITLED: "PLAN & PROFILE TO ACCOMPANY SEWER EXTENSION PERMIT FOR THOMAS V. & MICHELLE M. BLISS AP 212 LOT 14 605 STEERE FARM ROAD BURRILLVILLE RHODE ISLAND SCALE 1"=40' DATED APRIL 2000 SHEET 1 OF 2" BY NATIONAL SURVEYORS-DEVELOPERS INC.

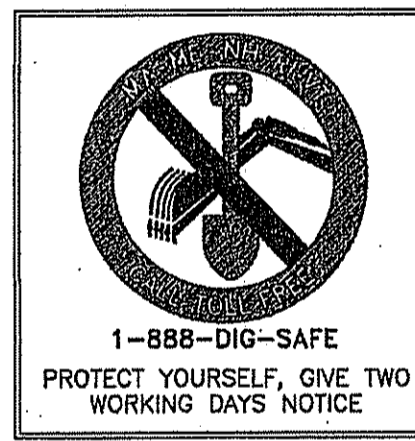

"I CERTIFY THAT THE INFORMATION SHOWN HEREON HAS BEEN OBTAINED BY AN ACTUAL SURVEY ON THE GROUND, THAT IT IS CORRECT AND THIS SURVEY AND PLAN CONFORM TO A CLASS I STANDARD AS ADOPTED BY THE RHODE ISLAND BOARD OF REGISTRATION FOR PROFESSIONAL LAND SURVEYORS.
 BY: *Norbert A. Therien*
 NORBERT A. THERIEN P.L.S.

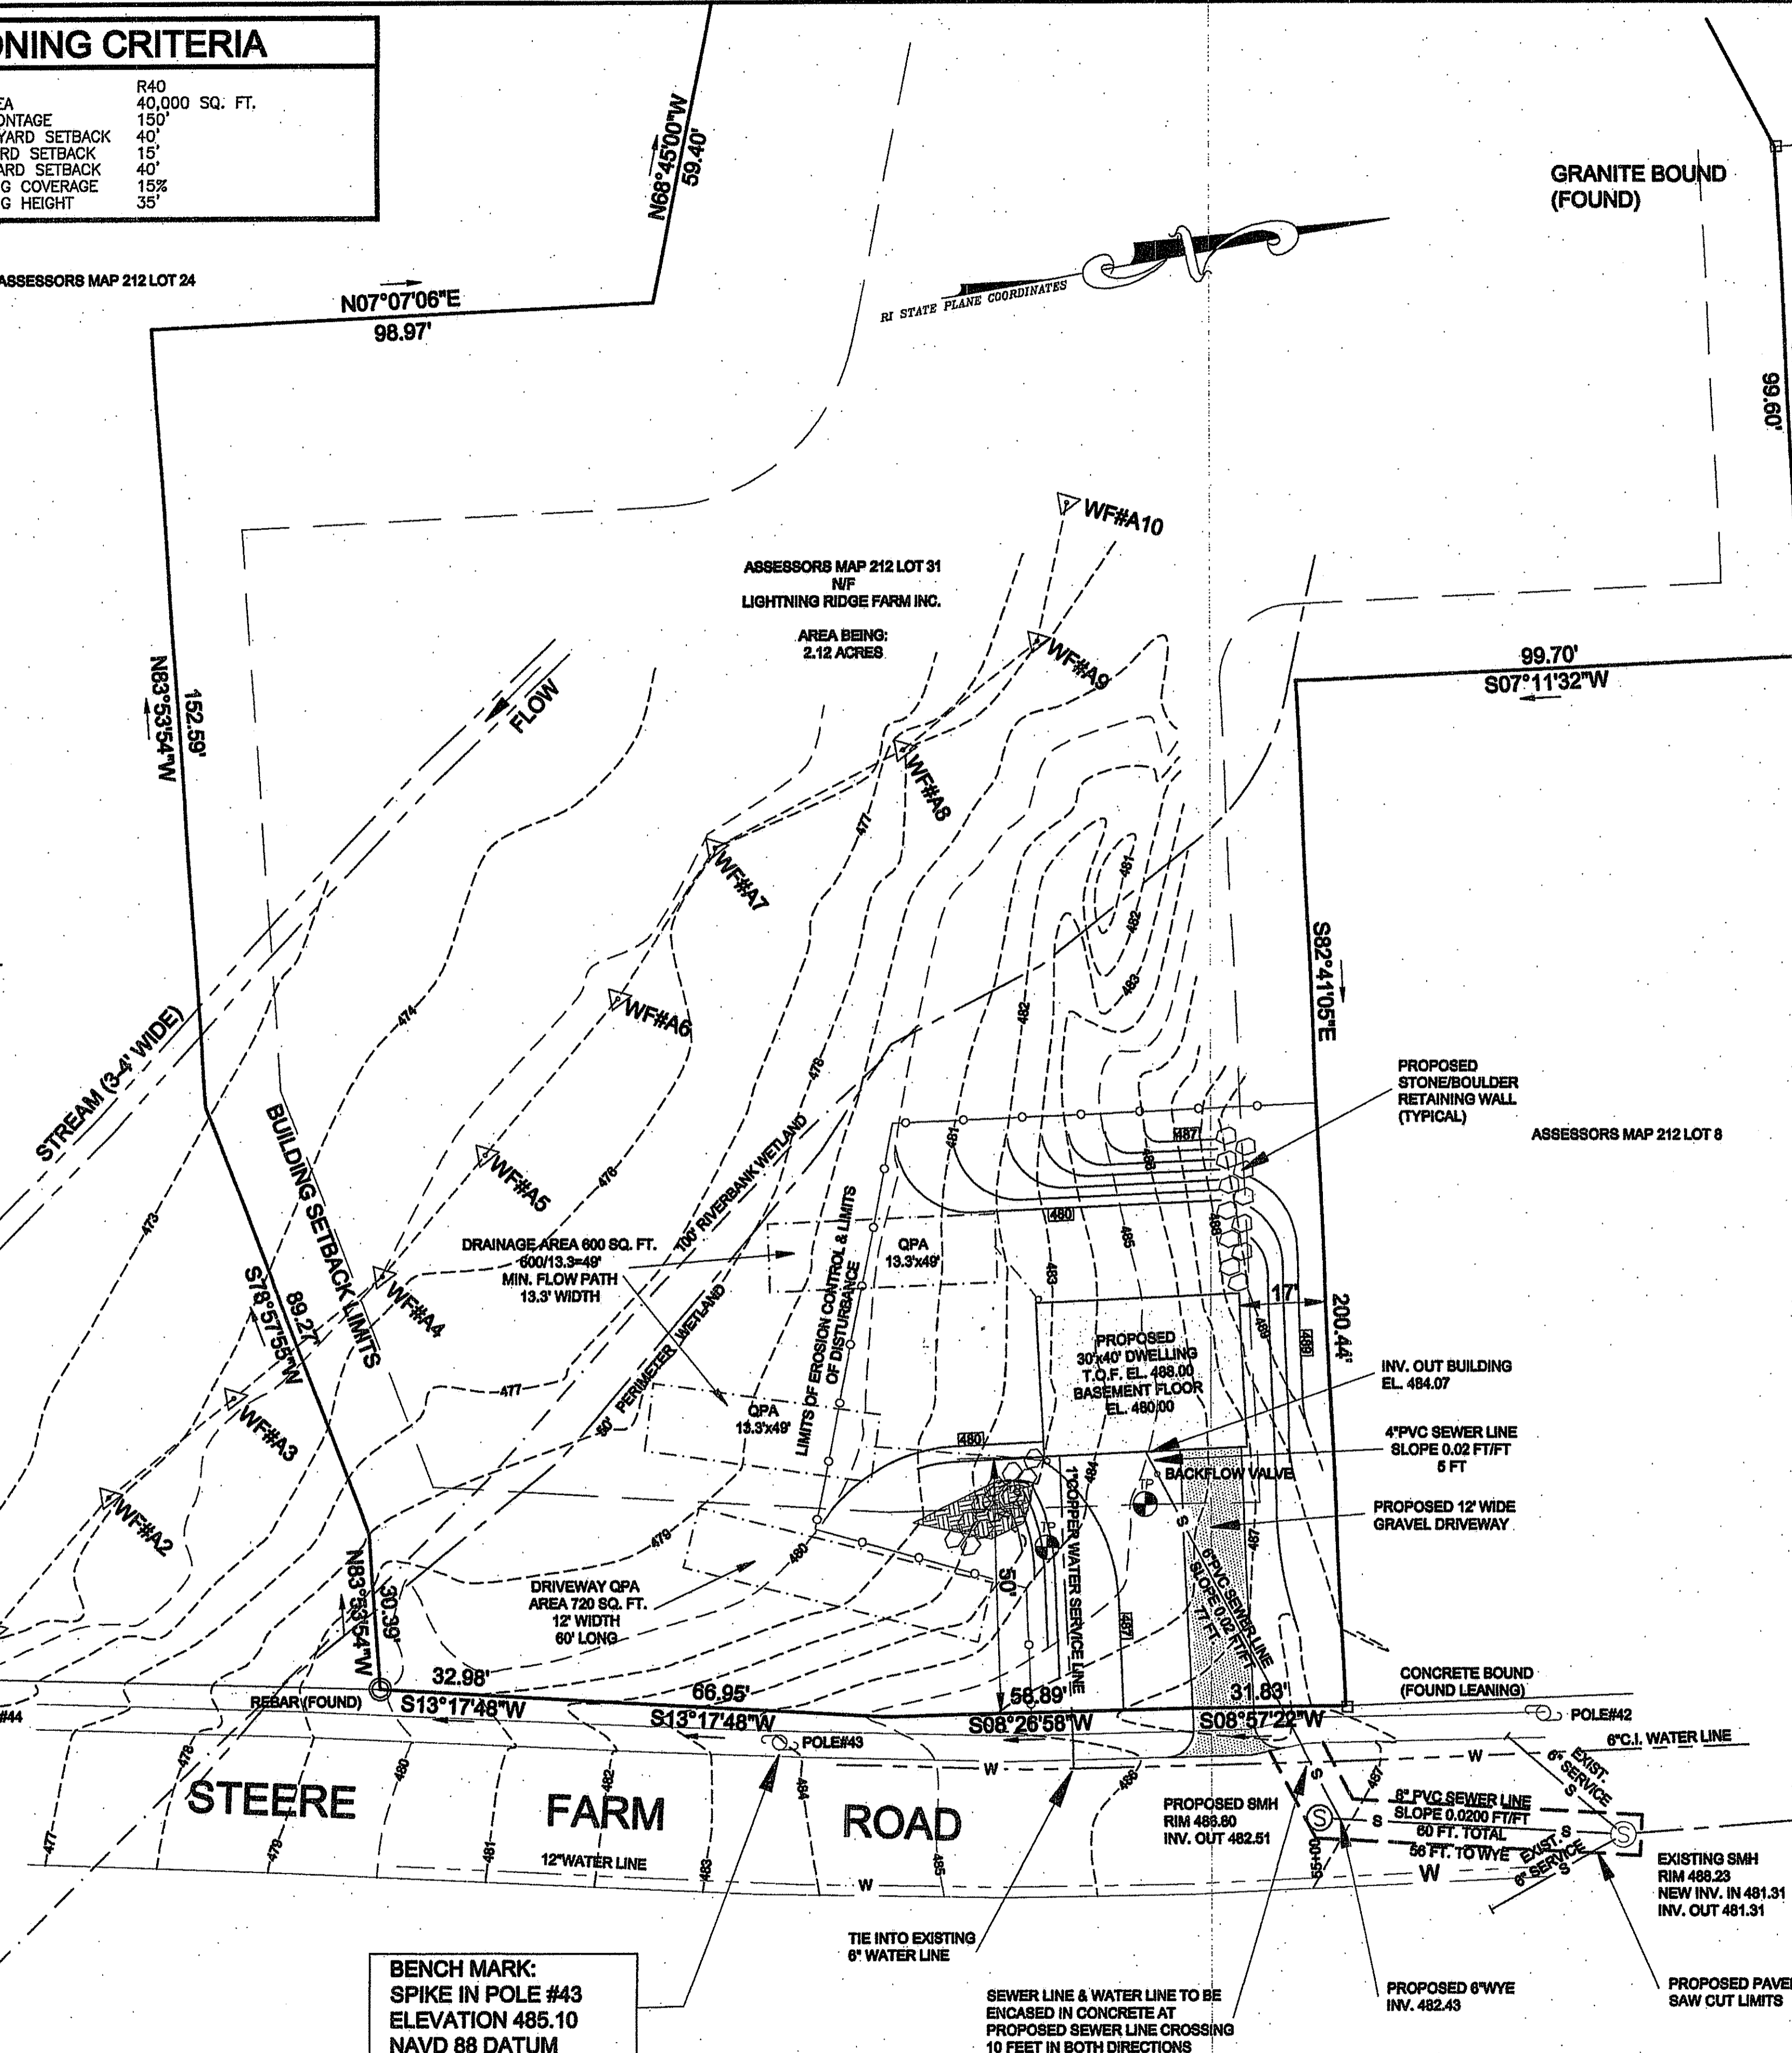

NO.	DATE	DESCRIPTION	BY

LEGEND	
	BOUNDARY
	ABUTTER
	MAJOR CONTOUR
	MINOR CONTOUR
	TREELINE
	WETLANDS EDGE
	60' PERIMETER WETLAND
	100' RIVERBANK WETLAND
	STREAM
	BUILDING ENVELOPE
	DRAINAGE LINE
	EXISTING SEWER LINE
	EXISTING WATER LINE
	PROPOSED SEWER LINE
	PROPOSED WATER LINE
	LIMITS OF DISTURBANCE/EROSION CONTROL
	IRON PIN
	BOUND
	DRILL HOLE
	UTILITY POLE
	WATER VALVE
	HYDRANT
	SOIL EVALUATION HOLE


Qualifying Pervious Areas (QPAs) are natural or restored upland vegetated areas that meet specific requirements such as maximum slope and soil characteristics, which can be used to infiltrate storm water runoff. The QPA must be inspected and maintained at least yearly to remove deposited sediment and address any ponding or erosion, and replant vegetation within the QPA that has died.

Kindly be advised that this Permit is not equivalent to a verification of the type or extent of freshwater wetlands on site.

DEPARTMENT OF ENVIRONMENTAL MANAGEMENT
 OFFICE OF WATER RESOURCES
 FRESHWATER WETLANDS PROGRAM
 REVIEWED SITE PLAN APPLICATION NO.: 17-0128
 DATED JUN 29 2017
 SEE LETTER OF SAME DATE.
Christopher D. Wencel

BENCH MARK:
 SPIKE IN POLE #44
 ELEVATION 477.41
 NAVD 88 DATUM

BENCH MARK:
 SPIKE IN POLE #43
 ELEVATION 485.10
 NAVD 88 DATUM

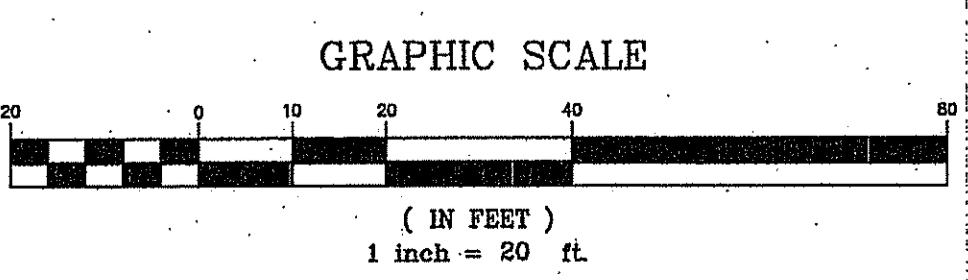

Thomas J. Principe, III
 REGISTERED PROFESSIONAL ENGINEER

NORBERT A. THERIEN
 No. 1739
 REGISTERED LAND SURVEYOR

NATIONAL Surveyors-Developers Inc.
 42 Hamlet Ave., Woonsocket, R.I. (401) 769-7779

LIGHTNING RIDGE FARM INC.
ASSESSORS MAP 212 LOT 31
STEERE FARM ROAD
BURRILLVILLE, RHODE ISLAND

PROPOSED CONDITIONS FOR SEWER EXTENSION PERMIT

DRAWN BY: W.C.R.	CHECKED BY: N.A.T.	FIELD BY: J.N.R.C.
MAY 2017	JOB No. 2017-75	SHEET 2 OF 3

JUN - 9 2017

SOIL EROSION AND SEDIMENTATION CONTROL NOTES:

THE HAYBALE AND SILT FENCE LINE ILLUSTRATED ON THESE PLANS SHALL SERVE AS THE STRICT LIMIT OF DISTURBANCE FOR THE PROJECT WITHIN OR ADJACENT TO REGULATED FRESHWATER WETLAND AREAS.

THE LIMITS OF CLEARING, GRADING, AND DISTURBANCE SHALL BE KEPT TO A MINIMUM WITHIN THE PROPOSED AREA OF CONSTRUCTION. ALL AREAS OUTSIDE OF THESE LIMITS, AS DEPICTED ON THE PLAN SHALL BE TOTALLY UNDISTURBED, TO REMAIN IN NATURAL CONDITION.

ALL CATCH BASINS SHALL BE PROTECTED WITH STAKED HAYBALES (R.I. STD. 9.8.0) DURING CONSTRUCTION ACTIVITIES. ALL PROPOSED STORMWATER DISCHARGE AREAS SHALL BE LINED WITH A RIPPAP SPLASH PAD AND PROTECTED WITH STAKED HAYBALE OUTLET PROTECTION (R.I. STD. 9.1.0), OR STAKED HAYBALE WITH SILT FENCE (R.I. STD. 9.3.0) SHALL ALSO BE INSTALLED AT ALL EXISTING STORMWATER DISCHARGE LOCATIONS WHERE DISTRIBUTING PIPES, CATCH BASINS, AND MANHOLES ARE TO BE CLEANED AND FLUSHED.

ALL DISTURBED SLOPES EITHER NEWLY CREATED OR CURRENTLY EXPOSED SHALL BE SEEDED, PROTECTED AND MAINTAINED BY THE CONTRACTOR. THE CONTRACTOR SHALL REGULARLY CHECK ALL SEEDED AREAS TO ENSURE THAT A GOOD STAND OF VEGETATION IS MAINTAINED.

ALL HAYBALES, TEMPORARY TREATMENT (HAY, STRAW, ETC.) AND TEMPORARY EROSION PROTECTION SHALL BE MAINTAINED BY THE CONTRACTOR THROUGHOUT CONSTRUCTION AND SHALL REMAIN IN PLACE UNTIL AN ACCEPTABLE STAND OF GRASS OR APPROVED GROUND COVER IS ESTABLISHED.

STOCKPILES OF TOPSOIL SHALL NOT BE LOCATED NEAR WATERWAYS OR WETLAND EDGES. THEY SHALL HAVE SIDE SLOPES OF NO GREATER THAN 2:1 AND SHALL BE TEMPORARILY SEEDED AND/OR STABILIZED PER CONTRACT SPECIFICATIONS.

THE HAYBALES SHALL BE CHECKED BY THE CONTRACTOR ON A WEEKLY BASIS AND AFTER EACH STORM FOR UNDERMINING OR DETERIORATION. THE CONTRACTOR SHALL REPAIR OR REPLACE ANY HAYBALES AS NEEDED. THE CONTRACTOR SHALL CLEAN THE ACCUMULATED SEDIMENT IF HALF OF THE ORIGINAL HEIGHT OF THE BALES BECOMES FILLED WITH SEDIMENTS.

IT SHALL BE THE RESPONSIBILITY OF THE CONTRACTOR TO MAINTAIN ALL SOIL EROSION AND SEDIMENT CONTROLS ON THE PROJECT SITE FOR THE ENTIRE DURATION OF THE CONSTRUCTION PERIOD. THE CONTRACTOR SHALL FOLLOW THE DIRECTION OF THE RESIDENT ENGINEER WITH REGARD TO INSTALLATION, MAINTENANCE, AND REPAIR OF ALL SOIL EROSION AND SEDIMENTATION CONTROLS ON THE PROJECT SITE. TEMPORARY SOIL EROSION AND SEDIMENTATION CONTROLS (HAYBALES, SILT FENCE, ETC.) SHALL BE MAINTAINED UNTIL ALL EXPOSED SOILS ARE SATISFACTORILY STABILIZED. THE CONTRACTOR SHALL BE RESPONSIBLE FOR REPAIRING AND/OR RESEEDING ALL AREAS THAT DO NOT DEVELOP WITHIN ONE YEAR FROM THE COMPLETION OF CONSTRUCTION.

ALL REFERENCED SOIL EROSION AND SEDIMENTATION CONTROLS INCLUDING MATERIALS USED, APPLICATION RATES AND THE INSTALLATION PROCEDURES SHALL BE PERFORMED PER THE "RHODE ISLAND EROSION AND SEDIMENTATION HANDBOOK", DATED 1993.

BMP MAINTENANCE SCHEDULE:

ALL MAINTENANCE (INCLUDING CLEANING) REQUIRED DURING THE CONSTRUCTION PHASE OF THE PROJECT SHALL BE THE RESPONSIBILITY OF THE CONTRACTOR AND SHALL INCLUDE:

INSPECTION OF ALL SLOPES, BERMS, AND OTHER CONTROL STRUCTURES (INCLUDING ROADWAY SIDE SLOPES, FOR STRUCTURAL INTEGRITY/STABILITY AND EVIDENCE OF SOIL EROSION PROCESSES, AND MAINTENANCE OF THESE STRUCTURES IF NECESSARY. INSPECTIONS SHALL BE PERFORMED FOLLOWING ALL RAIN EVENTS OF 1/4 INCH RAINFALL OR MORE IN A 24-HOUR PERIOD, OR BI-MONTHLY IF NO RAINFALL EVENT OCCURS.

REPLANTING, REGRADING, OR OTHER REPAIRS NEEDED AS A RESULT OF SOIL EROSION AND SEDIMENTATION PROCESSES SHALL BE DONE PROMPTLY.

SITE PLAN NOTES:

DETAILED ENGINEERING REVIEW FOR PROPOSED UTILITIES COVERED UNDER SEPARATE SUBMISSION, TO GOVERNING AGENCIES. THE DETAILED ENGINEERING PLANS FOR UTILITIES INSTALLATION AND CONNECTION HAVE NOT BEEN PROVIDED UNDER THIS SUBMISSION.

THE LOCATION AND DEPTH OF EXISTING UTILITIES ARE APPROXIMATE AND HAVE BEEN PLOTTED FROM THE LATEST AVAILABLE INFORMATION. THE UTILITY LOCATIONS ARE APPROXIMATE AND MAY NOT BE ALL INCLUSIVE. THE CONTRACTOR SHALL CHECK AND VERIFY THE LOCATIONS OF ALL EXISTING UTILITIES, BOTH OVERHEAD AND UNDERGROUND, AND "DIG-SAFE" MUST BE NOTIFIED PRIOR TO COMMENCING ANY CONSTRUCTION OPERATIONS. RESTORATION AND REPAIR OF DAMAGE TO EXISTING UTILITIES SHALL BE THE RESPONSIBILITY OF THE CONTRACTOR WITH NO ADDITIONAL COST TO THE OWNER. NO EXCAVATION SHALL COMMENCE UNTIL ALL INVOLVED UTILITY COMPANIES AND/OR TOWN WHOSE FACILITIES MIGHT BE AFFECTED BY ANY WORK TO BE PERFORMED BY THE CONTRACTOR ARE NOTIFIED AT LEAST 72 HOURS IN ADVANCE.

MAINTENANCE AND PROTECTION OF TRAFFIC NOTES:

THE CONTRACTOR SHALL BE RESPONSIBLE FOR ALL MAINTENANCE AND PROTECTION OF PEDESTRIAN AND VEHICULAR TRAFFIC INCLUDING POLICE PROTECTION. ALL TEMPORARY AND VEHICULAR SIGNS, BARRICADES AND LANE CLOSURES SHALL BE IN CONFORMANCE WITH THE LATEST REVISIONS OF MANUAL OF UNIFORM TRAFFIC CONTROL DEVICES (M.U.T.C.D.)

TEMPORARY CONSTRUCTION SIGNS AND ALL APPLICABLE TRAFFIC CONTROL DIVIDES SHALL BE IN PLACE PRIOR TO THE START OF WORK IN ANY AREA OPEN TO TRAFFIC.

THE PRIVATE VEHICLES OF CONSTRUCTION WORKERS WILL NOT BE PARKED IN THE STATE RIGHT-OF-WAY.

ALL MAINTENANCE AND PROTECTION OF TRAFFIC CONTROL SETUPS, SIGNS CHANNING DEVICES, ETC. SHALL BE IN ACCORDANCE WITH THE MANUAL ON UNIFORM TRAFFIC CONTROL DEVICES. 1988 EDITION, INCLUDING REVISION 3, SEPTEMBER 5, 1993 AND SUBSEQUENT ADDENDA.

SIGN MOUNTINGS SHALL BE IN ACCORDANCE WITH THE R.I.D.O.T. SPECIFICATIONS FOR TEMPORARY CONSTRUCTION SIGNS.

ESTABLISHMENT OF VEGETATIVE COVER:

ALL FILL SHALL BE THOROUGHLY COMPACTED UPON PLACEMENT IN STRICT CONFORMANCE WITH THE R.I. STANDARD SPECIFICATION FOR ROAD AND BRIDGE CONSTRUCTION, SECTION 202.


SLOPES SHALL NOT BE LEFT UNATTENDED OR EXPOSED FOR EXCESSIVE PERIODS OF TIME SUCH AS THE INACTIVE WINTER SEASON.

THE TOPSOIL SHALL HAVE A SANDY LOAM TEXTURE RELATIVELY FREE OF SUBSOIL MATERIAL, STONES, ROOTS, LUMPS OF SOIL, TREE LIMBS, TRASH OR CONSTRUCTION DEBRIS AND SHALL CONFORM TO RHODE ISLAND STANDARD SPECIFICATION A.30.









THE SEED MIX TO BE USED ON SLOPE APPROACHING WETLAND SHALL BE THE NEW ENGLAND CONSERVATION/WILDLIFE MIX FROM NEW ENGLAND WETLAND PLANTS, INC. OR APPROVED EQUAL APPLIED AT A RATE OF 25 LBS. PER ACRE AND MULCHED WITH STRAW.

EARLY SPRING OR LATE SUMMER SEEDING IS RECOMMENDED. LIME AND FERTILIZE AS REQUIRED BY SOIL TESTING TO COMPLIMENT OR UPGRADE EXISTING CONDITIONS.

NO.	DATE	DESCRIPTION	BY

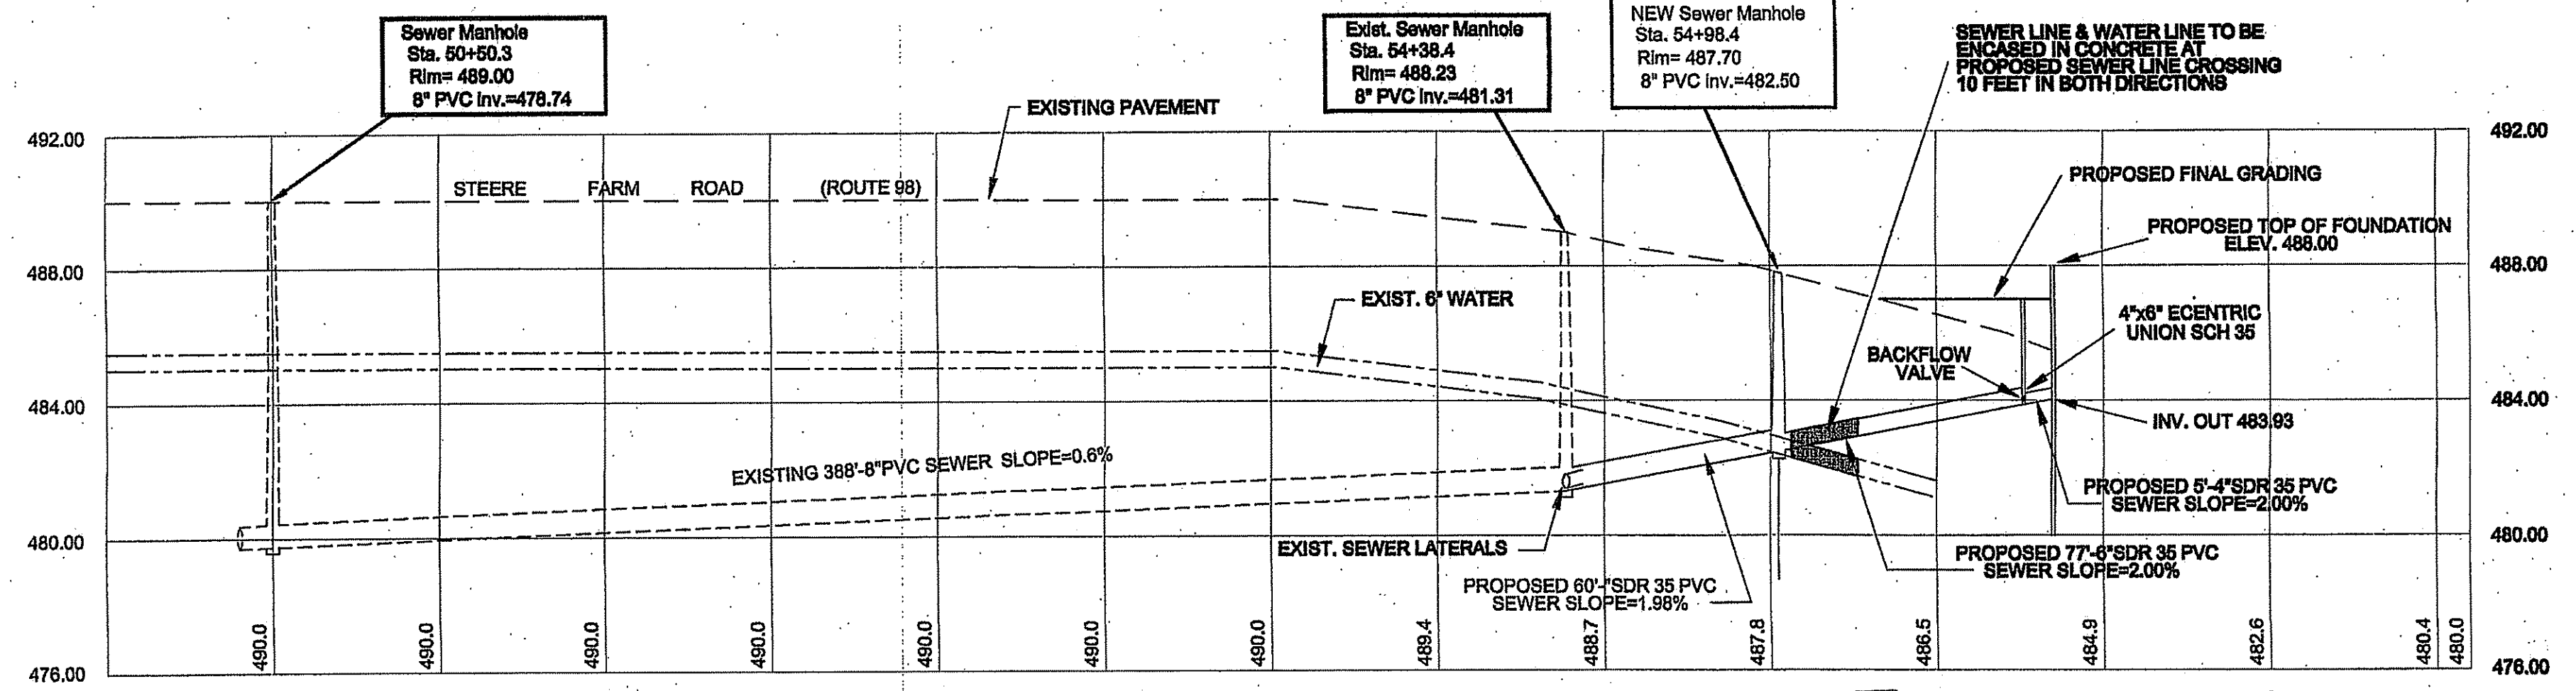

DEPARTMENT OF ENVIRONMENTAL MANAGEMENT
OFFICE OF WATER RESOURCES
FRESHWATER WETLANDS PROGRAM
REVIEWED SITE PLAN APPLICATION NO.: 17-013
DATED: 5/10/2017
SEE LETTER OF SAME DATE

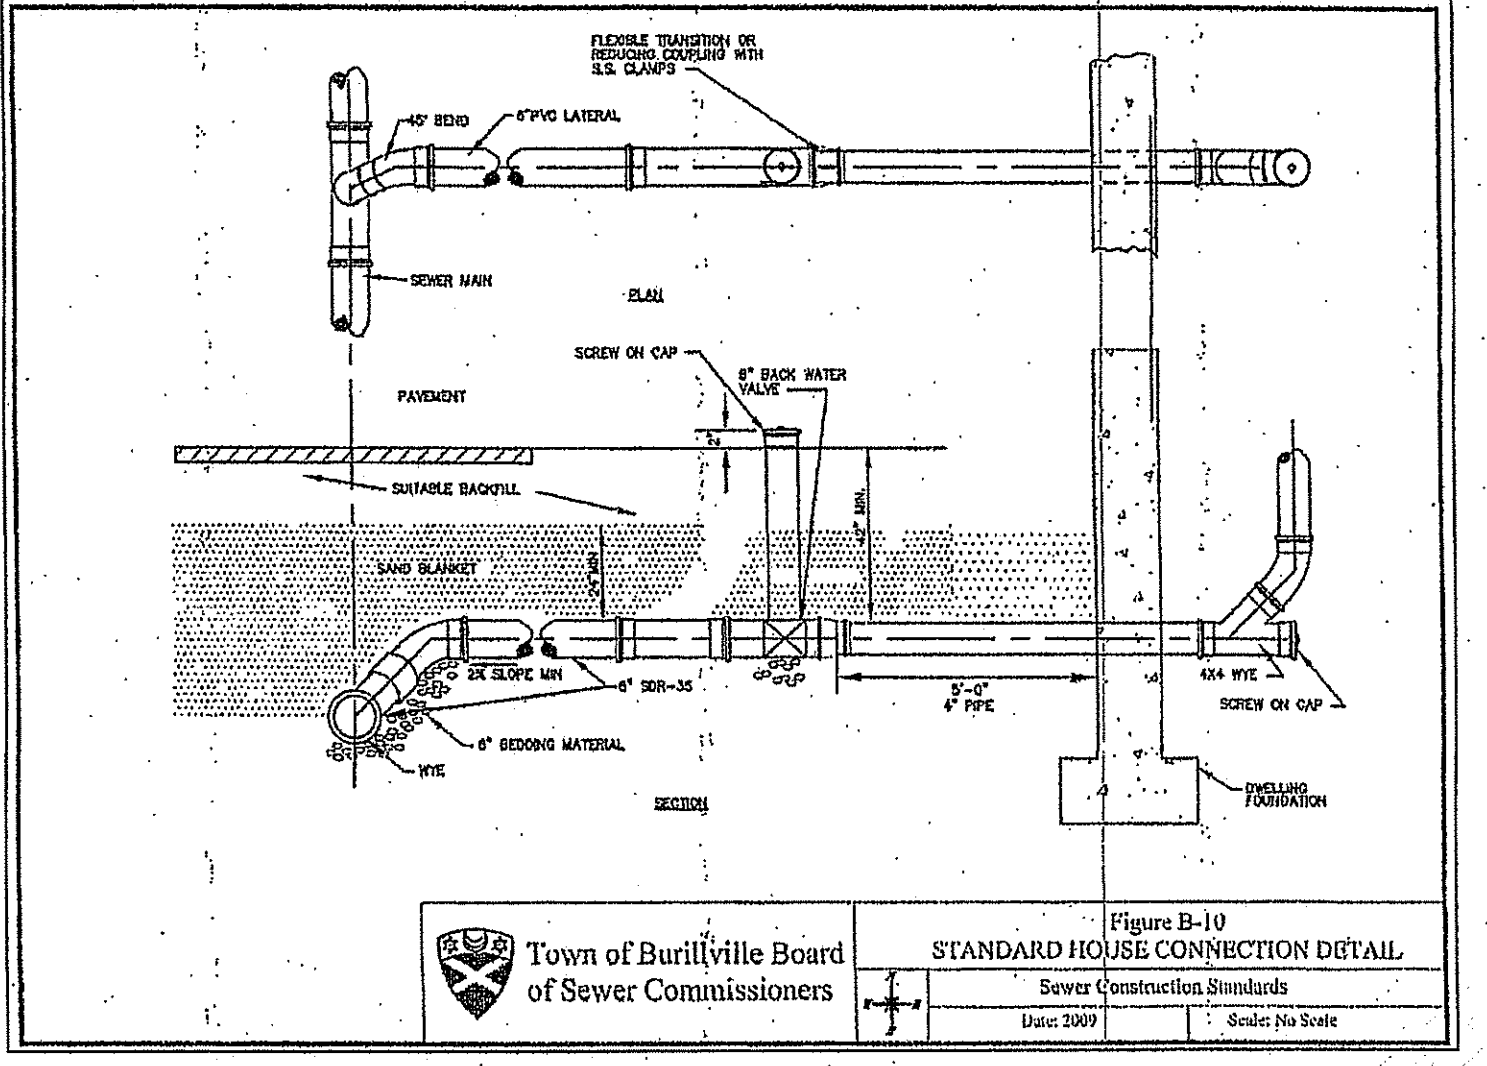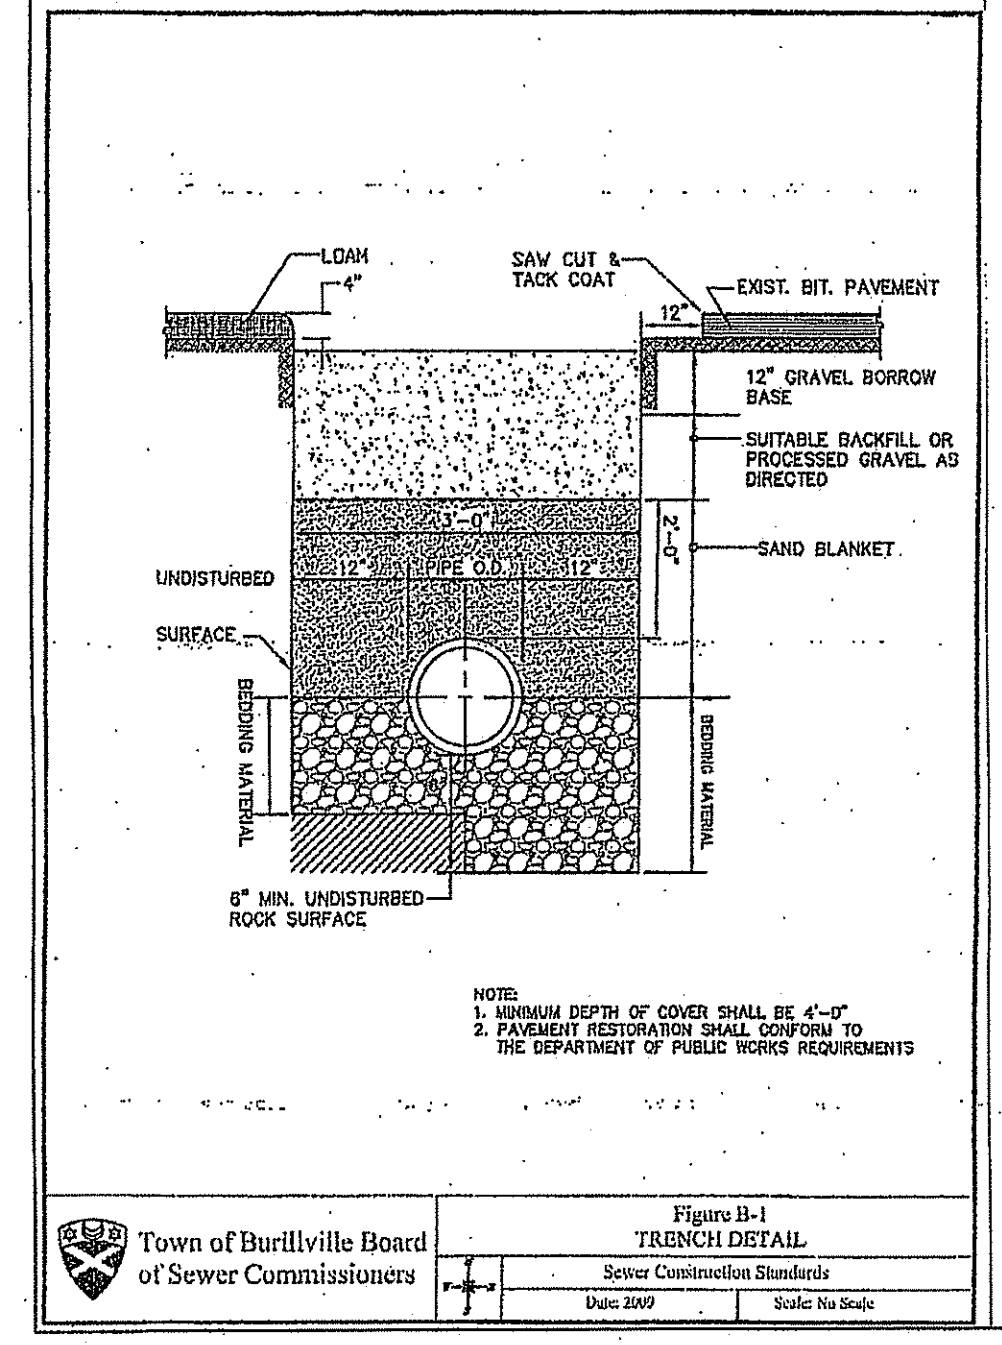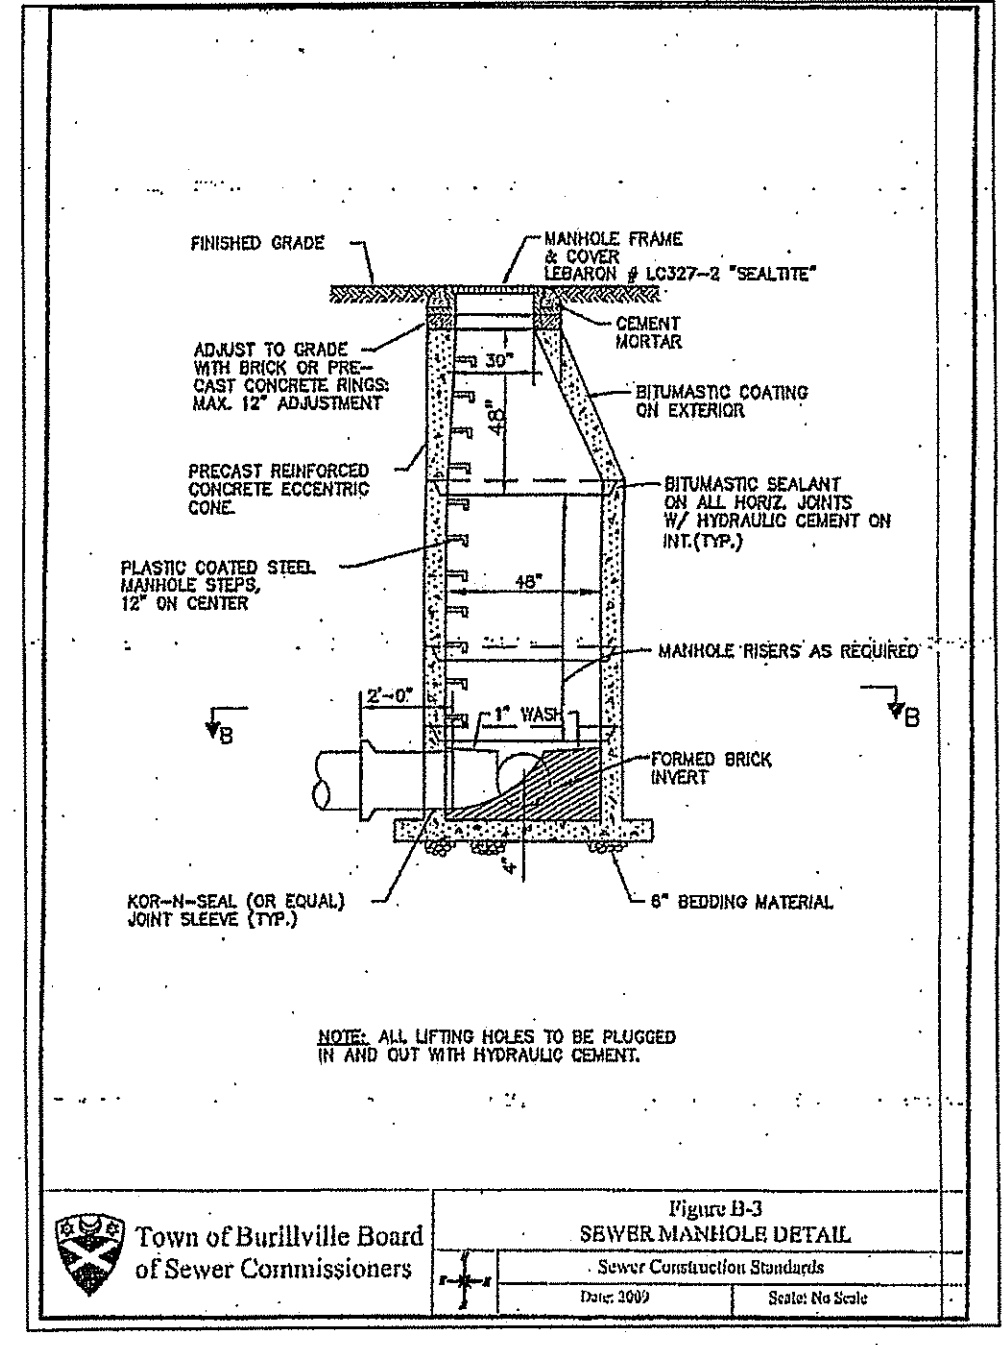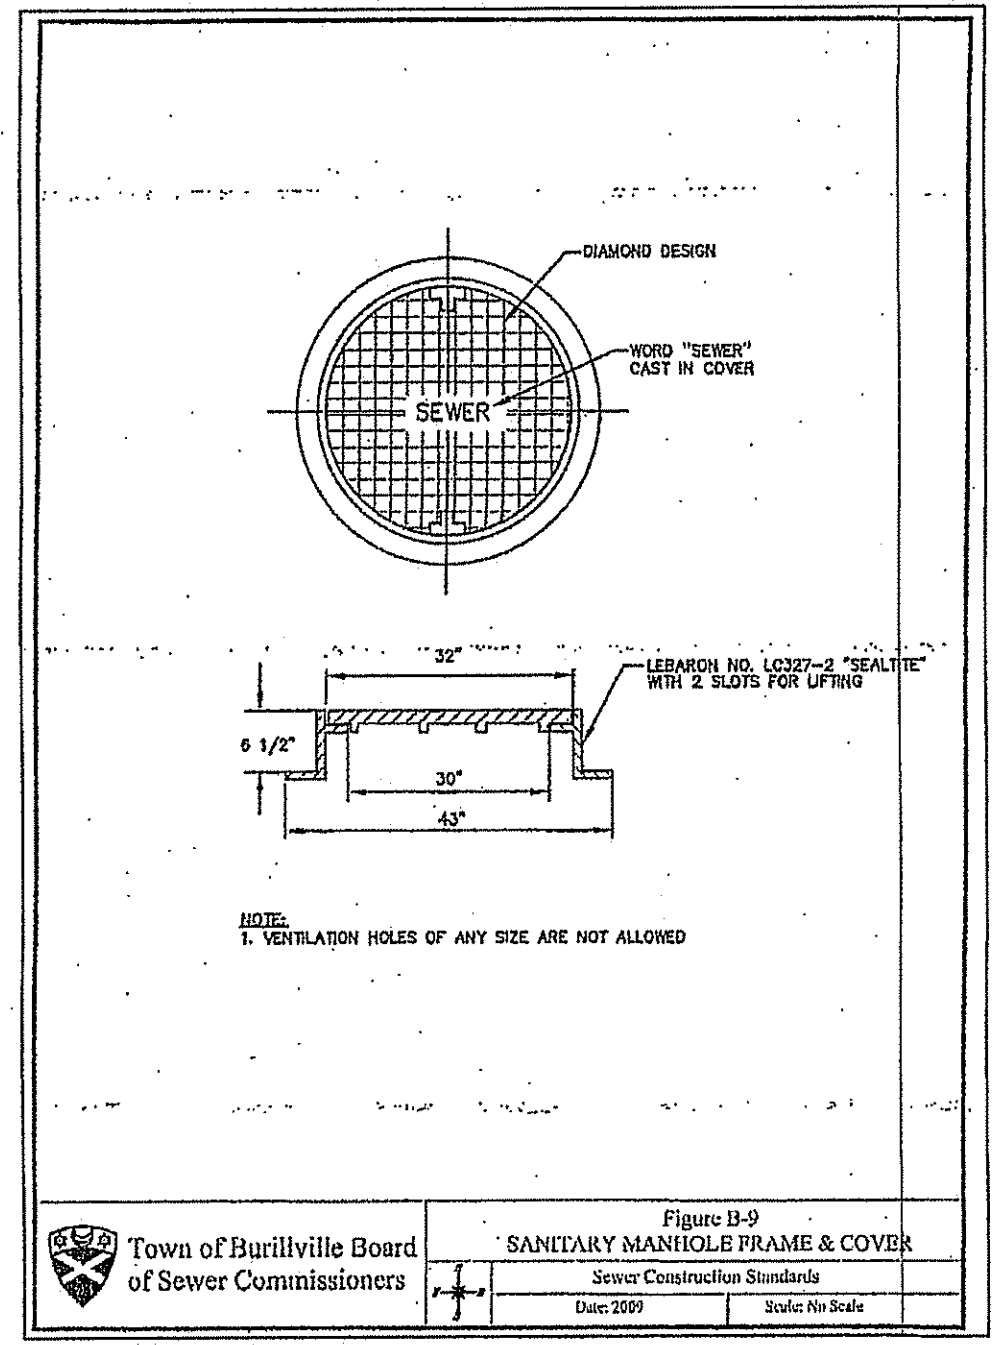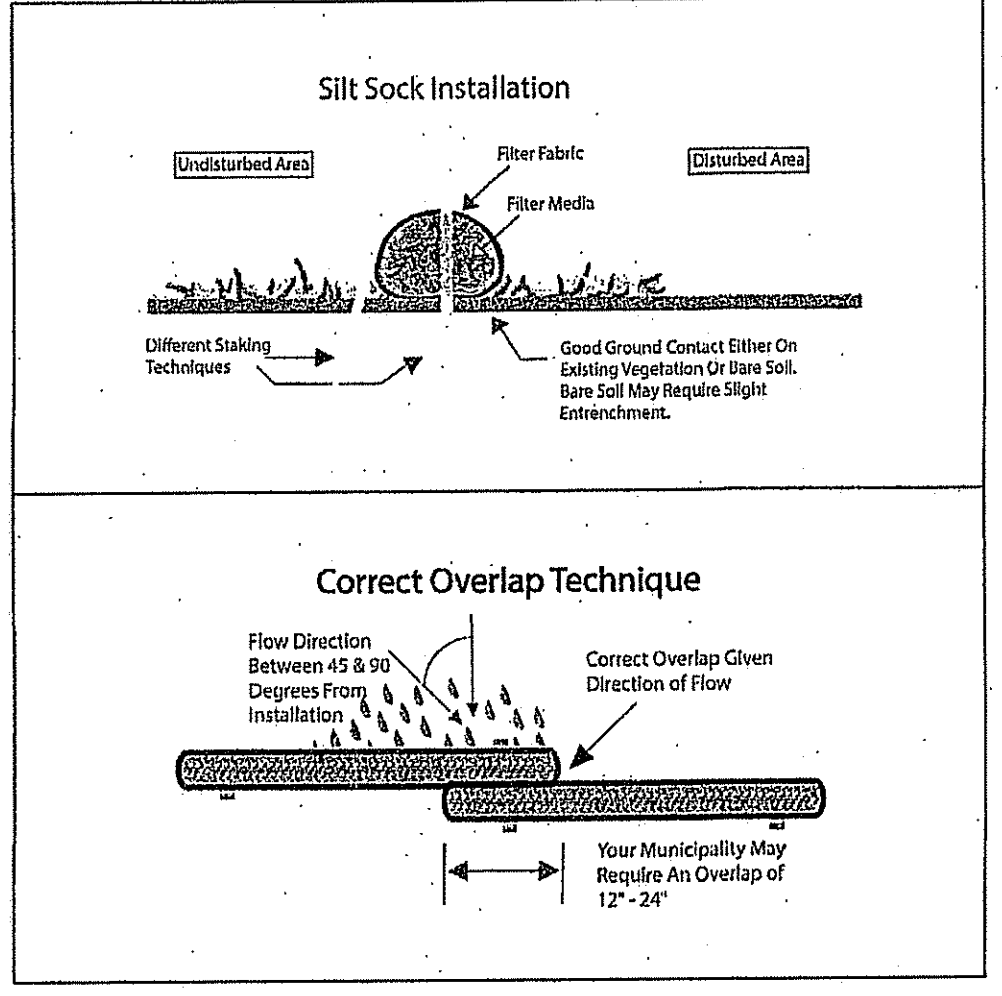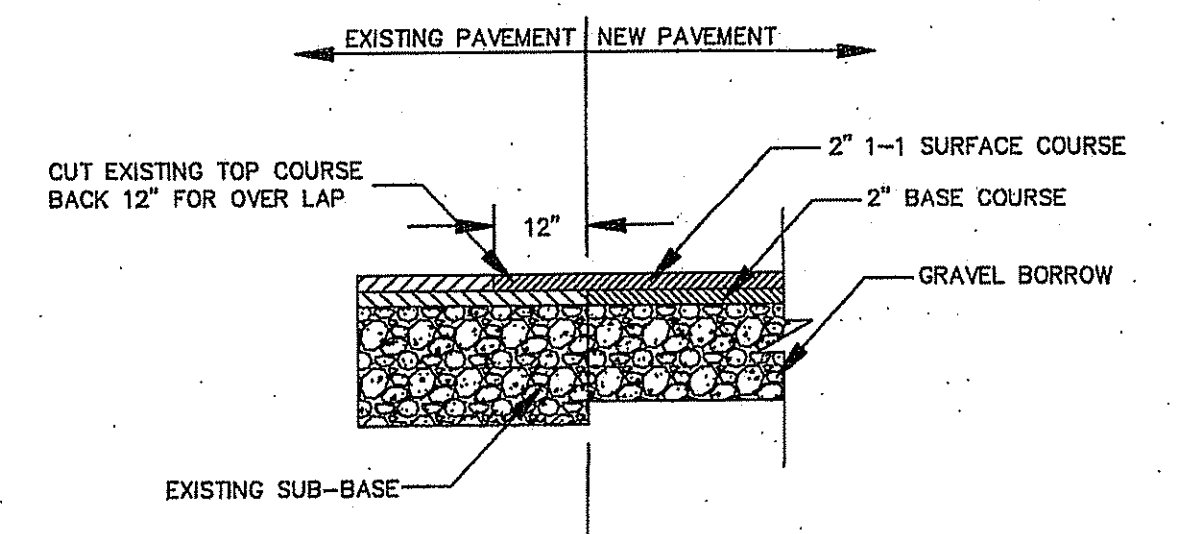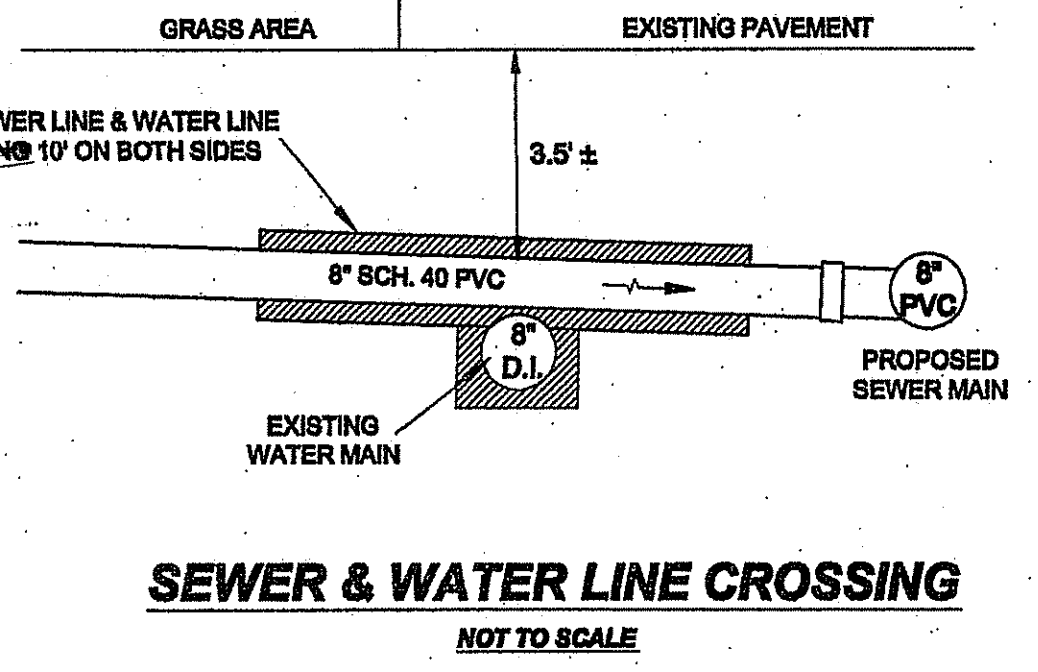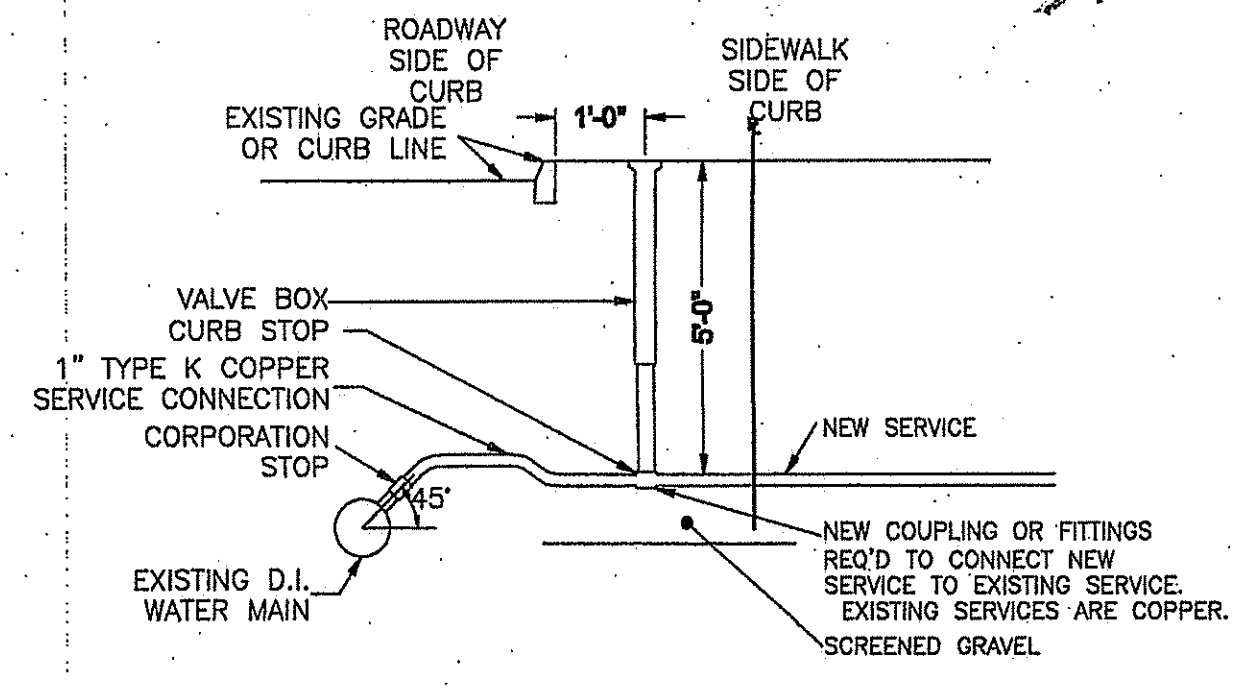

NATIONAL Surveyors-Developers Inc.
42 Hamlet Ave., Woonsocket, R.I. (401) 769-7779

NORBERT A. THERIEN
No. 1739
REGISTERED PROFESSIONAL LAND SURVEYOR

Thomas J. Principe, III
REGISTERED PROFESSIONAL ENGINEER

I CERTIFY THAT THE INFORMATION SHOWN HEREON HAS BEEN OBTAINED BY AN ACTUAL SURVEY ON THE GROUND, THAT IT IS CORRECT AND THIS SURVEY AND PLAN CONFORM TO A CLASS 1 STANDARD AS ADOPTED BY THE RHODE ISLAND BOARD OF REGISTRATION FOR PROFESSIONAL LAND SURVEYORS.

BY: *Norbert A. Therien*
NORBERT A. THERIEN P.L.S.

LIGHTNING RIDGE FARM INC.
ASSESSORS MAP 212 LOT 31
STEERE FARM ROAD
BURRILLVILLE, RHODE ISLAND

DETAILS

DRAWN BY: W.C.R. CHECKED BY: N.A.T. FIELD BY: J.N.R.C.
MAY 2017 JOB No. 2017-75 SHEET 3 OF 3