



NOTE: IN ALL AREAS OF CUTTING, CUTS SHALL EXTEND 6 INCHES BELOW TOP OF SUBGRADE AND THEN FILLED WITH 6 INCHES OF SUBGRADE SOIL.

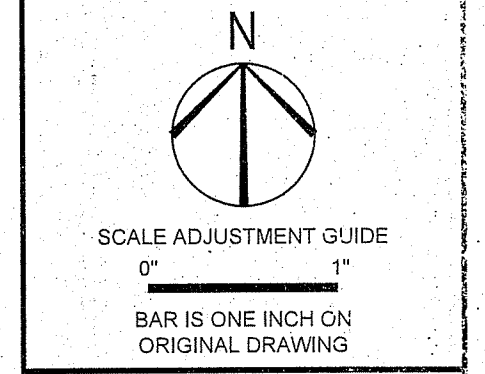

Environmental  
MAR 11 2021  
Office of Water Resources

**Tiverton Landfill Closure**  
AP 707 / Lots 101 & 106  
Town of Tiverton  
50 Industrial Way, Tiverton, RI

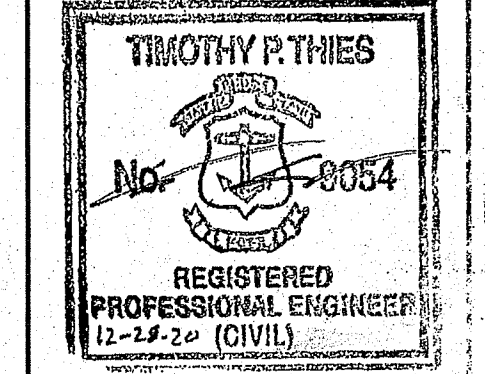

DEPARTMENT OF ENVIRONMENTAL MANAGEMENT  
OFFICE OF WATER RESOURCES  
FRESHWATER WETLANDS PROGRAM  
APPROVED WITH CONDITIONS  
AS SPECIFIED IN THE LETTER OF APPROVAL  
DATED APR 10 2021 FILE # 18-0120  
NO CHANGES ALLOWED WITHOUT PRIOR APPROVAL  
APPROVED PLANS MUST BE AT CONSTRUCTION SITE

*Timothy P. Rhyes*

REVISIONS:	DATE	DESCRIPTION
1	12/28/20	GRADING REVISIONS

PROJECT NO.: 04130-1  
DATE: JULY 2020  
SCALE: 1"=80'  
DESIGNED BY: TCJ  
CHECKED BY: SPD  
DRAWN BY: TCI  
APPROVED BY: TPT  
DRAWING TITLE:  
**GENERAL LAYOUT & GRADING PLAN**  
DRAWING NO.:  
**C4.0**  
SHEET NO. 6 OF 14

# Tiverton Landfill Closure

3524 Main Road  
A.P. 707 / Lots 101 & 106  
Tiverton, Rhode Island

Prepared For:  
**TOWN OF TIVERTON**  
50 Industrial Way  
Tiverton, Rhode Island

  
**PARE**  
PARE CORPORATION  
ENGINEERS - SCIENTISTS - PLANNERS  
8 BLACKSTONE VALLEY PLACE  
LINCOLN, RI 02865  
401-334-4100





Locus Plan  
SCALE: 1"=500'

**RIDEM PERMIT SUBMISSION**  
Pare Project No. 94139.01  
July 2020

## Index of Drawings

Sheet No.	Dwg. No.	Description
1	C0.0	COVER SHEET
2	C1.0	EXISTING CONDITIONS PLAN
3	C2.0	GENERAL NOTES & LEGEND
4	C3.0	EROSION & SEDIMENT CONTROL PLAN
5	C3.1	PHASING PLAN
6	C4.0	GENERAL LAYOUT & GRADING PLAN
7	C5.0	LANDFILL CUT & FILL PLAN (NOT INCLUDED)
8	C6.0	DRAINAGE & UTILITY PLAN
9	C7.0	LANDFILL GAS CONTROL SYSTEM & MONITORING WELL INSTALLATION PLAN
10-14	C8.0-C8.4	DETAILS NO. 1 - 5

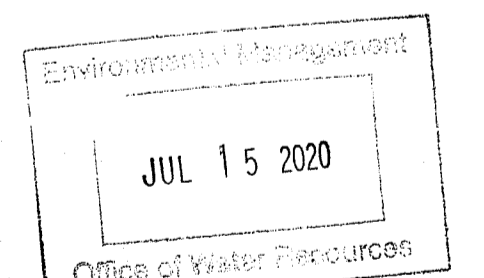  
DEPARTMENT OF ENVIRONMENTAL MANAGEMENT  
OFFICE OF WATER RESOURCES  
FRESHWATER WETLANDS PROGRAM  
APPROVED WITH CONDITIONS  
AS SPECIFIED IN THE LETTER OF APPROVAL  
DATED AUG 27 2020 FILE # 18-0120  
NO CHANGES ALLOWED WITHOUT PRIOR APPROVAL  
APPROVED PLANS MUST BE AT CONSTRUCTION SITE  
*Nancy Freeman*

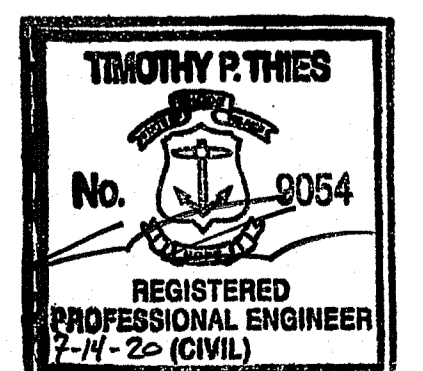















Environmental Management  
 JUNE 15 2020  
 State of Rhode Island  
 Department of Environmental Management

**TIMOTHY P. THIES**  
 No. 9054  
 REGISTERED PROFESSIONAL ENGINEER  
 7-11-22 (CIVIL)


REVISIONS:

NO.	DATE	DESCRIPTION


PROJECT NO.: 94139.01  
 DATE: JULY 2020  
 SCALE: AS NOTED  
 DESIGNED BY: TCJ  
 CHECKED BY: SPD  
 DRAWN BY: TCJ  
 APPROVED BY: TPT  
 DRAWING TITLE:

DETAILS  
 NO. 1


DRAWING NO.: **C8.0**  
 SHEET NO. 10 OF 14

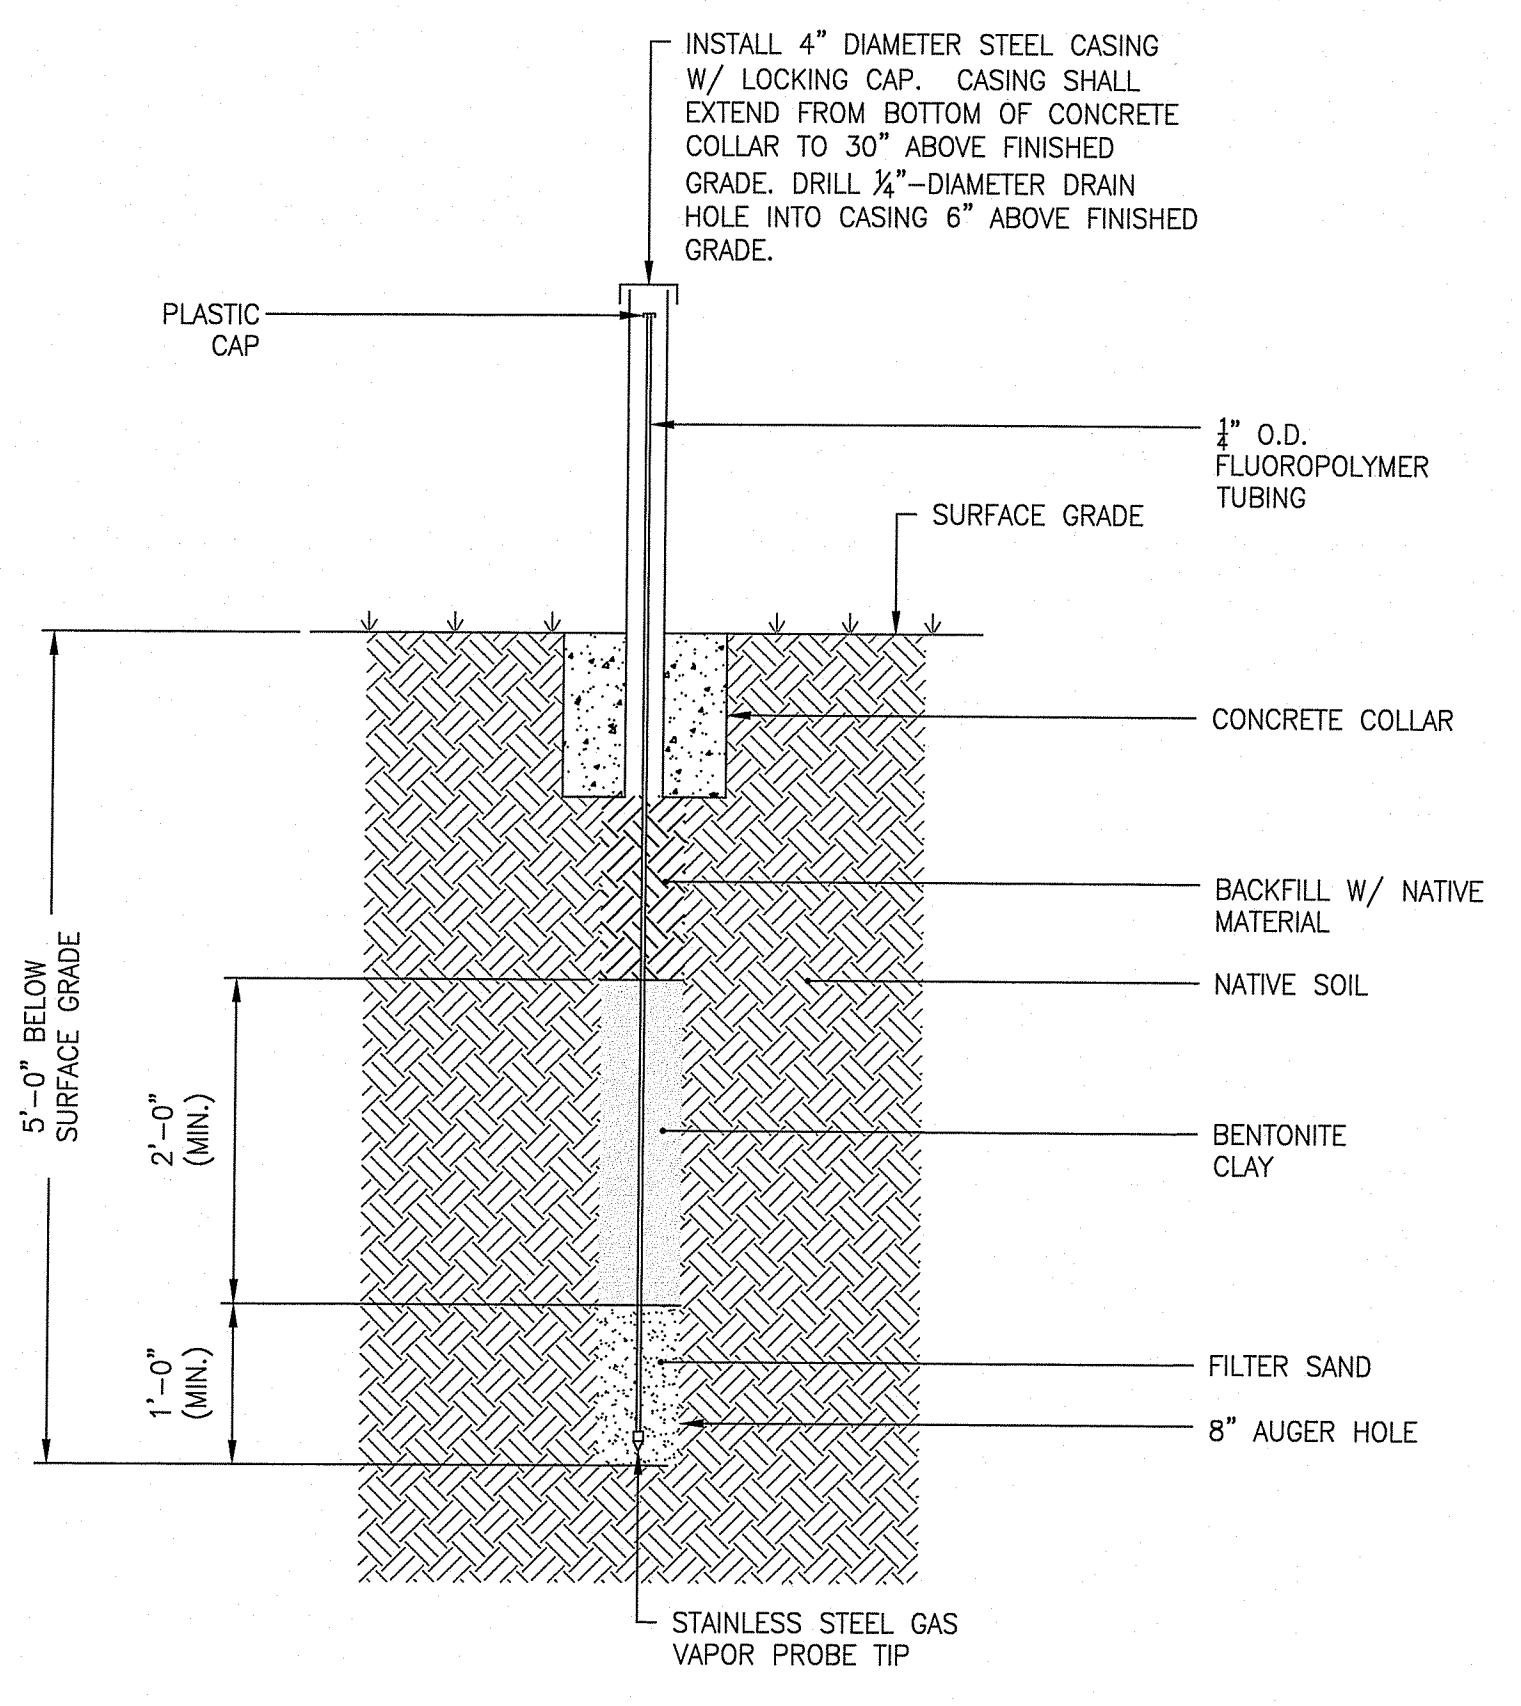


**PERIMETER SOIL GAS PROBE DETAIL**  
 NOT TO SCALE

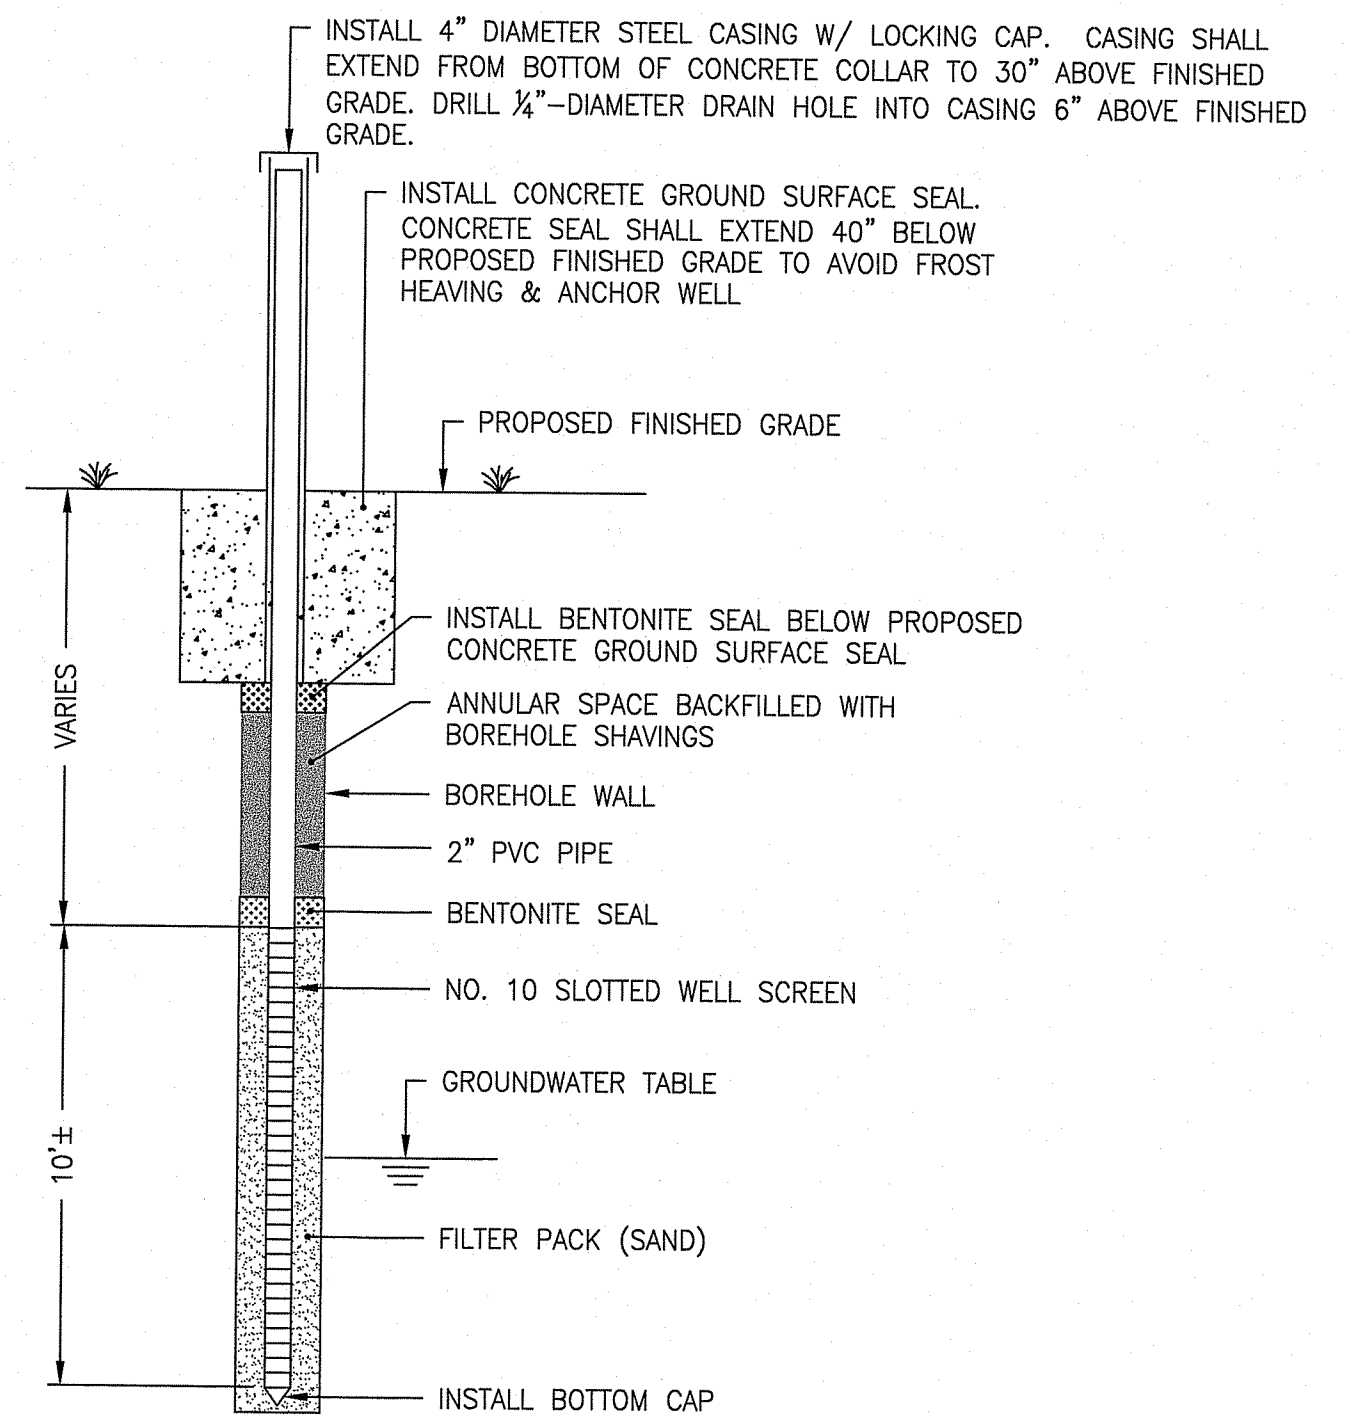


**MONITORING WELL INSTALLATION DETAIL**  
 NOT TO SCALE

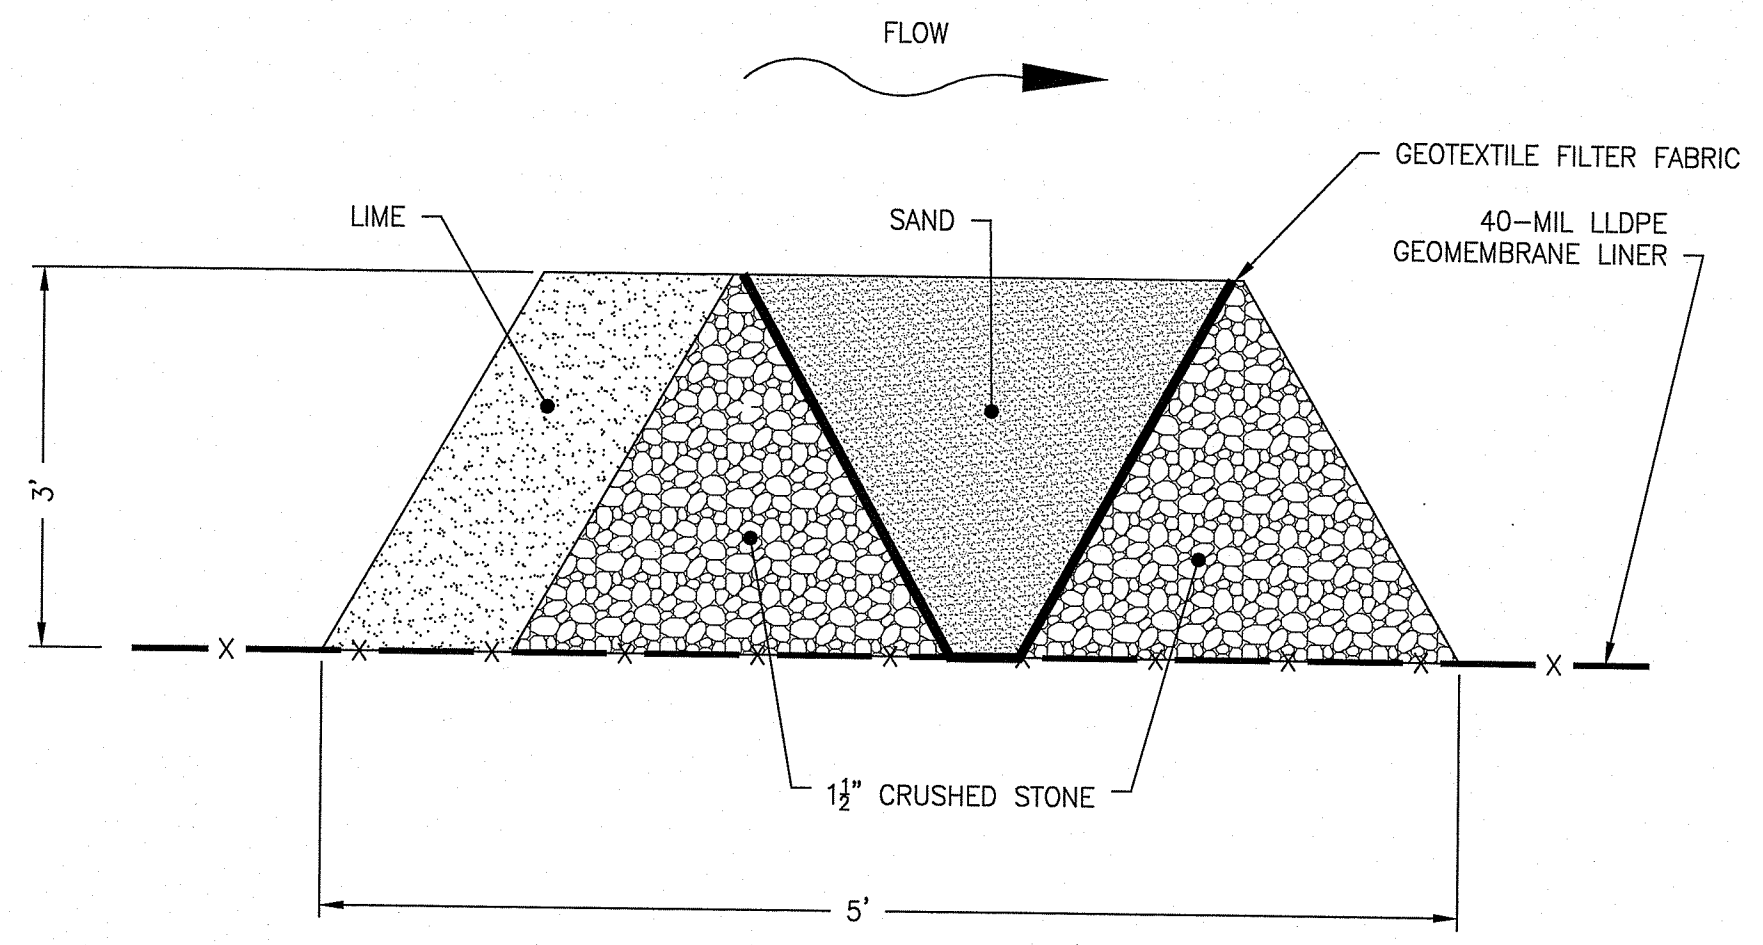


**SAND FILTER DETAIL**  
 NOT TO SCALE

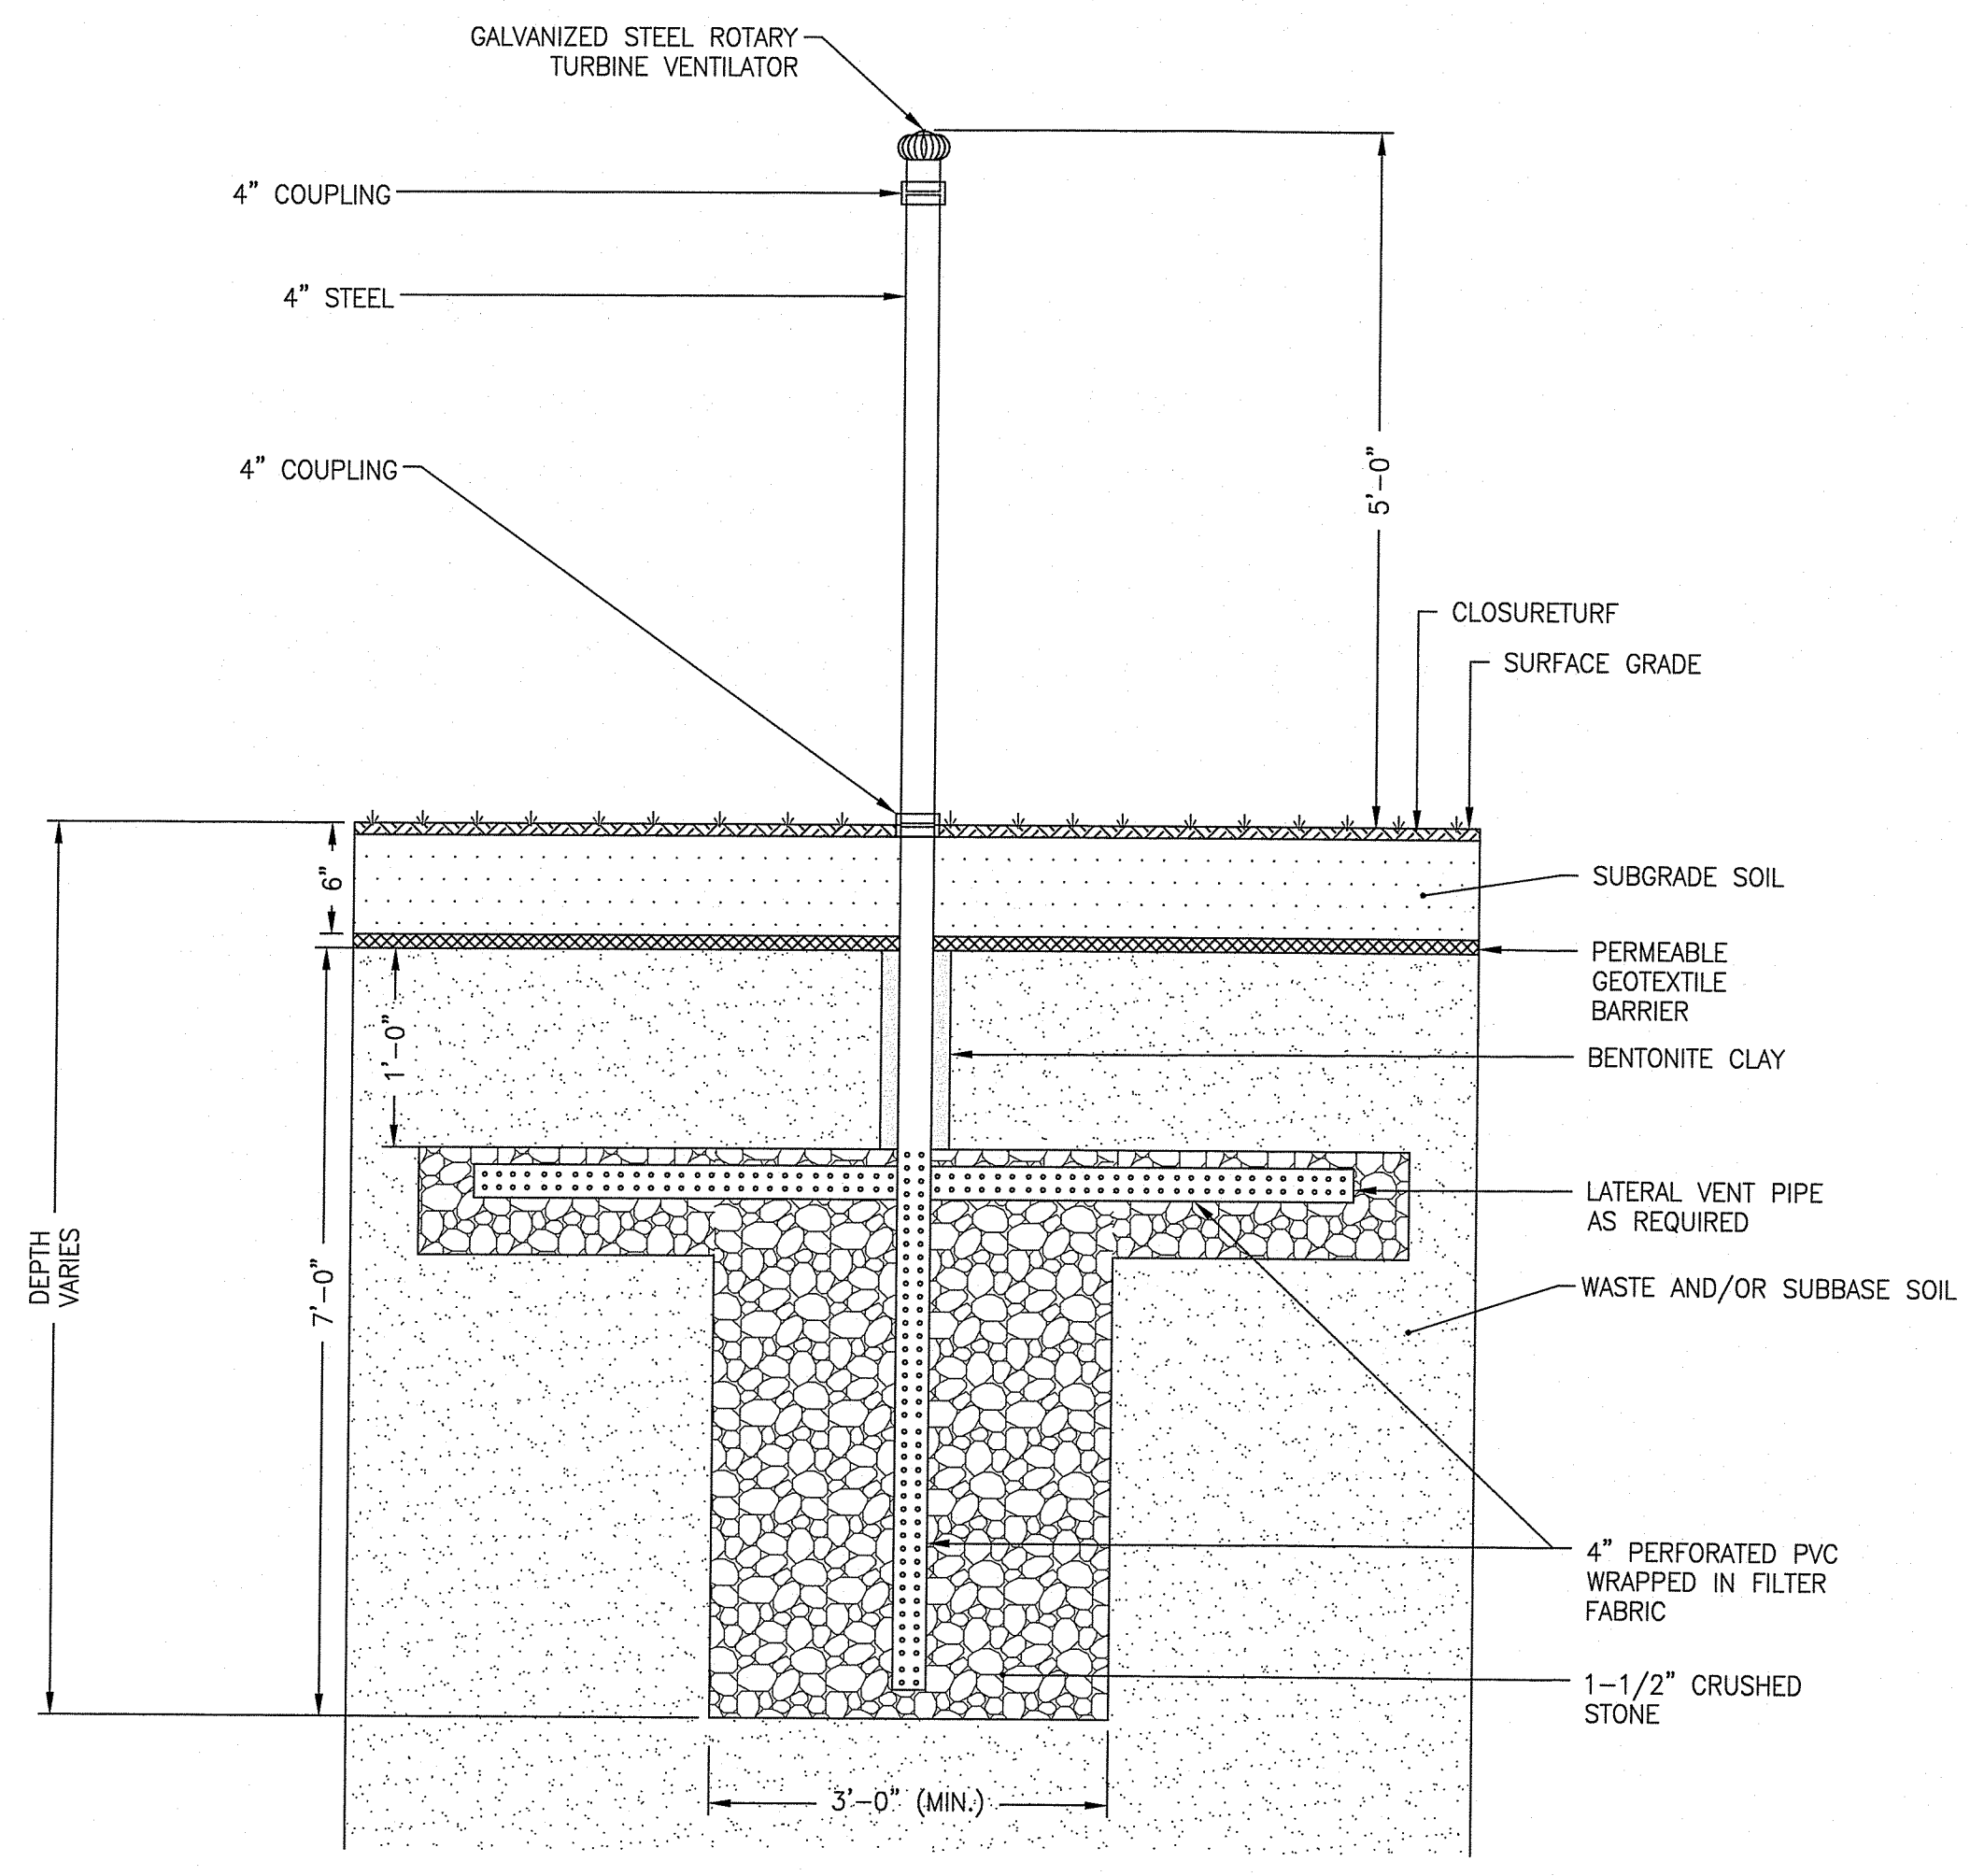

**PASSIVE LANDFILL GAS VENTILATION SYSTEM DETAIL**  
 NOT TO SCALE

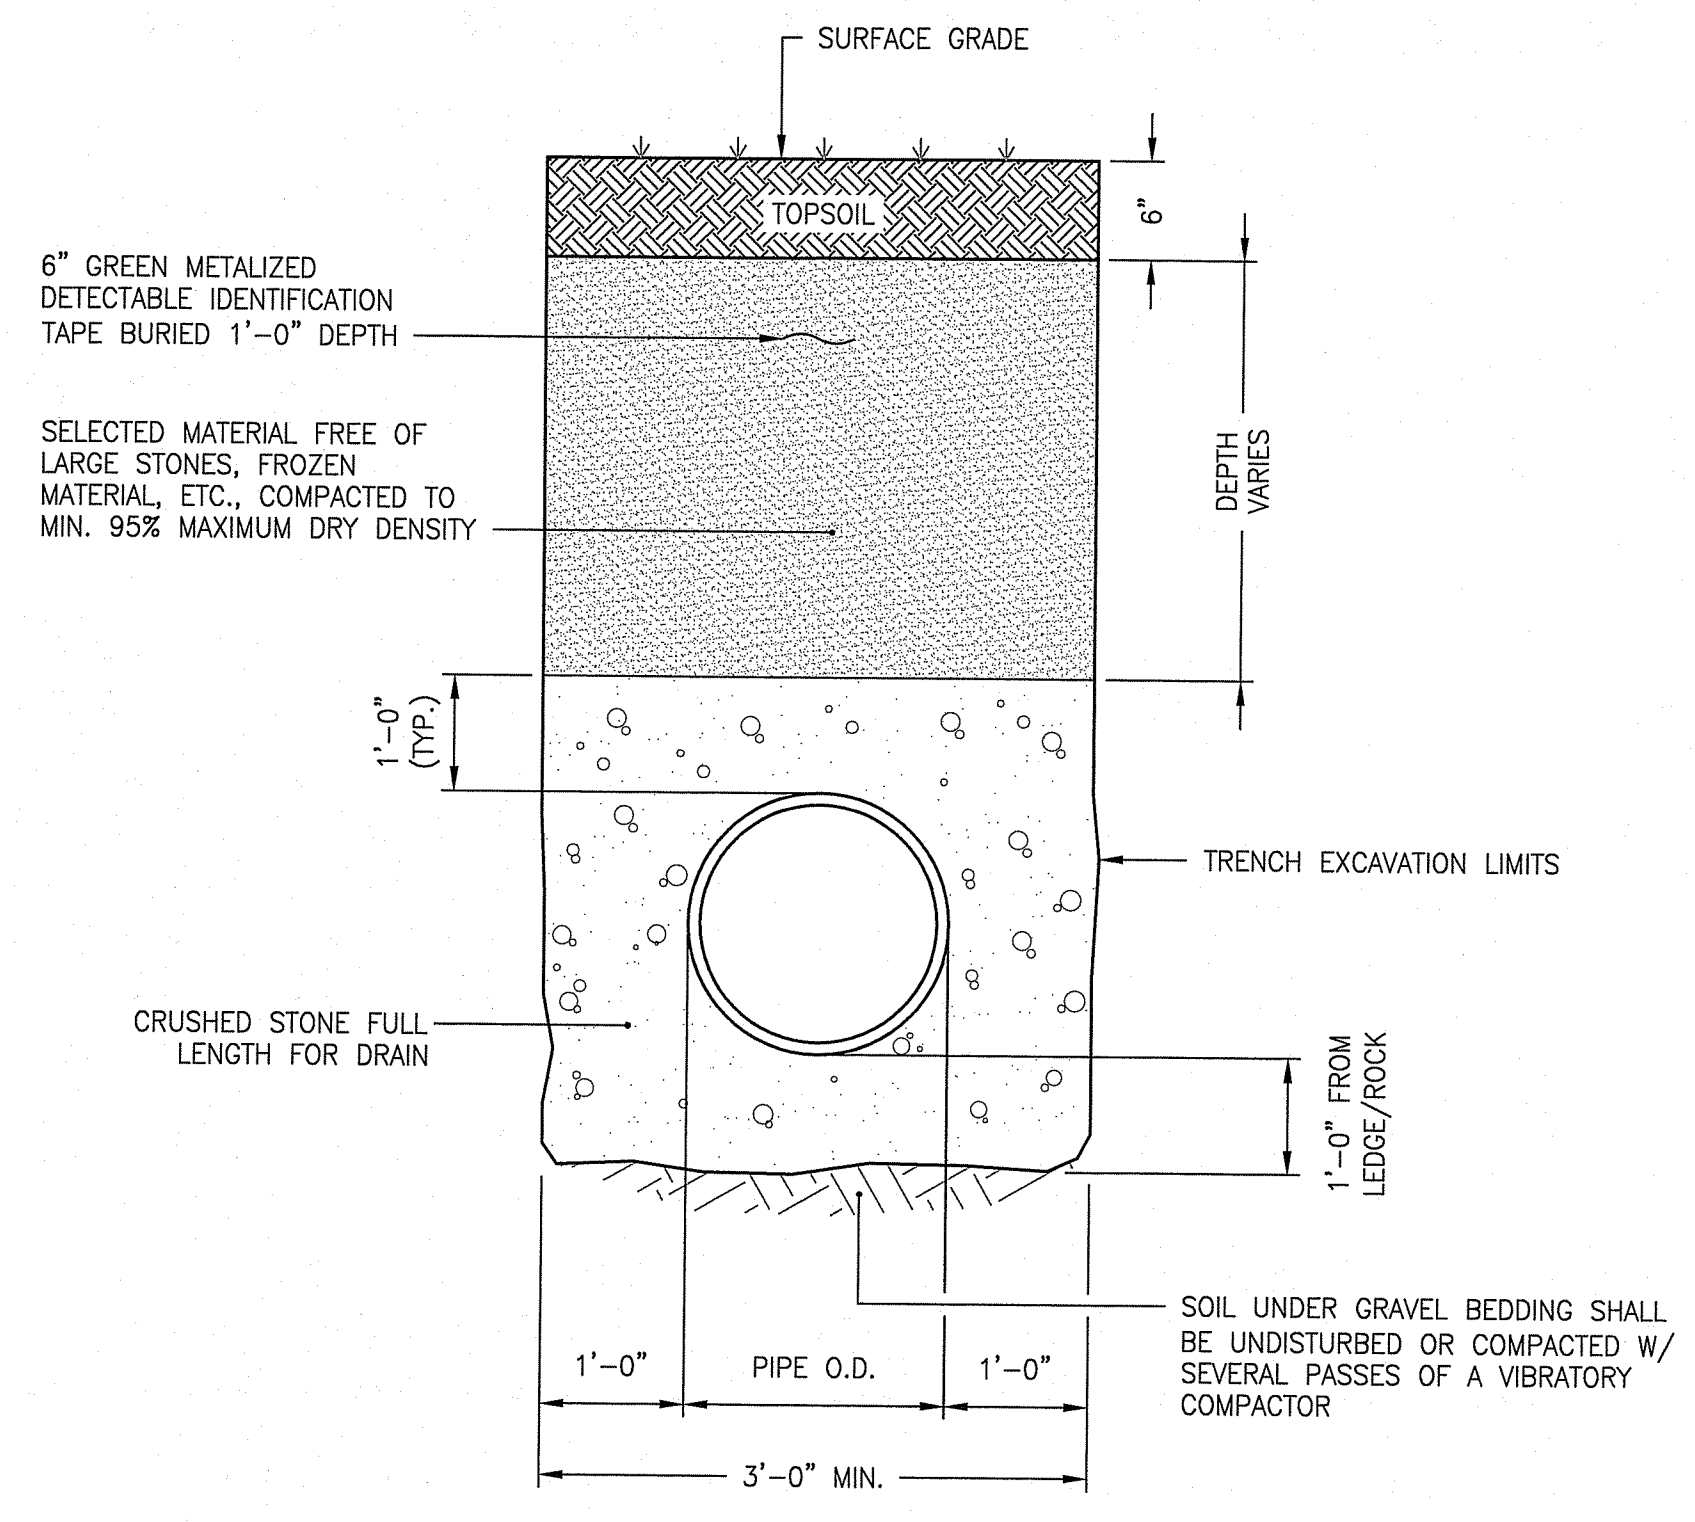

**DRAINAGE TRENCH DETAIL**  
 NOT TO SCALE

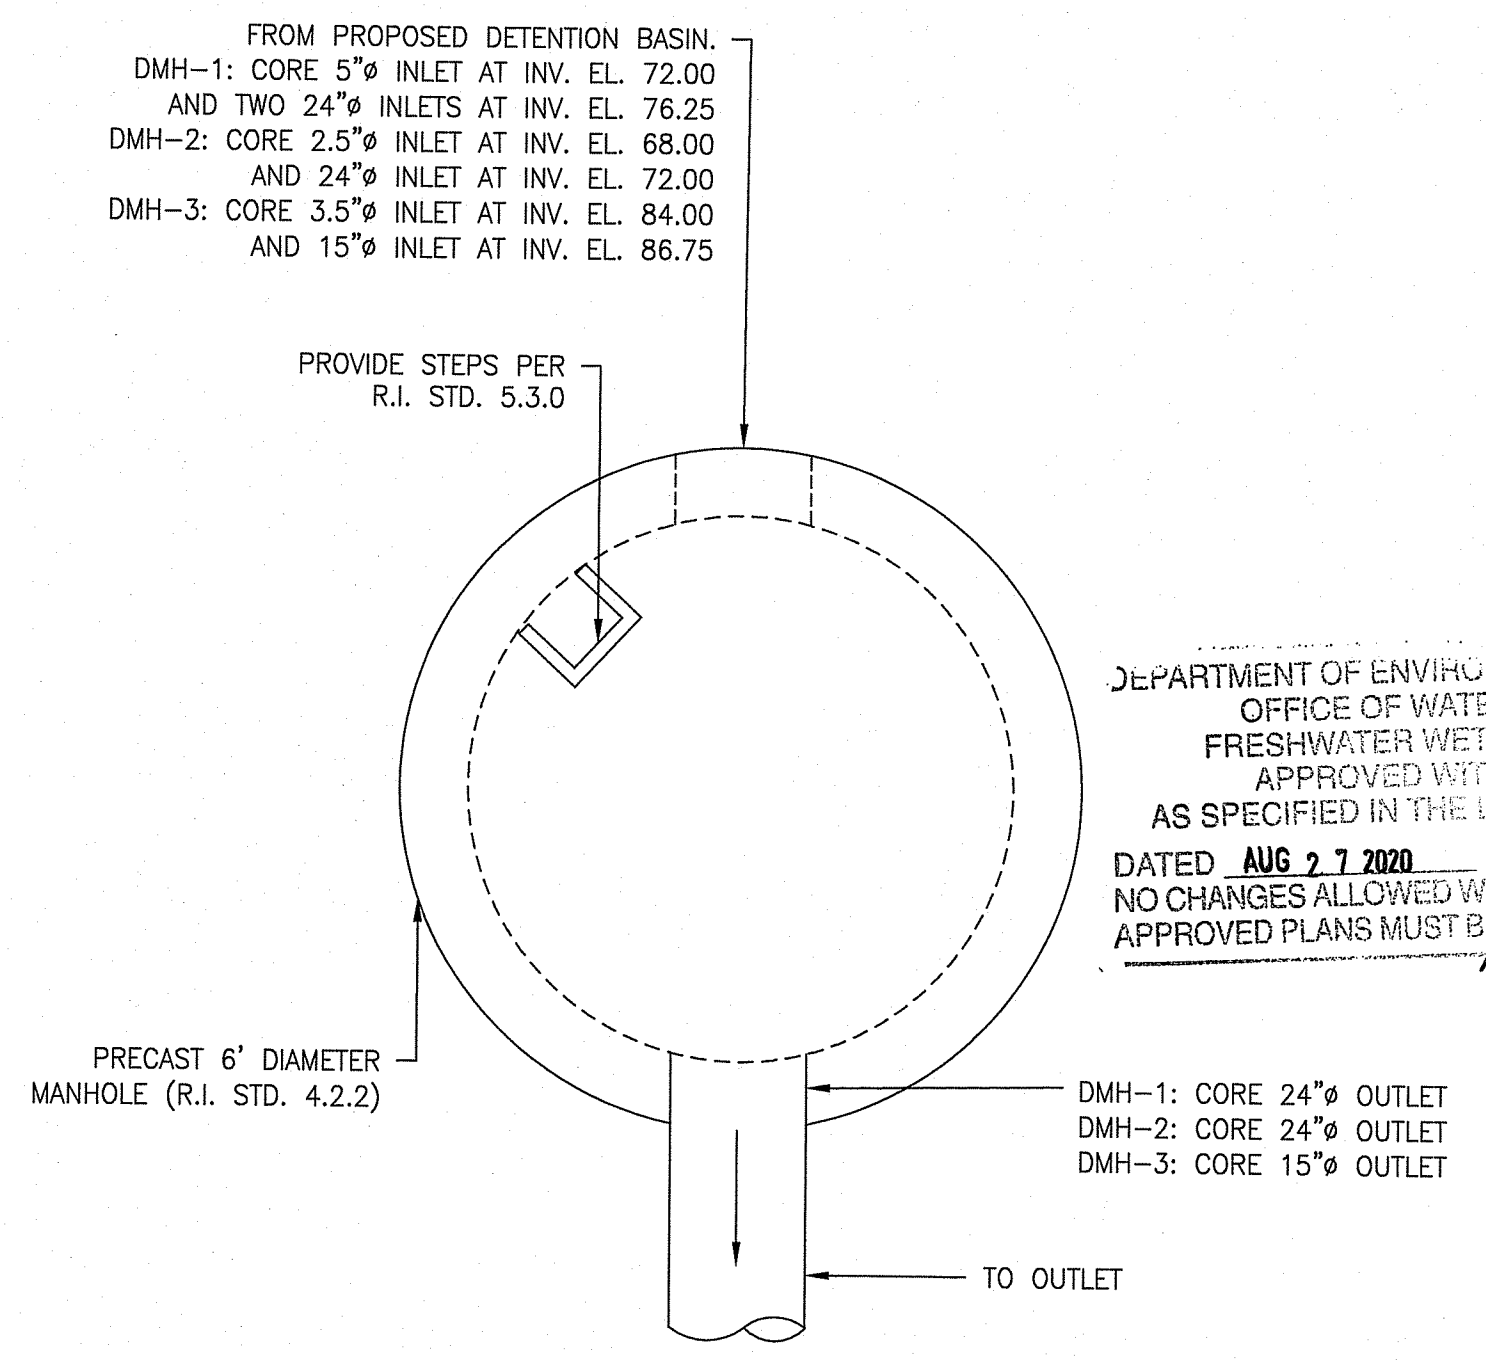

**DMH OUTLET CONTROL STRUCTURE DETAIL**  
 NOT TO SCALE

Environmental Management  
 JUL 15 2020


REVISIONS:

NO.	DESCRIPTION

PROJECT NO.: 94139.01  
 DATE: JULY 2020  
 SCALE: AS NOTED  
 DESIGNED BY: TCJ  
 CHECKED BY: SPD  
 DRAWN BY: TCJ  
 APPROVED BY: TPT  
 DRAWING TITLE:


DETAILS  
 NO. 2

DRAWING NO.:  
**C8.1**  
 SHEET NO. 11 OF 14

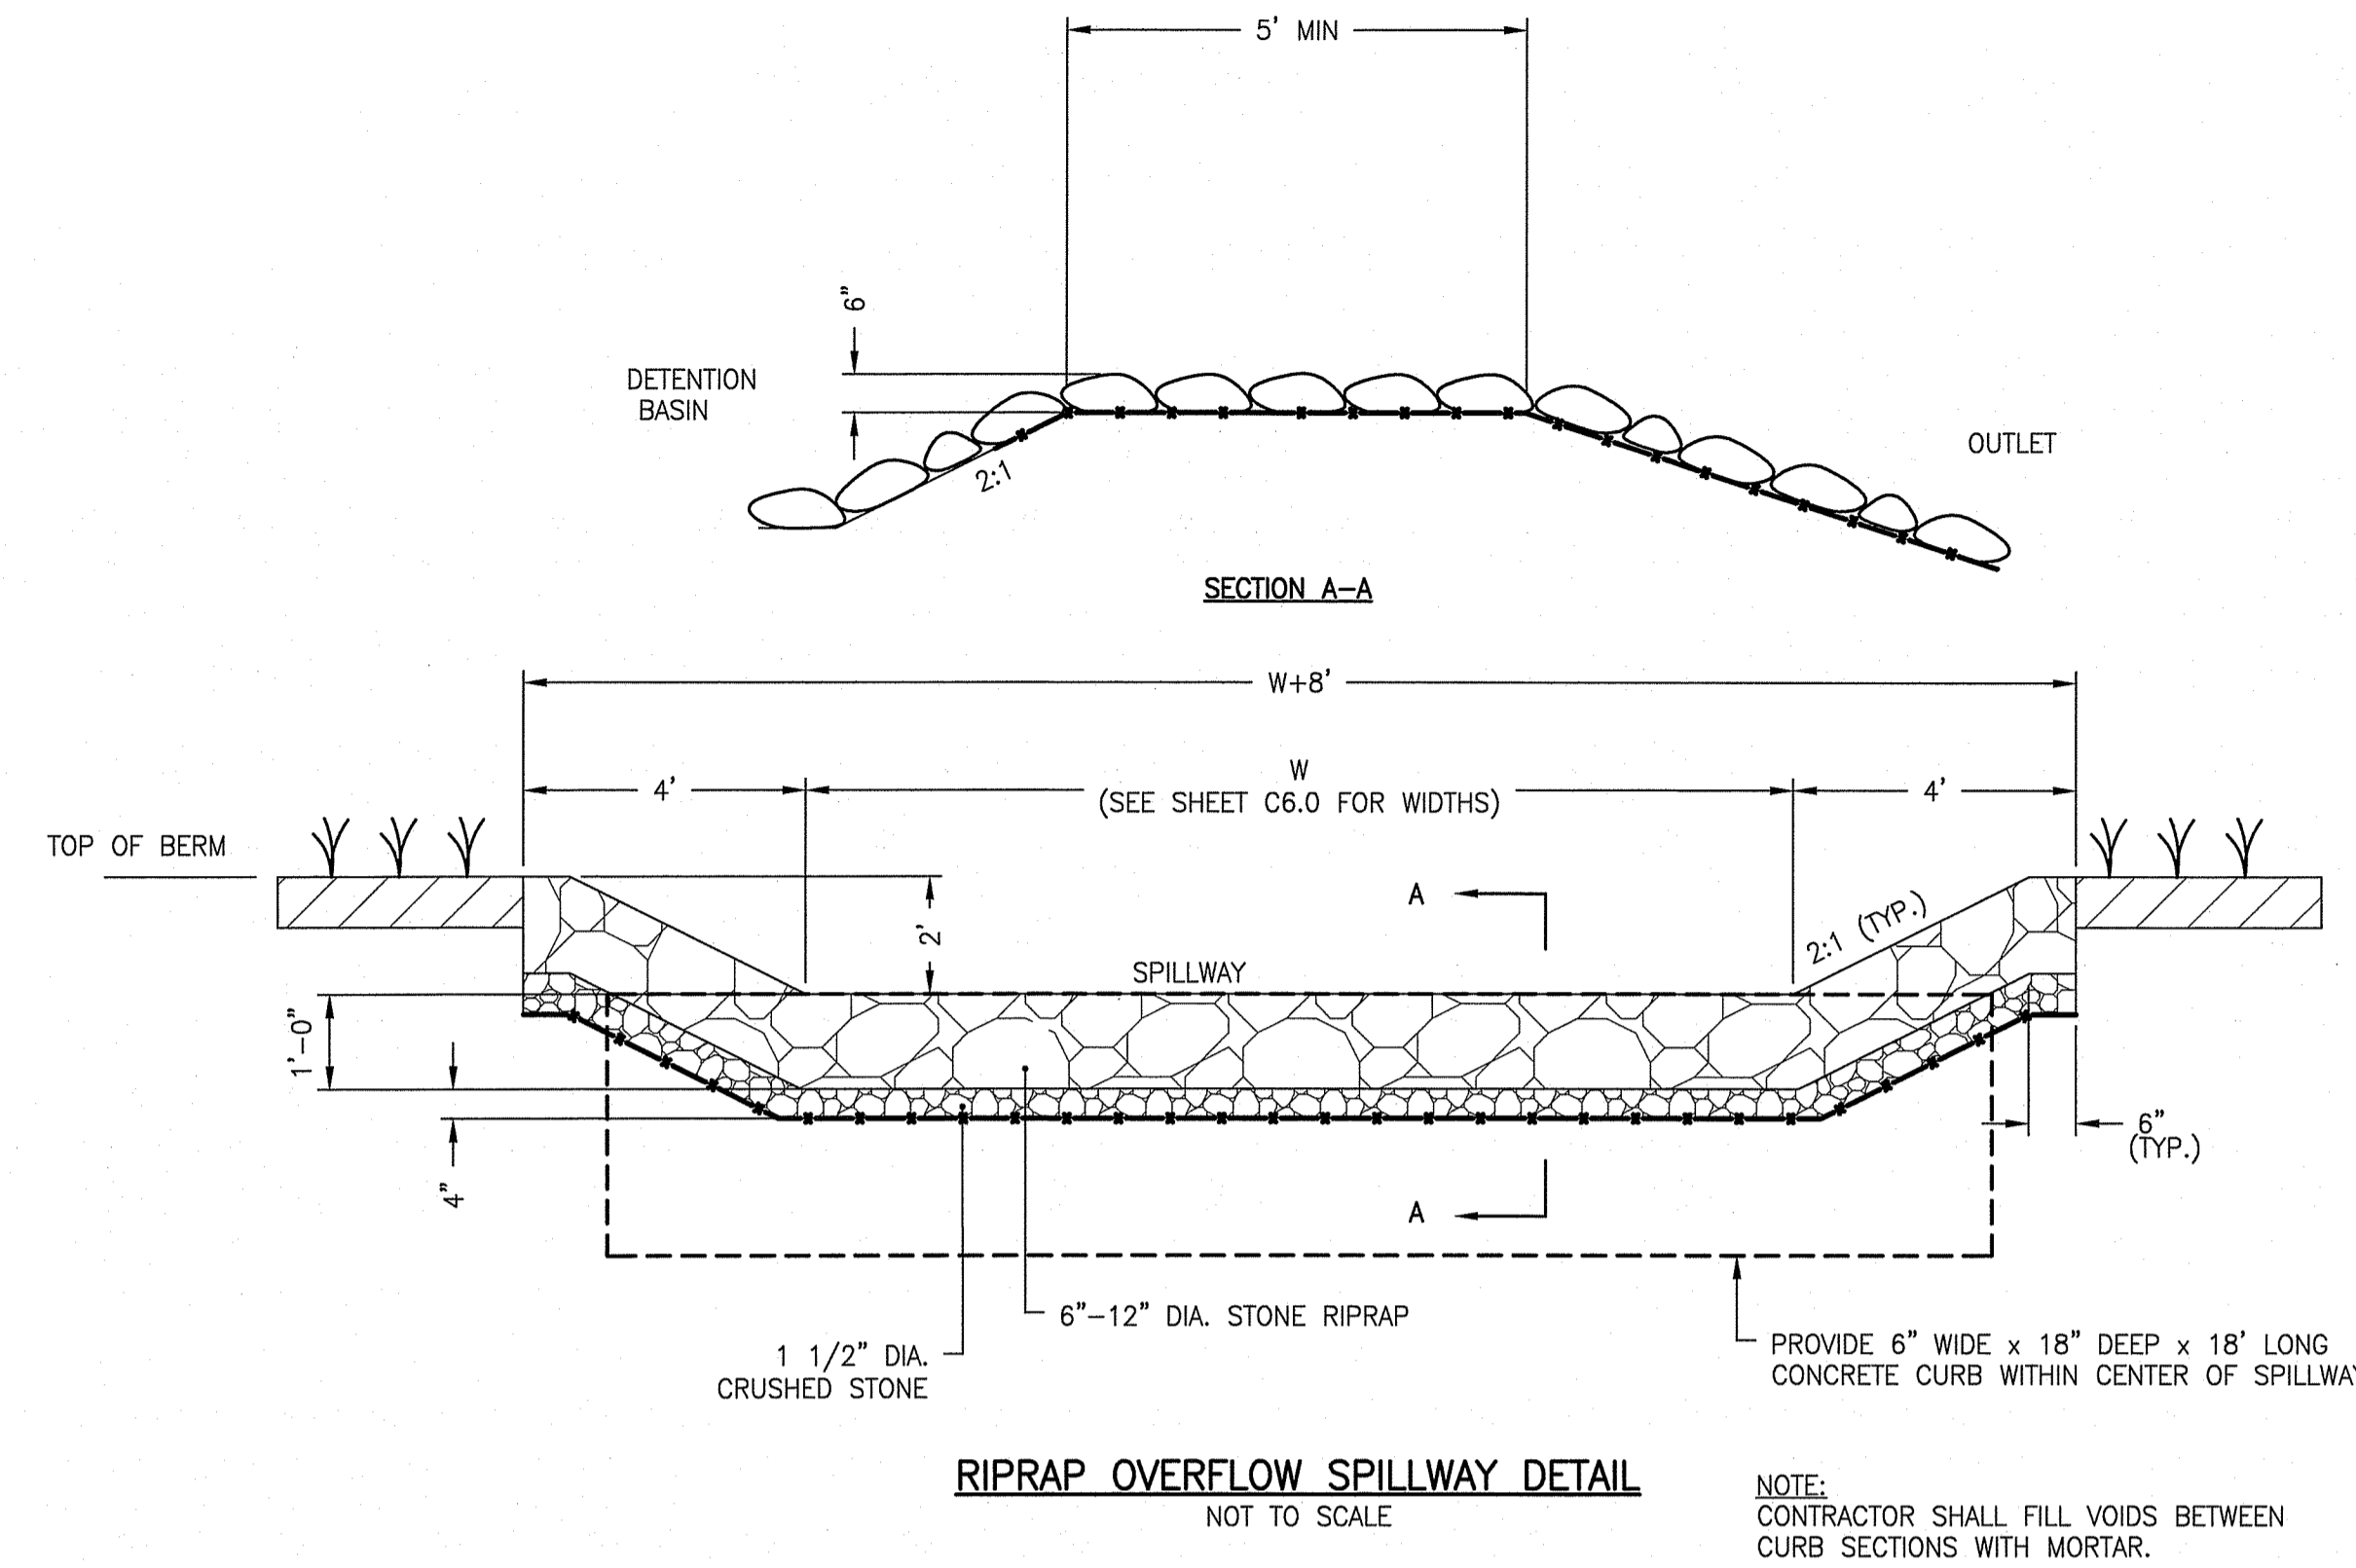


**RIPRAP OVERFLOW SPILLWAY DETAIL**  
 NOT TO SCALE


NOTE:  
 CONTRACTOR SHALL FILL VOIDS BETWEEN CURB SECTIONS WITH MORTAR.

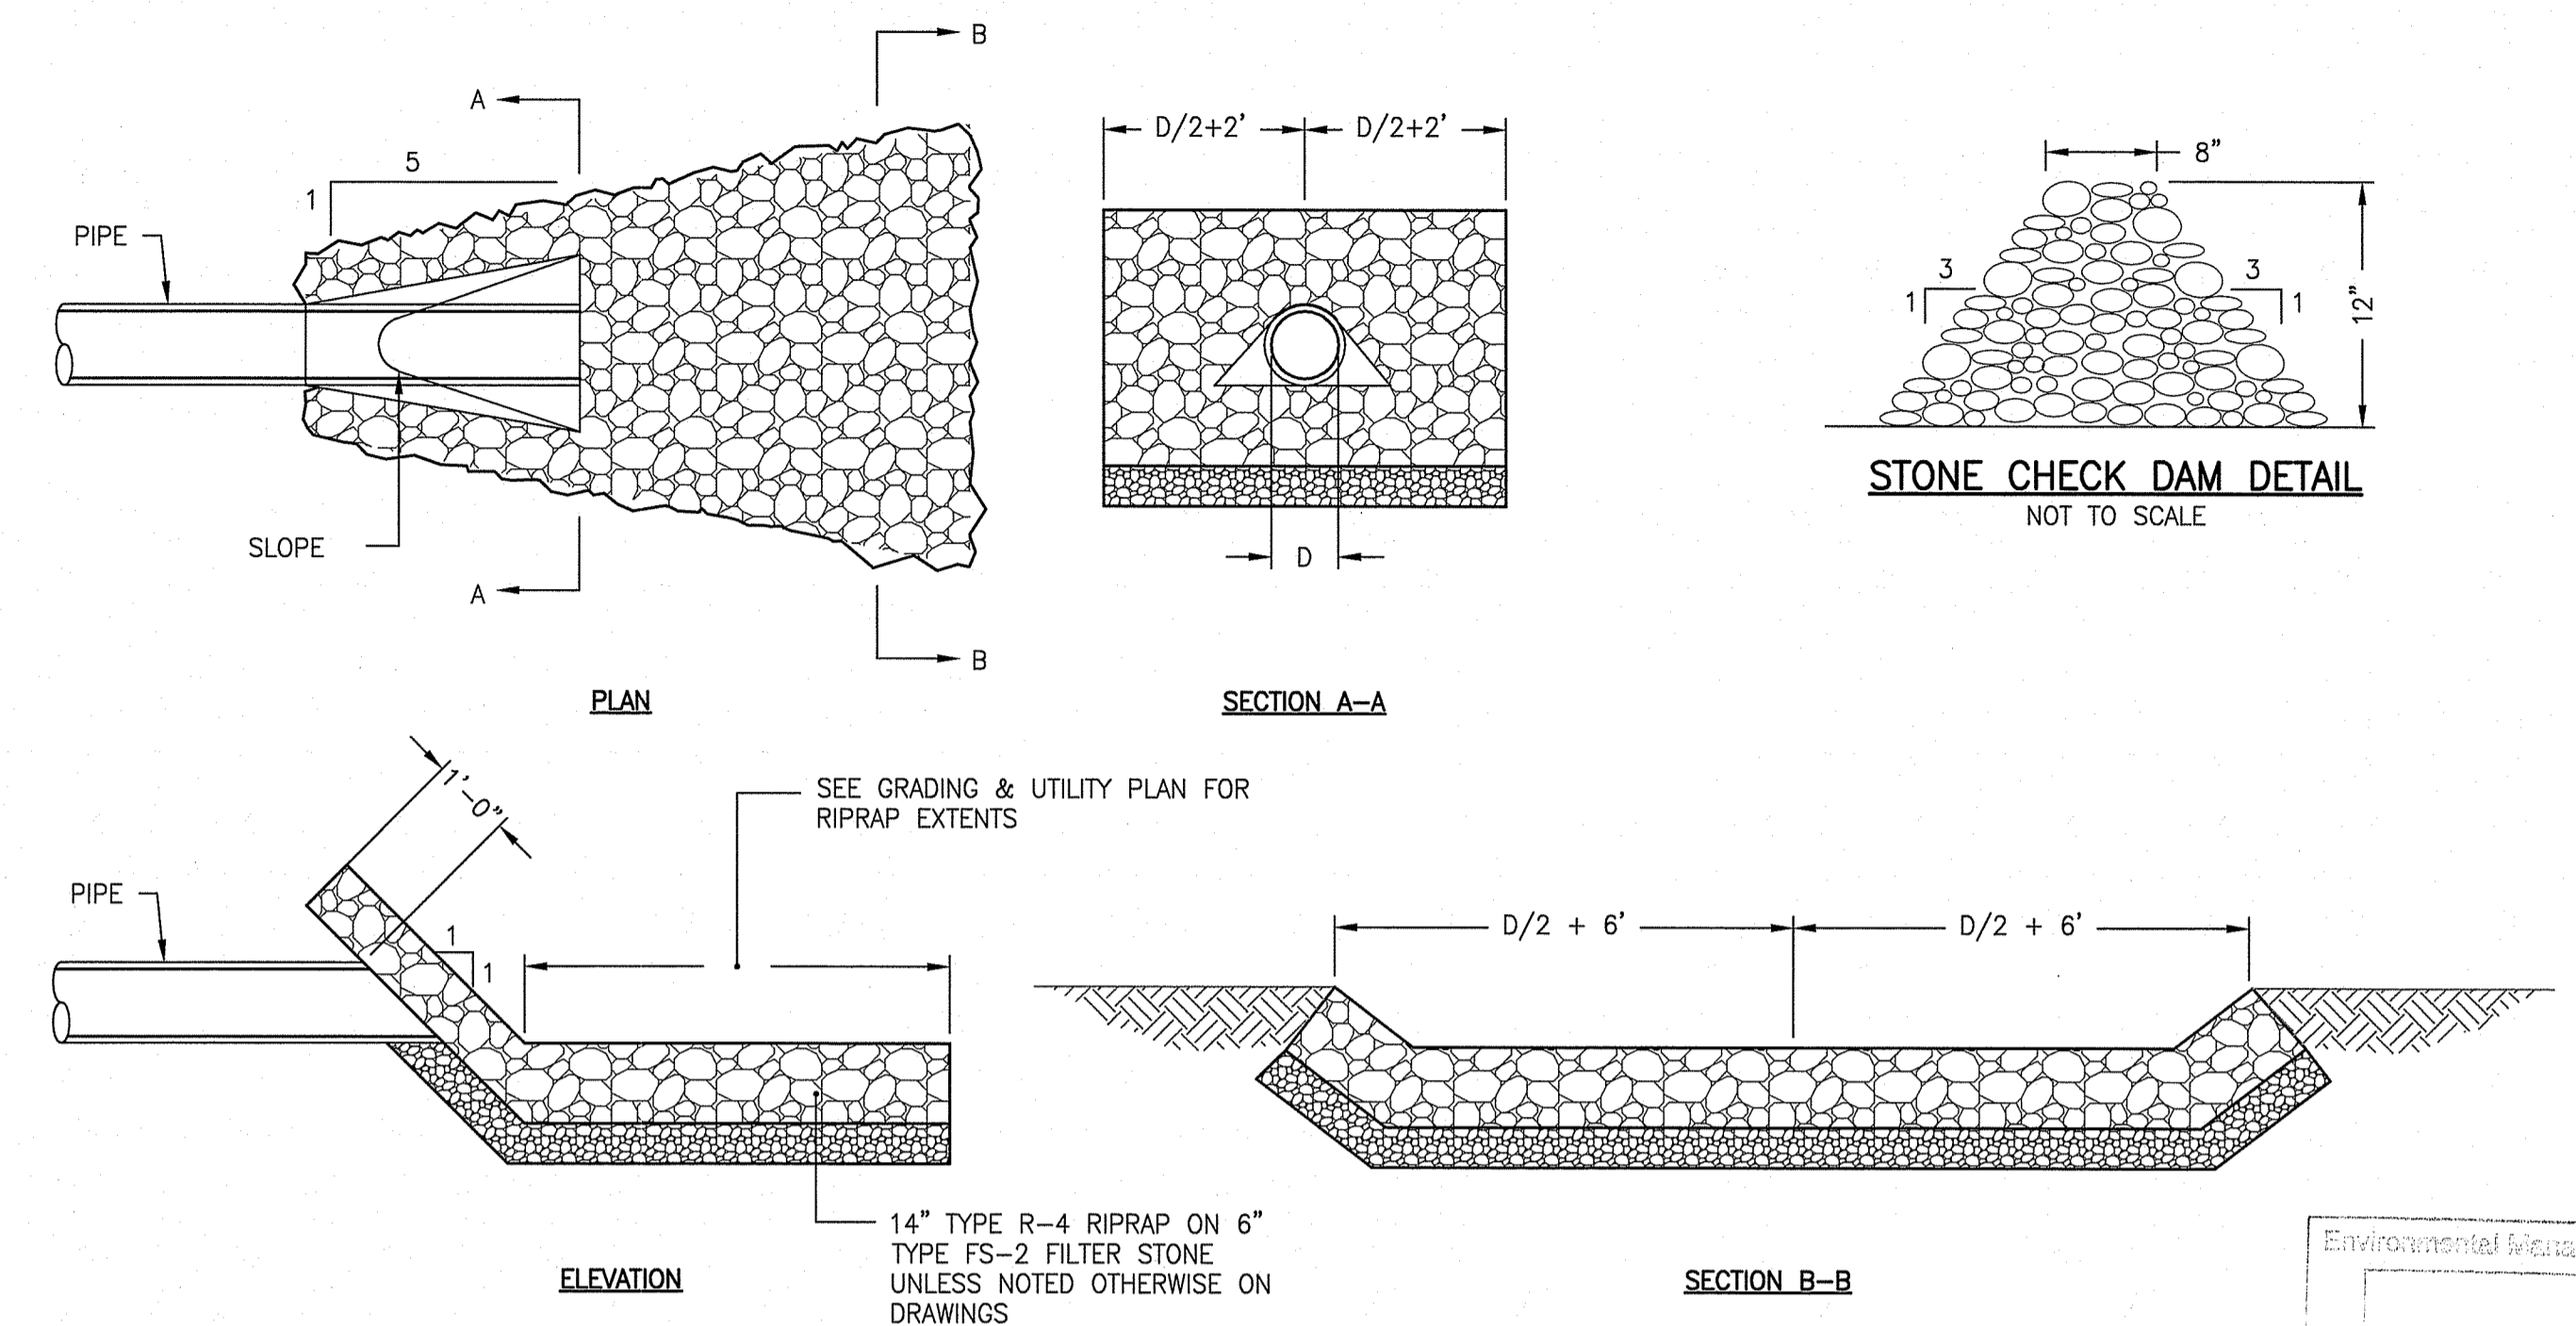


**RIPRAP AND FLARED END SECTION**  
 NOT TO SCALE

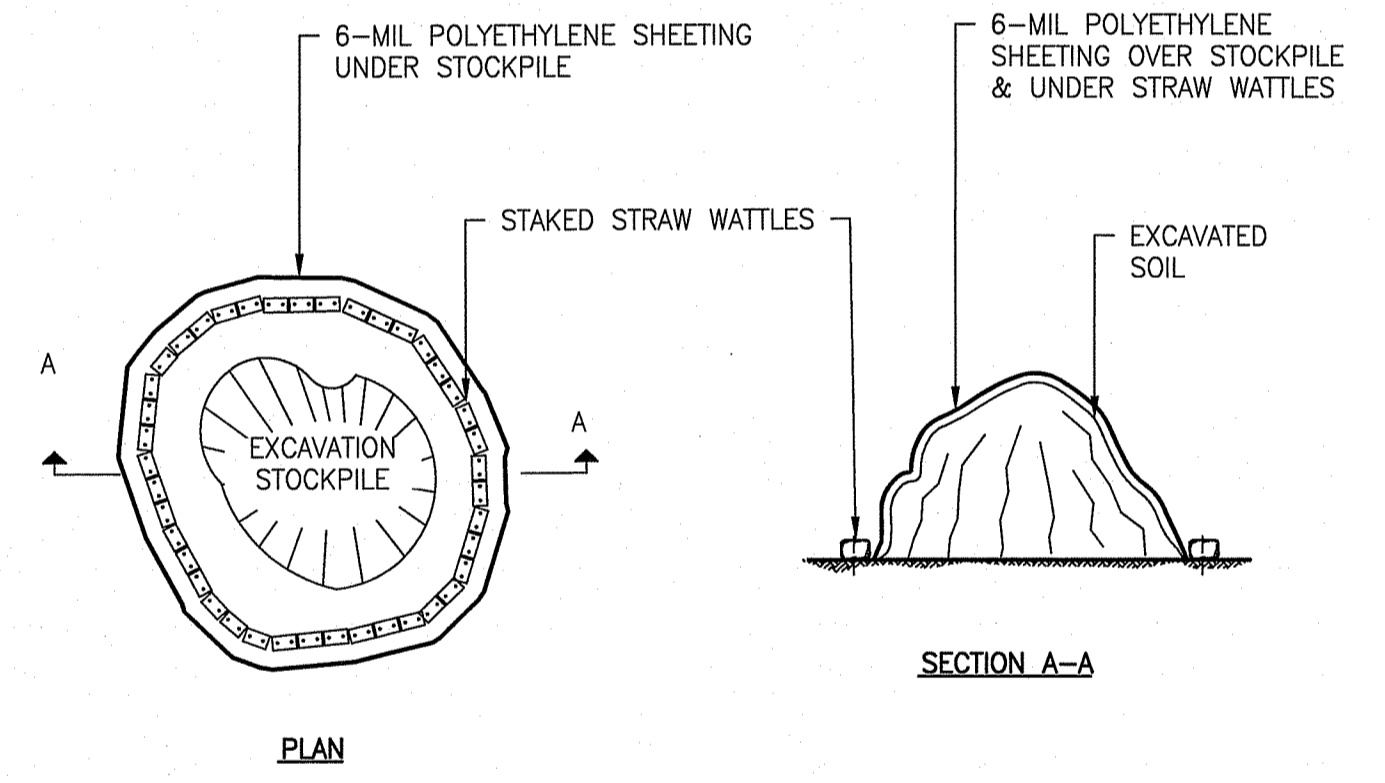


**CONTAMINATED SOIL STOCKPILE**  
 NOT TO SCALE

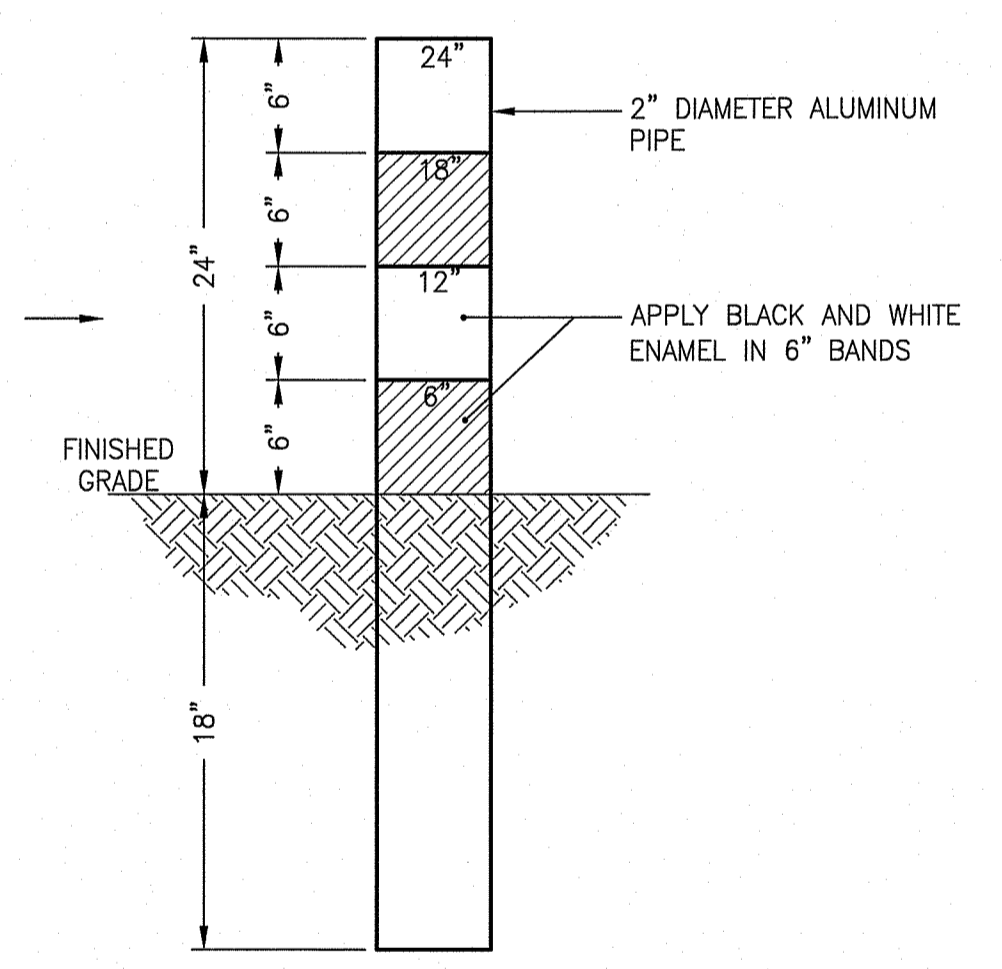

**SEDIMENT MARKER DETAIL**  
 NOT TO SCALE

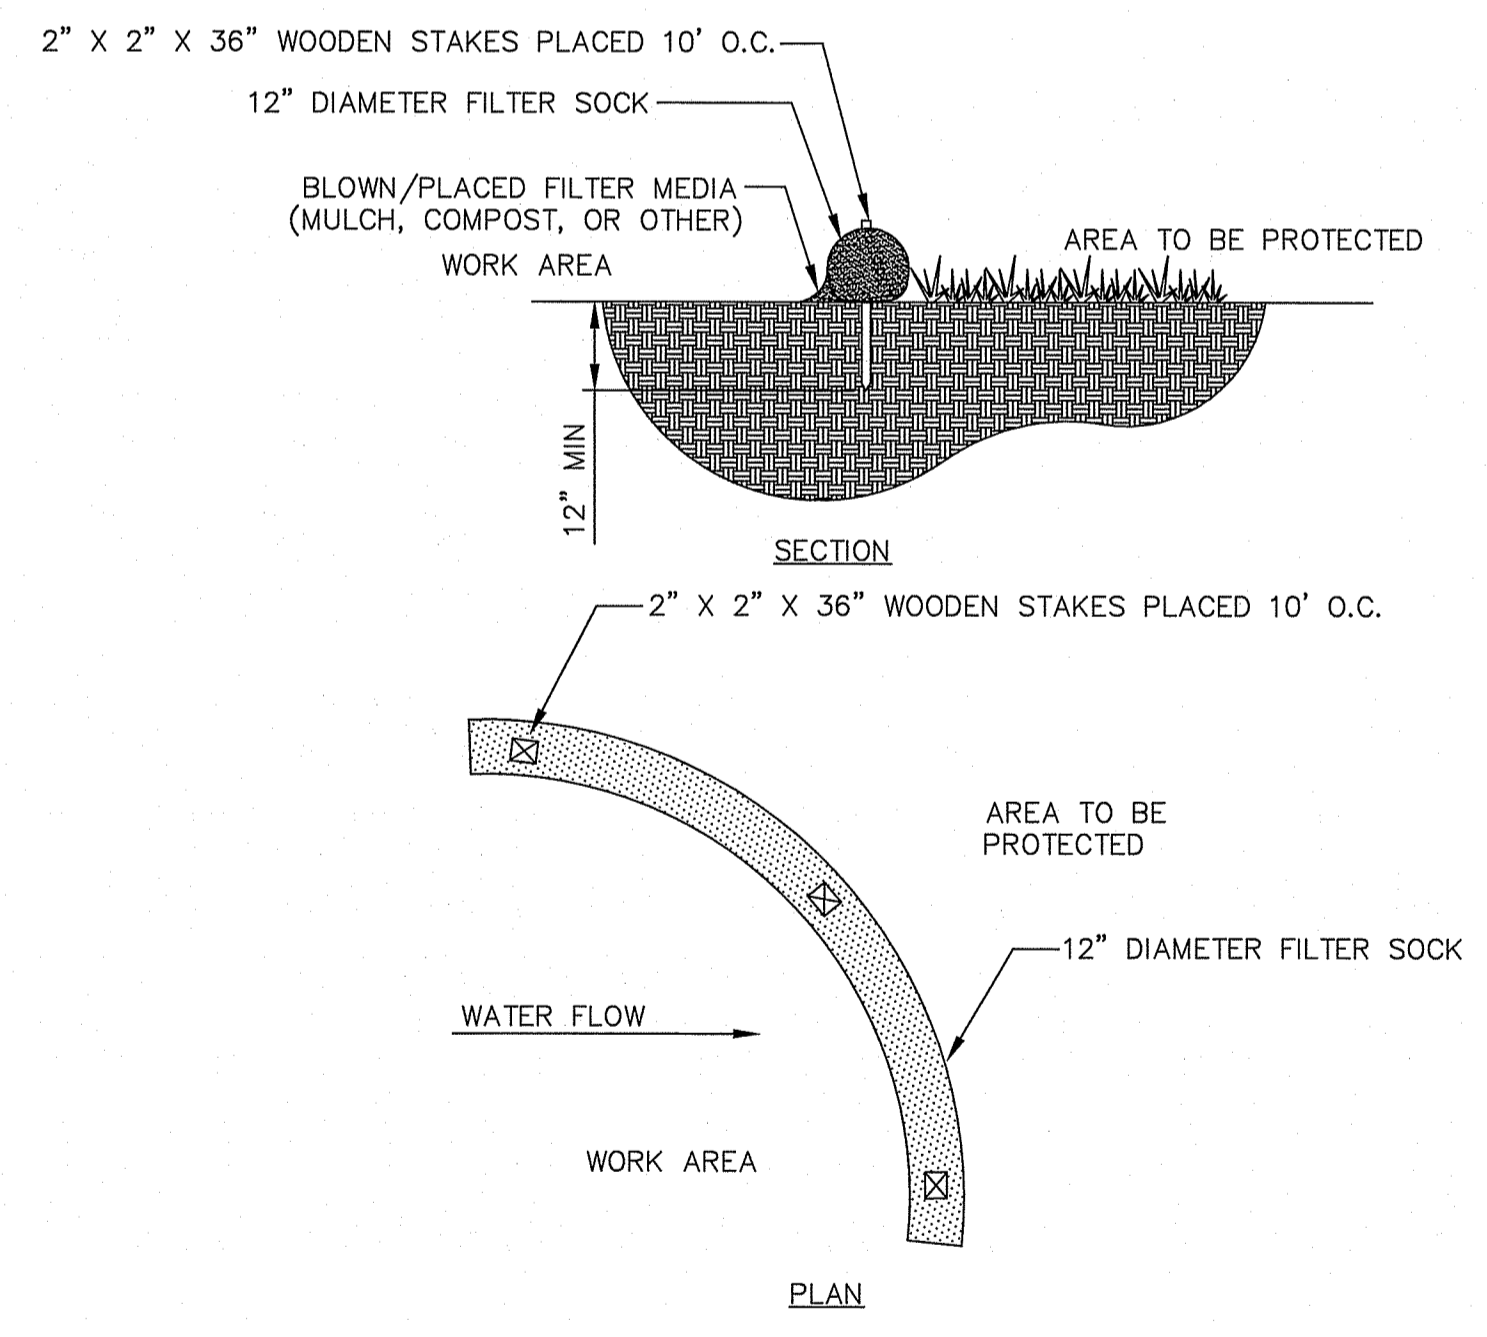

**SEDIMENTATION BARRIER**  
 NOT TO SCALE

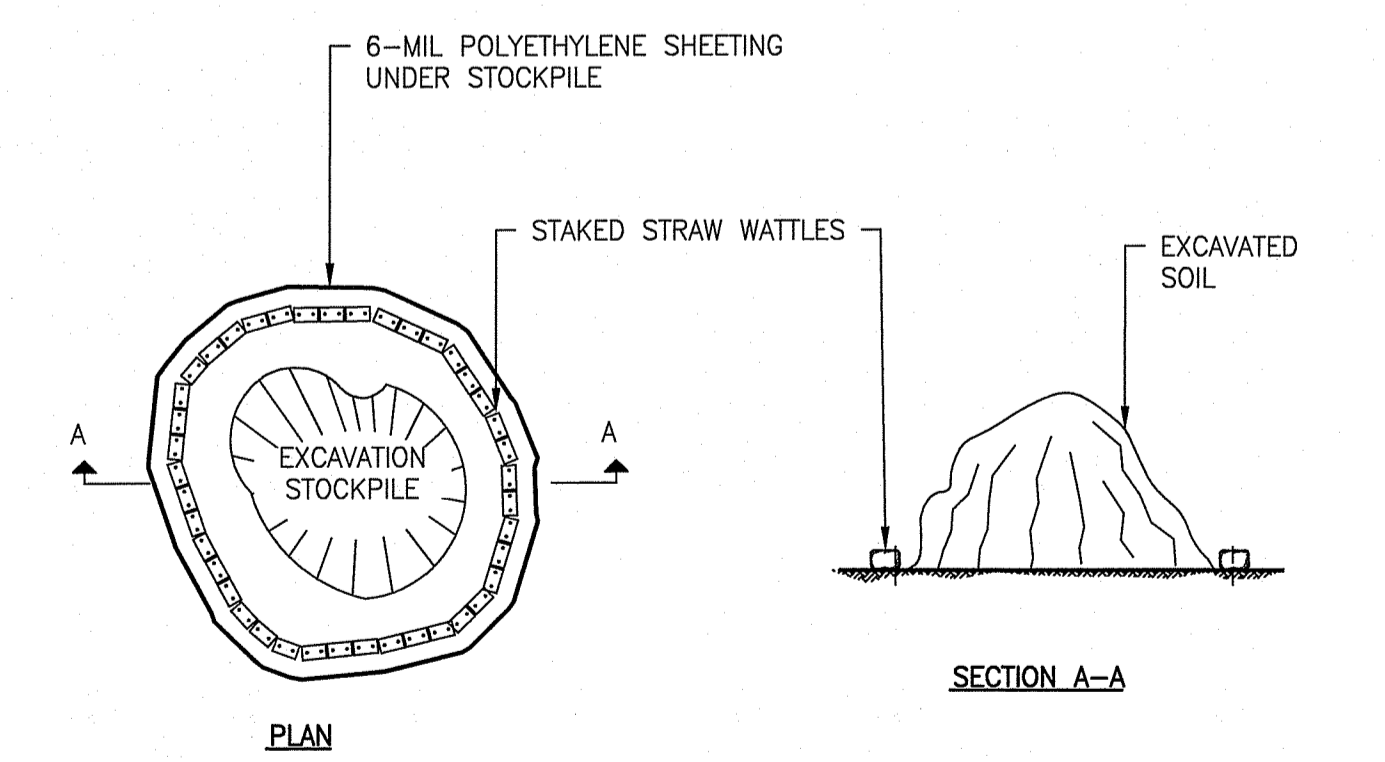

**CLEAN SOIL STOCKPILE**  
 NOT TO SCALE

DEPARTMENT OF ENVIRONMENTAL MANAGEMENT  
 OFFICE OF WATER RESOURCES  
 FRESHWATER WETLANDS PROGRAM  
 APPROVED WITH CONDITIONS  
 AS 006272020 FILE # 18-0120  
 DATED: 7/15/2020  
 NO CHANGES ALLOWED WITHOUT PRIOR APPROVAL  
 APPROVED PLANS MUST BE AT CONSTRUCTION SITE  
*Timothy P. Thies*





