


PRELIMINARY PLAN SUBMISSION

GD Gloucester White Oak I


74 White Oak Lane
 Gloucester, Rhode Island 02857
 Assessor's Plat 18 Lot 73

Sheet Index

Sheet Number	Sheet Title
C1.1	Cover Sheet
C1.2	Aerial & Map Sheet
C1.3	General Notes
C1.4	Existing Site Analysis Plan
C1.5	SESC - Overall Proposed Site Plan
C1.6	Proposed Overall Site Plan
C1.7	Proposed Site Plan - Enlarged
C1.8	Enlarged View Ponds
C1.9	Pond Detail Sheet
C1.10	Detail Sheet

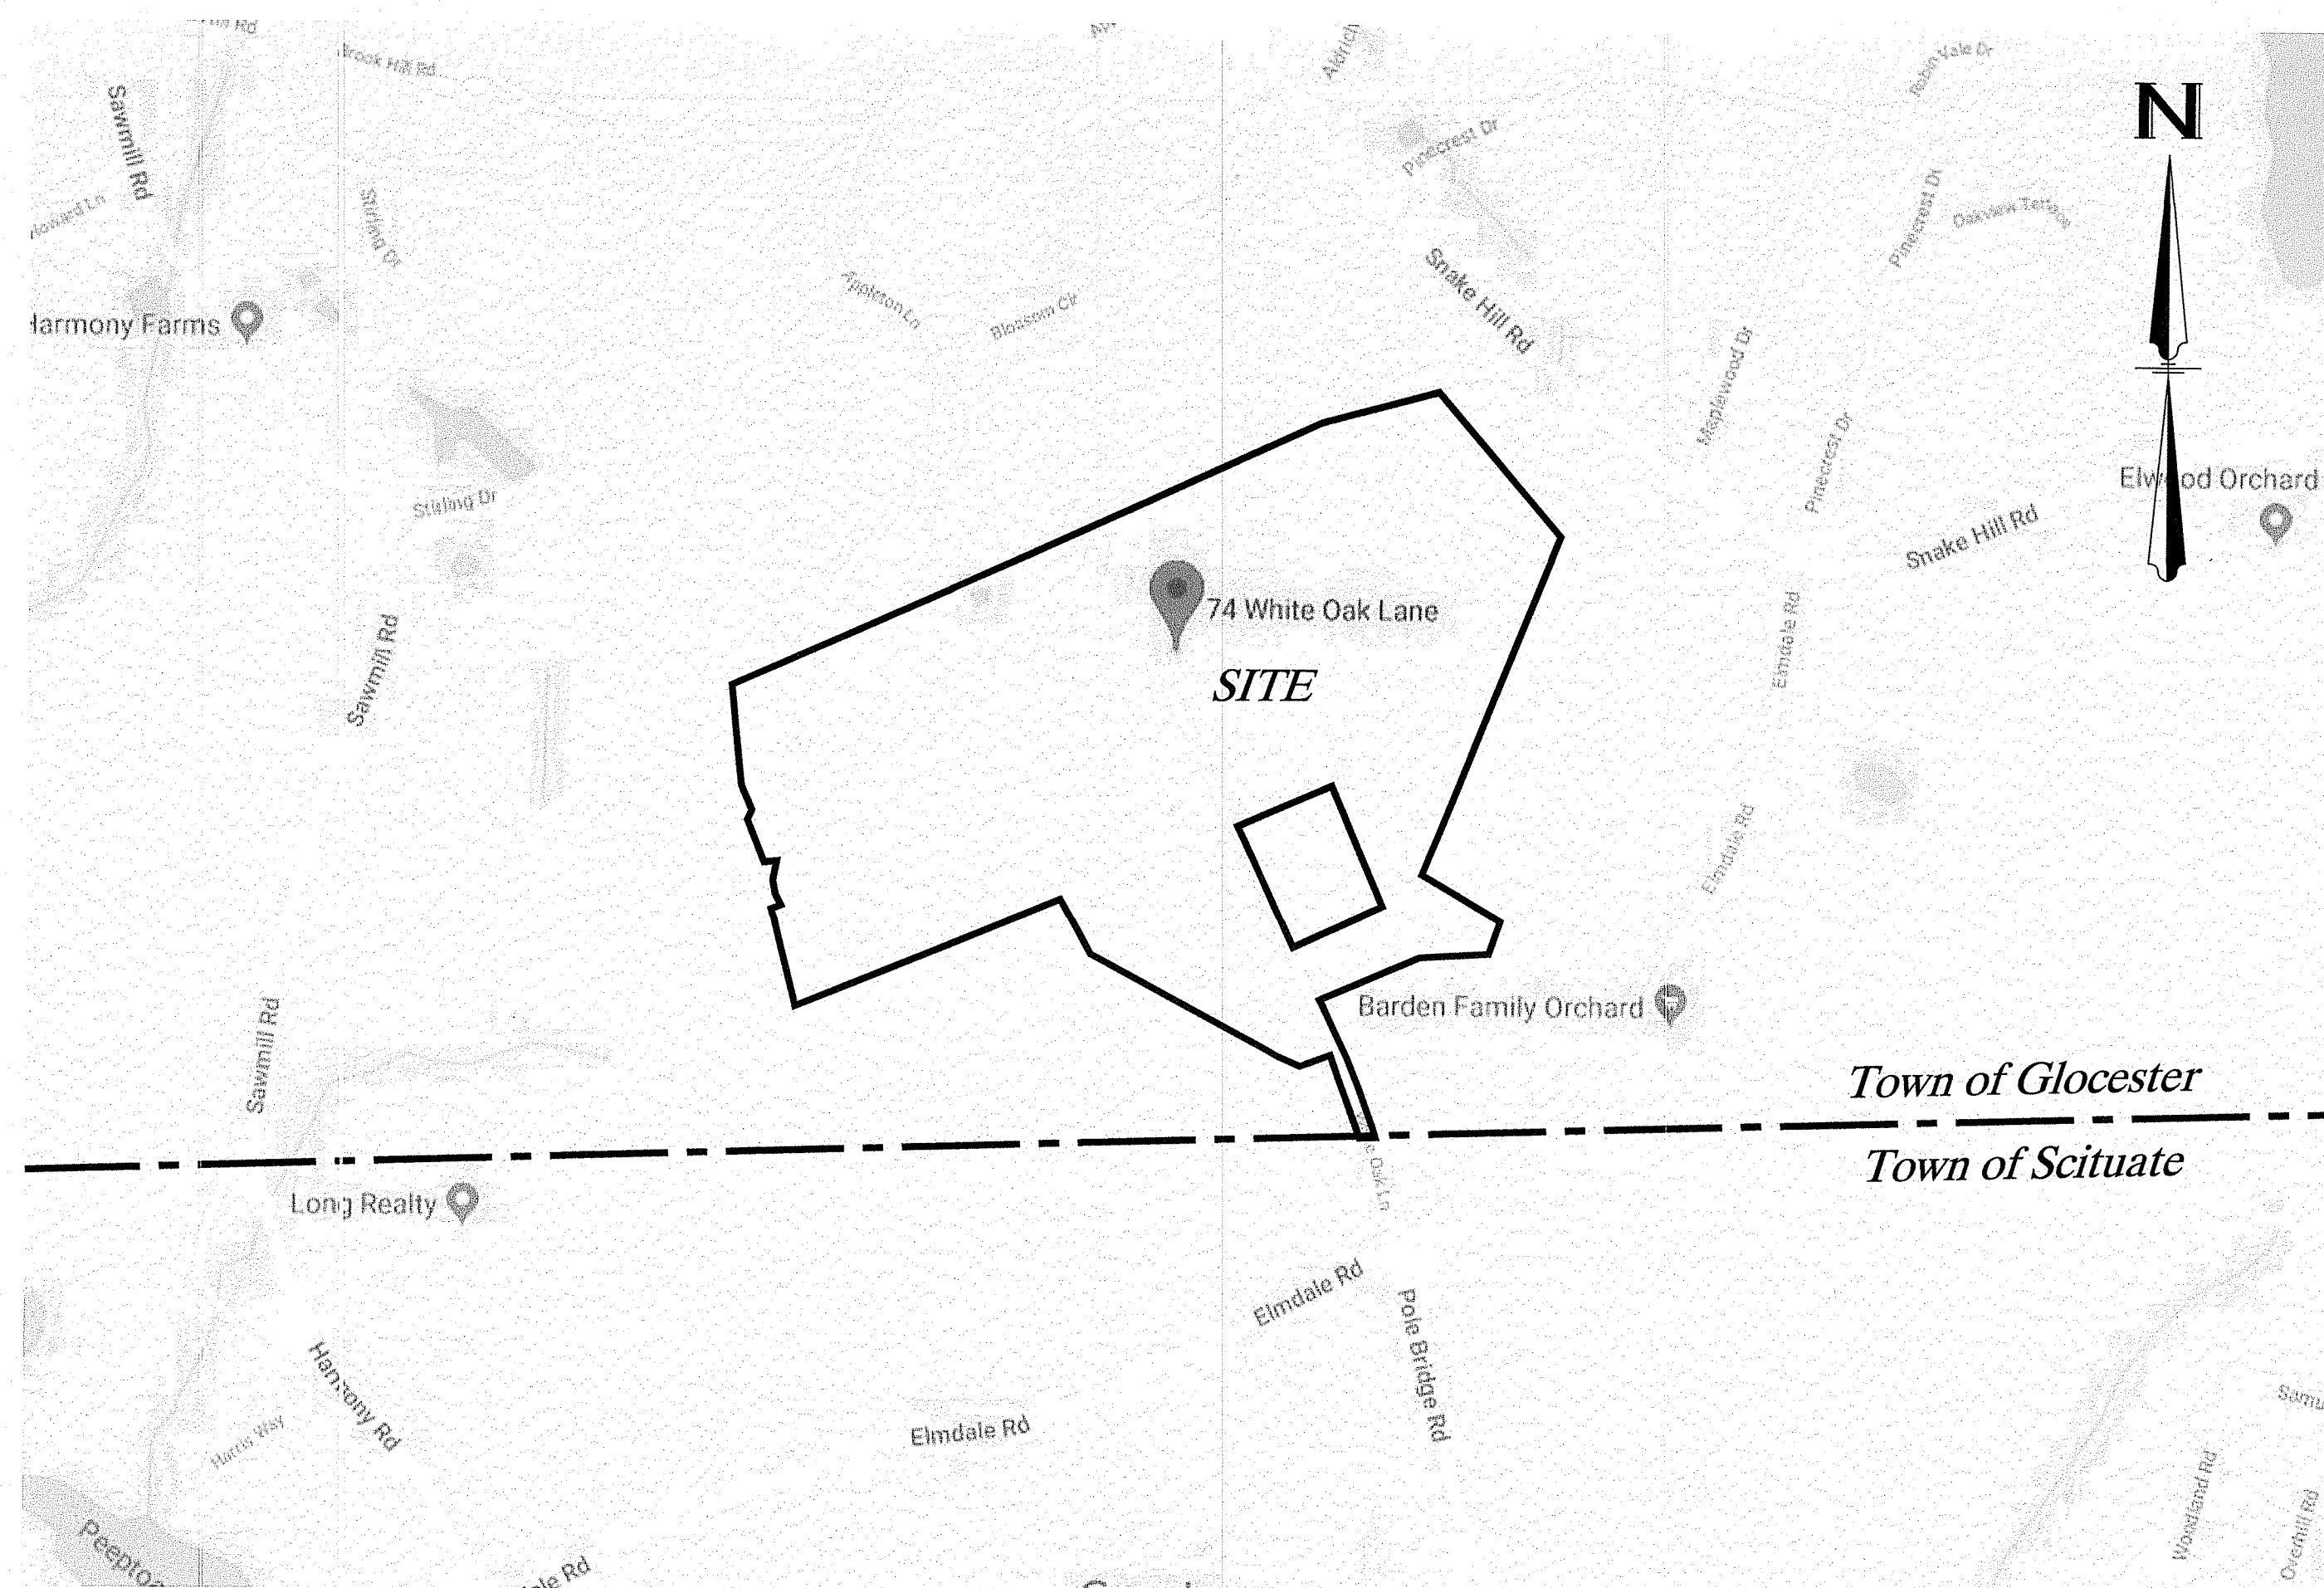

Vicinity Map (Scale: 1"=500')

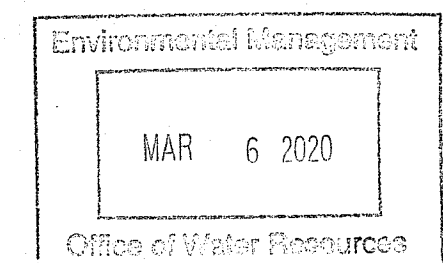

DEPARTMENT OF ENVIRONMENTAL MANAGEMENT
 OFFICE OF WATER RESOURCES
 FRESHWATER WETLANDS PROGRAM
 APPROVED WITH CONDITIONS
 AS SPECIFIED IN THE LETTER OF APPROVAL
 DATED MAR 20 2020 FILE # 19-0329
 NO CHANGES ALLOWED WITHOUT PRIOR APPROVAL
 APPROVED PLANS MUST BE AT CONSTRUCTION SITE
Nancy L. Felman

SESC / O&M:
 THE ACCOMPANYING DOCUMENTS ARE CONSIDERED PART OF THIS PLAN SET. THE CONTRACTOR/OWNER SHALL MAINTAIN A COPY OF THE MOST CURRENT PLAN SET AND THE MOST CURRENT ACCOMPANYING DOCUMENTS ON SITE DURING CONSTRUCTION AT ALL TIMES. ACCOMPANYING DOCUMENTS ARE AS FOLLOWS:

SOIL EROSION AND SEDIMENT CONTROL PLAN (SESC) WHICH CONTAINS BUT NOT LIMITED TO THE FOLLOWING INFORMATION:

- SEQUENCE OF CONSTRUCTION
- EROSION CONTROL MEASURES
- ESTABLISHMENT OF VEGETATIVE COVER
- SHORT TERM MAINTENANCE

OPERATIONS AND MAINTENANCE PLAN (O&M) WHICH CONTAINS BUT NOT LIMITED TO THE FOLLOWING INFORMATION:

- LONG TERM MAINTENANCE



APPLICANT: GD Gloucester White Oak I, LLC
 3760 QUAKER LANE, NORTH KINGSTOWN, RI 02852

PREPARED FOR: Roger N Phillips, Patricia Elias & Paul Phillips
 74 WHITE OAK LANE, PO BOX 89, NORTH SCITUATE, RI 02857

PREPARED BY: Green Development, LLC
 3760 QUAKER LANE, NORTH KINGSTOWN, RI 02852

NO.	DATE	REVISION
1	3/5/2020	ISSUE FOR PERMITS
2	3/12/2020	ISSUE FOR PERMITS
3	3/12/2020	ISSUE FOR PERMITS
4	3/12/2020	ISSUE FOR PERMITS
5	3/12/2020	ISSUE FOR PERMITS
6	3/12/2020	ISSUE FOR PERMITS
7	3/12/2020	ISSUE FOR PERMITS
8	3/12/2020	ISSUE FOR PERMITS

SHEET TITLE: Cover Sheet


PROJECT INFORMATION:
GD Gloucester White Oak I
 ALTERNATING CURRENT (AC): 1.80 MW
 74 WHITE OAK LANE, GLOUCESTER, RI 02857
 ASSESSOR'S PLAT 18 LOT 73



SHEET NO.: C1.1 OF 10



1/2 Mile Radius Map

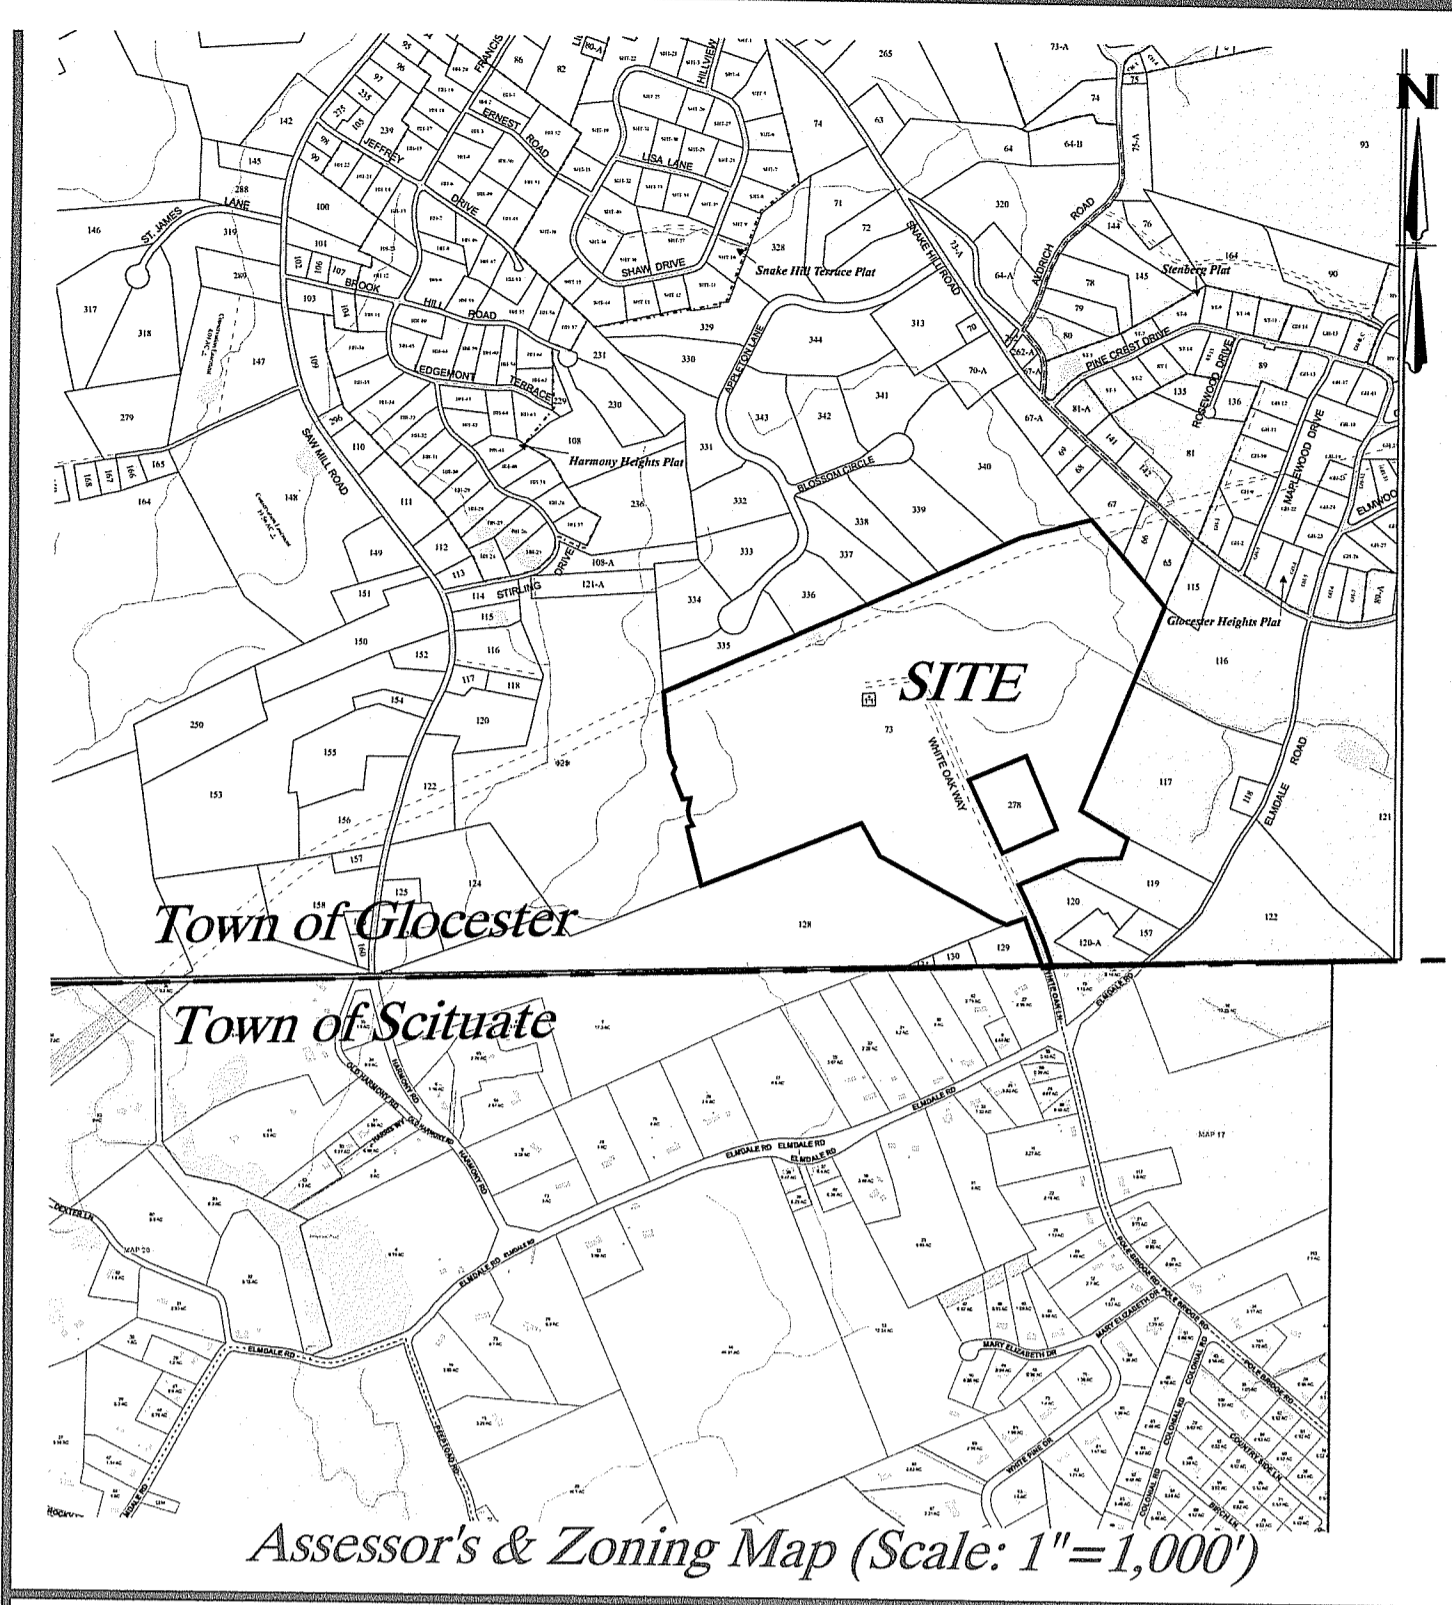

Disclaimer:

THIS PLAN IS NOT TO BE CONSTRUED AS AN ACCURATE BOUNDARY SURVEY AND IS SUBJECT TO SUCH CHANGES AS AN ACCURATE BOUNDARY SURVEY MAY DISCLOSE. INFORMATION AND IMAGES ON THIS PLAN ARE THOSE FOUND THROUGH ONLINE STATE AND CITY/TOWN GIS DATABASES. THE INFORMATION SHOWN IS ONLY AS ACCURATE AS THE INFORMATION FOUND THROUGH ONLINE SITE RESEARCH. AERIAL IMAGE DEPICTED IS FROM 2014 USGS DIGITAL TRUE COLOR ORTHOPHOGRAPHY. THE ASSESSOR'S MAP ABOVE IS TAKEN FROM PLAN TITLED "TOWN OF GLOCESTER PLAT 18" PRODUCED BY THE TOWN OF GLOCESTER MAY OF 2017. PARCEL BOUNDARIES UP TO DATE AS OF DECEMBER 31, 2016. FOR BEST CLARITY, THIS SHEET SHOULD BE REPRODUCED IN COLOR ONLY.

Existing Conditions Legend

NON-COMMUNITY WELLHEAD PROTECTION AREA

DEPARTMENT OF ENVIRONMENTAL MANAGEMENT
OFFICE OF WATER RESOURCES
FRESHWATER WETLANDS PROGRAM
APPROVED WITH CONDITIONS
AS SPECIFIED IN THE LETTER OF APPROVAL
DATED MAR 20 2020 FILE # 19-03-2020
NO CHANGES ALLOWED WITHOUT PRIOR APPROVAL
APPROVED PLANS MUST BE AT CONSTRUCTION SITE

Kevin C. Morin
REGISTERED PROFESSIONAL ENGINEER
CIVIL

MAR 6 2020

Office of Water Resources

3760 Quaker Lane
North Kingstown, RI 02852
(401) 295-4998
www.green-ri.com

GREEN
development, LLC

APPLICANT: **GD Glocester White Oak I, LLC**
3760 QUAKER LANE, NORTH KINGSTOWN, RI 02852

PREPARED FOR: **Roger N Phillips, Patricia Eads & Paul Phillips**
74 WHITE OAK LANE, PO BOX 89, NORTH SCITUATE, RI 02857

PREPARED BY: **Green Development, LLC**
3760 QUAKER LANE, NORTH KINGSTOWN, RI 02852

NO.	DATE	REVISION
1	6/6/2018	PRE. APPLICATION SUBMISSION
2	1/7/2019	PRE. APPLICATION RESUBMISSION
3	2/8/2019	PRE. APPLICATION COMMENTS
4	4/2/2019	TOWN COMMENTS TO/AS SUBMISSION
5	4/2/2019	TOWN COMMENTS TO/AS SUBMISSION
6	11/7/2019	PRELIMINARY PLAN SUBMISSION
7	1/29/2020	FIRE DEPARTMENT COMMENTS
8	3/9/2020	RIEMA RESUBMISSION

SHEET TITLE:
Aerial & Map Sheet

PROJECT INFORMATION:
GD Glocester White Oak I
ALTERNATING CURRENT (AC) 1.80 MW
74 WHITE OAK LANE, GLOCESTER, RI 02857
ASSESSOR'S PLAT 18 LOT 73

SHEET NO.:
C1.2 OF 10

General Site Information:

- 1. APPLICANT INFORMATION: GD GLOCESTER WHITE OAK I, LLC
2. OWNER INFORMATION: ROGER N PHILLIPS, PATRICIA ETALS & PAUL PHILLIPS
3. SITE INFORMATION: 74 WHITE OAK LANE
4. FEMA INFORMATION: THE SITE IS LOCATED WITHIN ZONE X AND ZONE A AS DELINEATED ON THE FLOOD INSURANCE RATE MAP (FIRM) FOR THE TOWN OF GLOCESTER, PROVIDENCE COUNTY.
5. AREA INFORMATION: SITE WITHIN YES/NO
6. SOIL INFORMATION: SOIL NAME HSG DESCRIPTION
7. ZONING INFORMATION: EXISTING ZONE ZONE A-3
8. THIS PLAN IS NOT TO BE CONSTRUED AS AN ACCURATE BOUNDARY SURVEY AND IS SUBJECT TO SUCH CHANGES AS AN ACCURATE BOUNDARY SURVEY MAY DISCLOSE.

Certification Note:

THE PROPERTIES BOUNDARY LINE SHOWN WITHIN THIS PLAN SET DEPICTS A CLASS I BOUNDARY PROVIDED BY OCEAN STATE PLANNERS, INC. 1255 OAKLAWN AVENUE, CRANSTON, RHODE ISLAND DATED SEPTEMBER 24, 2008.

References:

REFERENCE MINOR SUBDIVISION FINAL PLAN, "THE PHILLIPS PLAT" AP 18 LOT 73 ELMDALE ROAD & SNAKE HILL ROAD, GLOCESTER RI PREPARED BY FOSTER SURVEY COMPANY LAST REVIEWED SEPTEMBER 14, 2005, RECORDED MAP 631, SHEETS 1-4 OF 4.

Development Information:

- 1. THE PROPOSED SOLAR ARRAY INSTALLATION WILL UTILIZE EXISTING TOPOGRAPHY WITH MINOR GRADE CHANGES PROPOSED FOR CONSTRUCTION OF TEMPORARY AND PERMANENT SOIL EROSION AND SEDIMENT CONTROL AND STORM WATER MANAGEMENT FEATURES.
2. THE PROJECT WILL BE CONSTRUCTED IN ONE PHASE.
3. THE PROPOSED SOLAR PROJECT REQUIRES THE FOLLOWING:
4. THE ELECTRIC LINES FROM THE SOLAR ARRAY WILL BE UNDERGROUND CONDUIT WITH A TRANSITION FROM UNDERGROUND CONDUIT TO OVERHEAD WIRE AT EXISTING UTILITY POLE 8040 (NORTH) LOCATED WITHIN THE 60' NATIONAL GRID EASEMENT ON SITE.

Development Calculation:

UNSUITABLE AREA: 37.63 AC (FROM ABOVE)
SUITABLE AREA: 41.06 AC (FROM ABOVE)
TOTAL AREA (WITHIN FENCE): 6.030 AC
MAXIMUM LOT COVERAGE: 15%
LOT COVERAGE CALCULATION: (EXISTING STRUCTURES + SOLAR LAND COVERAGE / SUITABLE AREA) x 100%

Suitable Area Calculation:


UNSUITABLE AREA:
ONSITE WETLAND AREA: 20.17 AC
50FT PERIMETER WETLAND AREA: 11.08 AC
20% OR GREATER SLOPE AREA: 1.05 AC
HISTORICAL CEMETERY AREA & BUFFER AREA: 0.30 AC
ELECTRICAL AND ACCESS EASEMENT AREA: 5.03 AC
TOTAL: 37.63 AC TOTAL

Sequence of Construction

- 1. SURVEY AND STAKE LIMIT OF SEDIMENTATION BARRIERS/LIMIT OF DISTURBANCE.
2. INSTALL PERIMETER EROSION CONTROL BARRIERS AS SHOWN ON THE PLANS ALONG LIMIT OF DISTURBANCE.
3. CLEAR BRUSH AND TREES ON SITE IF NECESSARY.
4. PRIOR TO REMOVAL OF STUMPS AND SOIL DISTURBANCE, INSTALL TEMPORARY SEDIMENT SWALE AND TRAPS AS PER PLANS.
5. GRUB AND REMOVE TREE STUMPS ON SITE IF NECESSARY.
6. RE-GRADE SITE AS NECESSARY PER PLANS.
7. INSTALL SOLAR PROJECT INCLUDING BUT NOT LIMITED TO THE INSTALLATION OF THE RACKING SYSTEM, UNDERGROUND CONDUIT, EQUIPMENT PADS, ACCESS PATH, PANELS, NEW UTILITY POLES ON SITE, FENCING, ETC. AS REQUIRED BY APPROVED PLANS.

Soil Erosion and Sediment Control Notes:

- 1. TEMPORARY SEDIMENT MEASURES AND TRAPS SHALL BE INSTALLED, INSPECTED, MAINTAINED AND REMOVED IN CONFORMANCE WITH ALL RULES AND REGULATIONS SET FORTH BY THE RHODE ISLAND DEPARTMENT OF ENVIRONMENTAL MANAGEMENT AND DESCRIBED WITHIN THE THOSE ISLAND SOIL EROSION AND SEDIMENT CONTROL HANDBOOK, LATEST REVISION, UNDER SECTION SIX FOR TEMPORARY SEDIMENT TRAPS.
2. ACCOMPANYING DOCUMENTS: SOIL EROSION AND SEDIMENT CONTROL PLAN (SESC) WHICH CONTAINS THE FOLLOWING:
3. CONTRACTOR TO REFER TO THE SESC FOR SEQUENCE OF CONSTRUCTION ACTIVITIES, PROJECT PHASING AND ADDITIONAL INFORMATION.
4. ALL EXISTING UTILITIES SHOWN ARE FROM VISIBLE INFORMATION, DRAWINGS FROM OTHERS, RIGIS DATA, SURVEYED INFORMATION AND/OR INFORMATION PROVIDED TO CONTRACTOR.

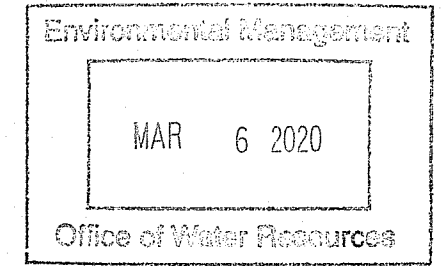



DEPARTMENT OF ENVIRONMENTAL MANAGEMENT
OFFICE OF WATER RESOURCES
FRESHWATER WETLANDS PROGRAM
APPROVED WITH CONDITIONS
AS SPECIFIED IN THE LETTER OF APPROVAL
DATED MAR 2 0 2020 FILE # 19-0329
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GREEN development, LLC logo and contact information for Roger N Phillips, Patricia Etals & Paul Phillips.

Table with columns for No., Date, and Revision, listing various engineering and planning milestones.

General Notes
Project Information:
GD Glocester White Oak I
ALTERNATING CURRENT(AC); 1.80 MW
74 WHITE OAK LANE, GLOCESTER, RI 02857
ASSESSOR'S PLAT 18 LOT 73



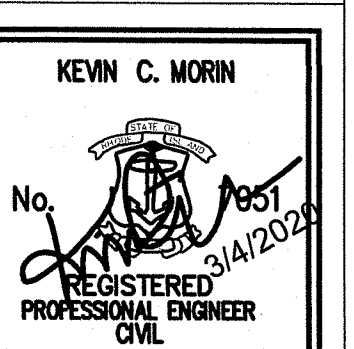


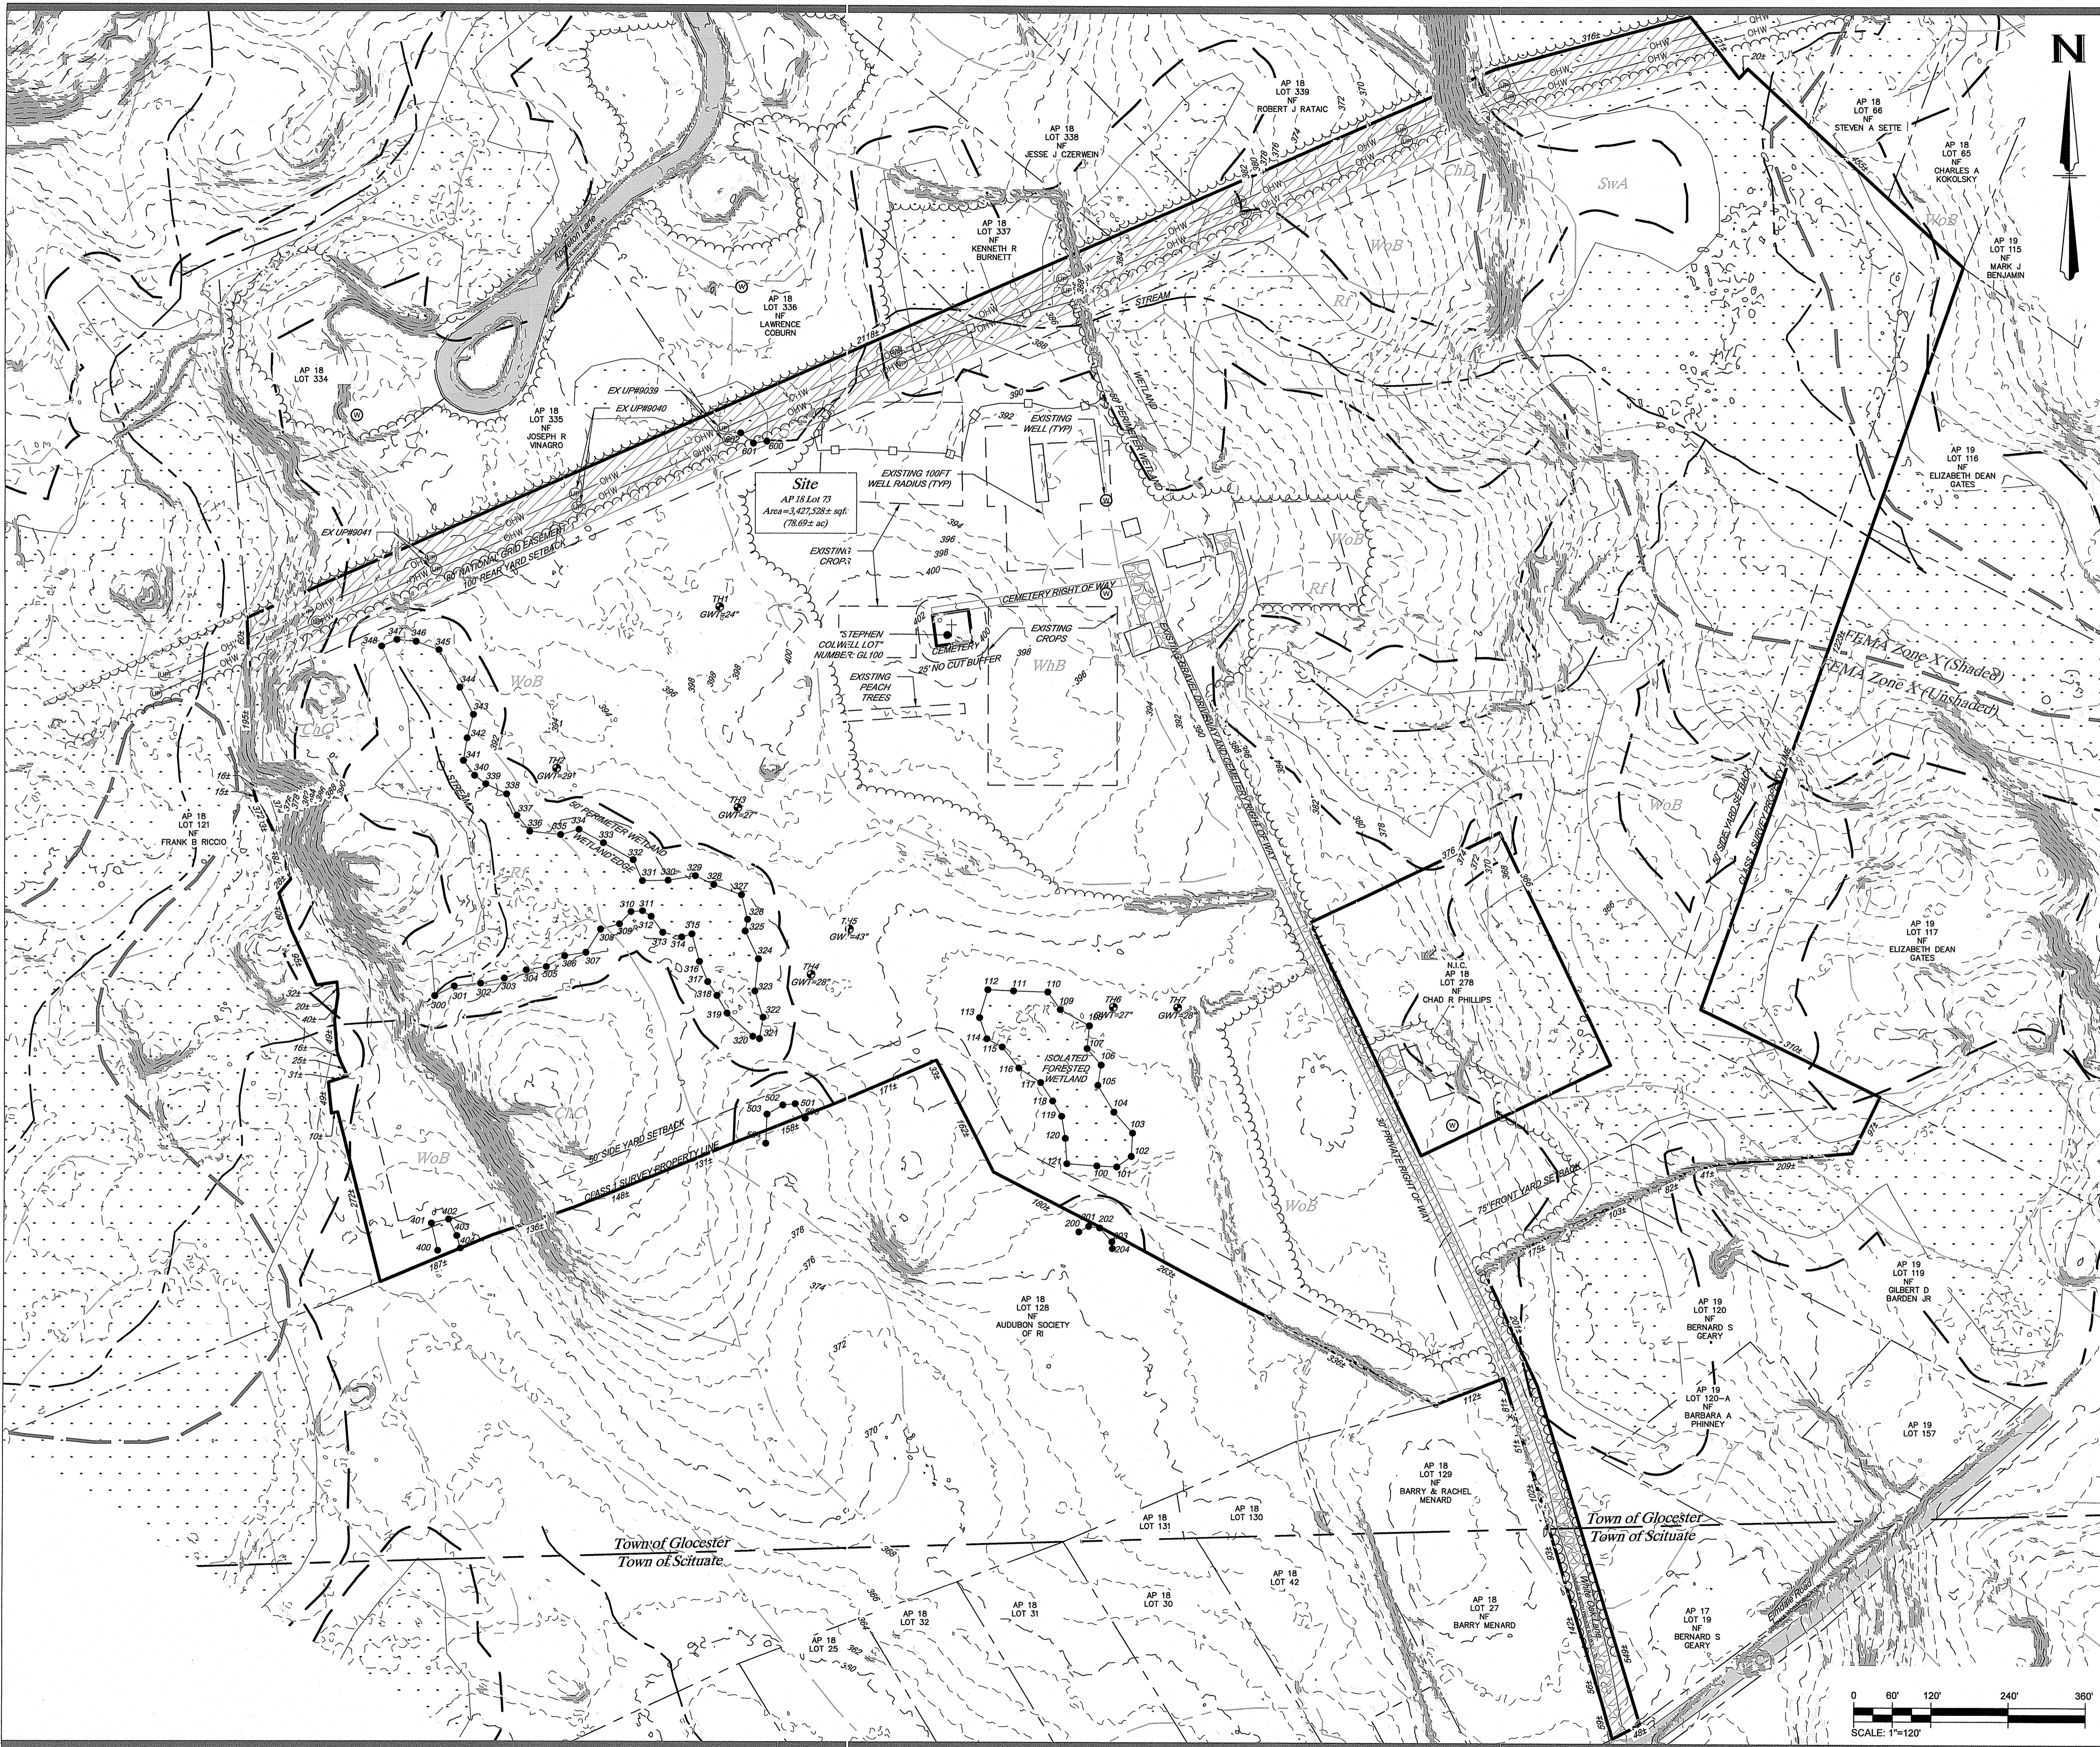Existing Conditions Legend

- STATE HIGHWAY LINE
- GIS WETLAND LINE
- WETLAND HATCH
- WETLAND FLAG AND WETLAND LINE
- 50 PERIMETER WETLAND LINE
- EDGE OF PAVEMENT
- PAVEMENT HATCH
- ASSESSOR LINE
- PROPERTY LINE
- SETBACK LINE
- USDA SOIL LINE
- USDA SOIL TYPE
- FEMA LINE
- ZONE LINE
- ZONE CLASSIFICATION
- MAJOR CONTOURS AND LABELS
- MINOR CONTOURS AND LABELS
- TREE LINE
- EASEMENT LINE & HATCH
- STONE WALL
- UTILITY POLE
- NO HATCH
- SLOPES < 15%
- 15% TO 20% SLOPES
- SLOPES > 20%

Environmental Management
MAR 6 2020
Office of Water Resources

DEPARTMENT OF ENVIRONMENTAL MANAGEMENT
OFFICE OF WATER RESOURCES
FRESHWATER WETLANDS PROGRAM
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Nancy L. Freeman

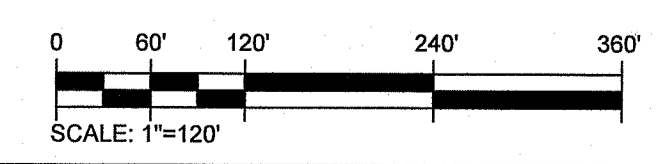

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North Kingstown, RI 02882
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www.green-ri.com

GREEN
development, LLC

APPLICANT: **GD Glocester White Oak I, LLC**
3760 QUAKER LANE, NORTH KINGSTOWN, RI 02882

PREPARED FOR: **Roger N Phillips, Patricia Etabs & Paul Phillips**
74 WHITE OAK LANE, PO BOX 89, NORTH SCITUATE, RI 02857

PREPARED BY: **Green Development, LLC**
3760 QUAKER LANE, NORTH KINGSTOWN, RI 02882

NO.	DATE	REVISION	BY
8	3/9/2020	FROM RESUBMISSION	BSB
7	1/29/2020	FRESHWATER WETLANDS PROGRAM	BSB
6	11/13/2019	PRELIMINARY PLAN SUBMISSION	BSB
5	6/7/2019	TOWN COMMENTS	NJC
4	4/23/2019	MASTER PLAN - TOWNING SUBMISSION	NJC
3	2/29/2019	FRESHWATER WETLANDS PROGRAM	NJC
2	1/24/2019	APPLICATION COMMENTS	NJC
1	6/12/2018	FRESHWATER WETLANDS PROGRAM	NJC


SHEET TITLE:
Existing Site Analysis Plan

PROJECT INFORMATION:
GD Glocester White Oak I
ALTERNATING CURRENT (AC); 1:80 MW
74 WHITE OAK LANE, GLOCESTER, RI 02857
ASSESSOR'S PLAT 18 LOT 73

KEVIN C. MORIN
No. 0651
REGISTERED PROFESSIONAL ENGINEER
CIVIL
2/14/2020

SHEET NO.:
C1.4 OF 10

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Soil Erosion & Sediment Control Legend

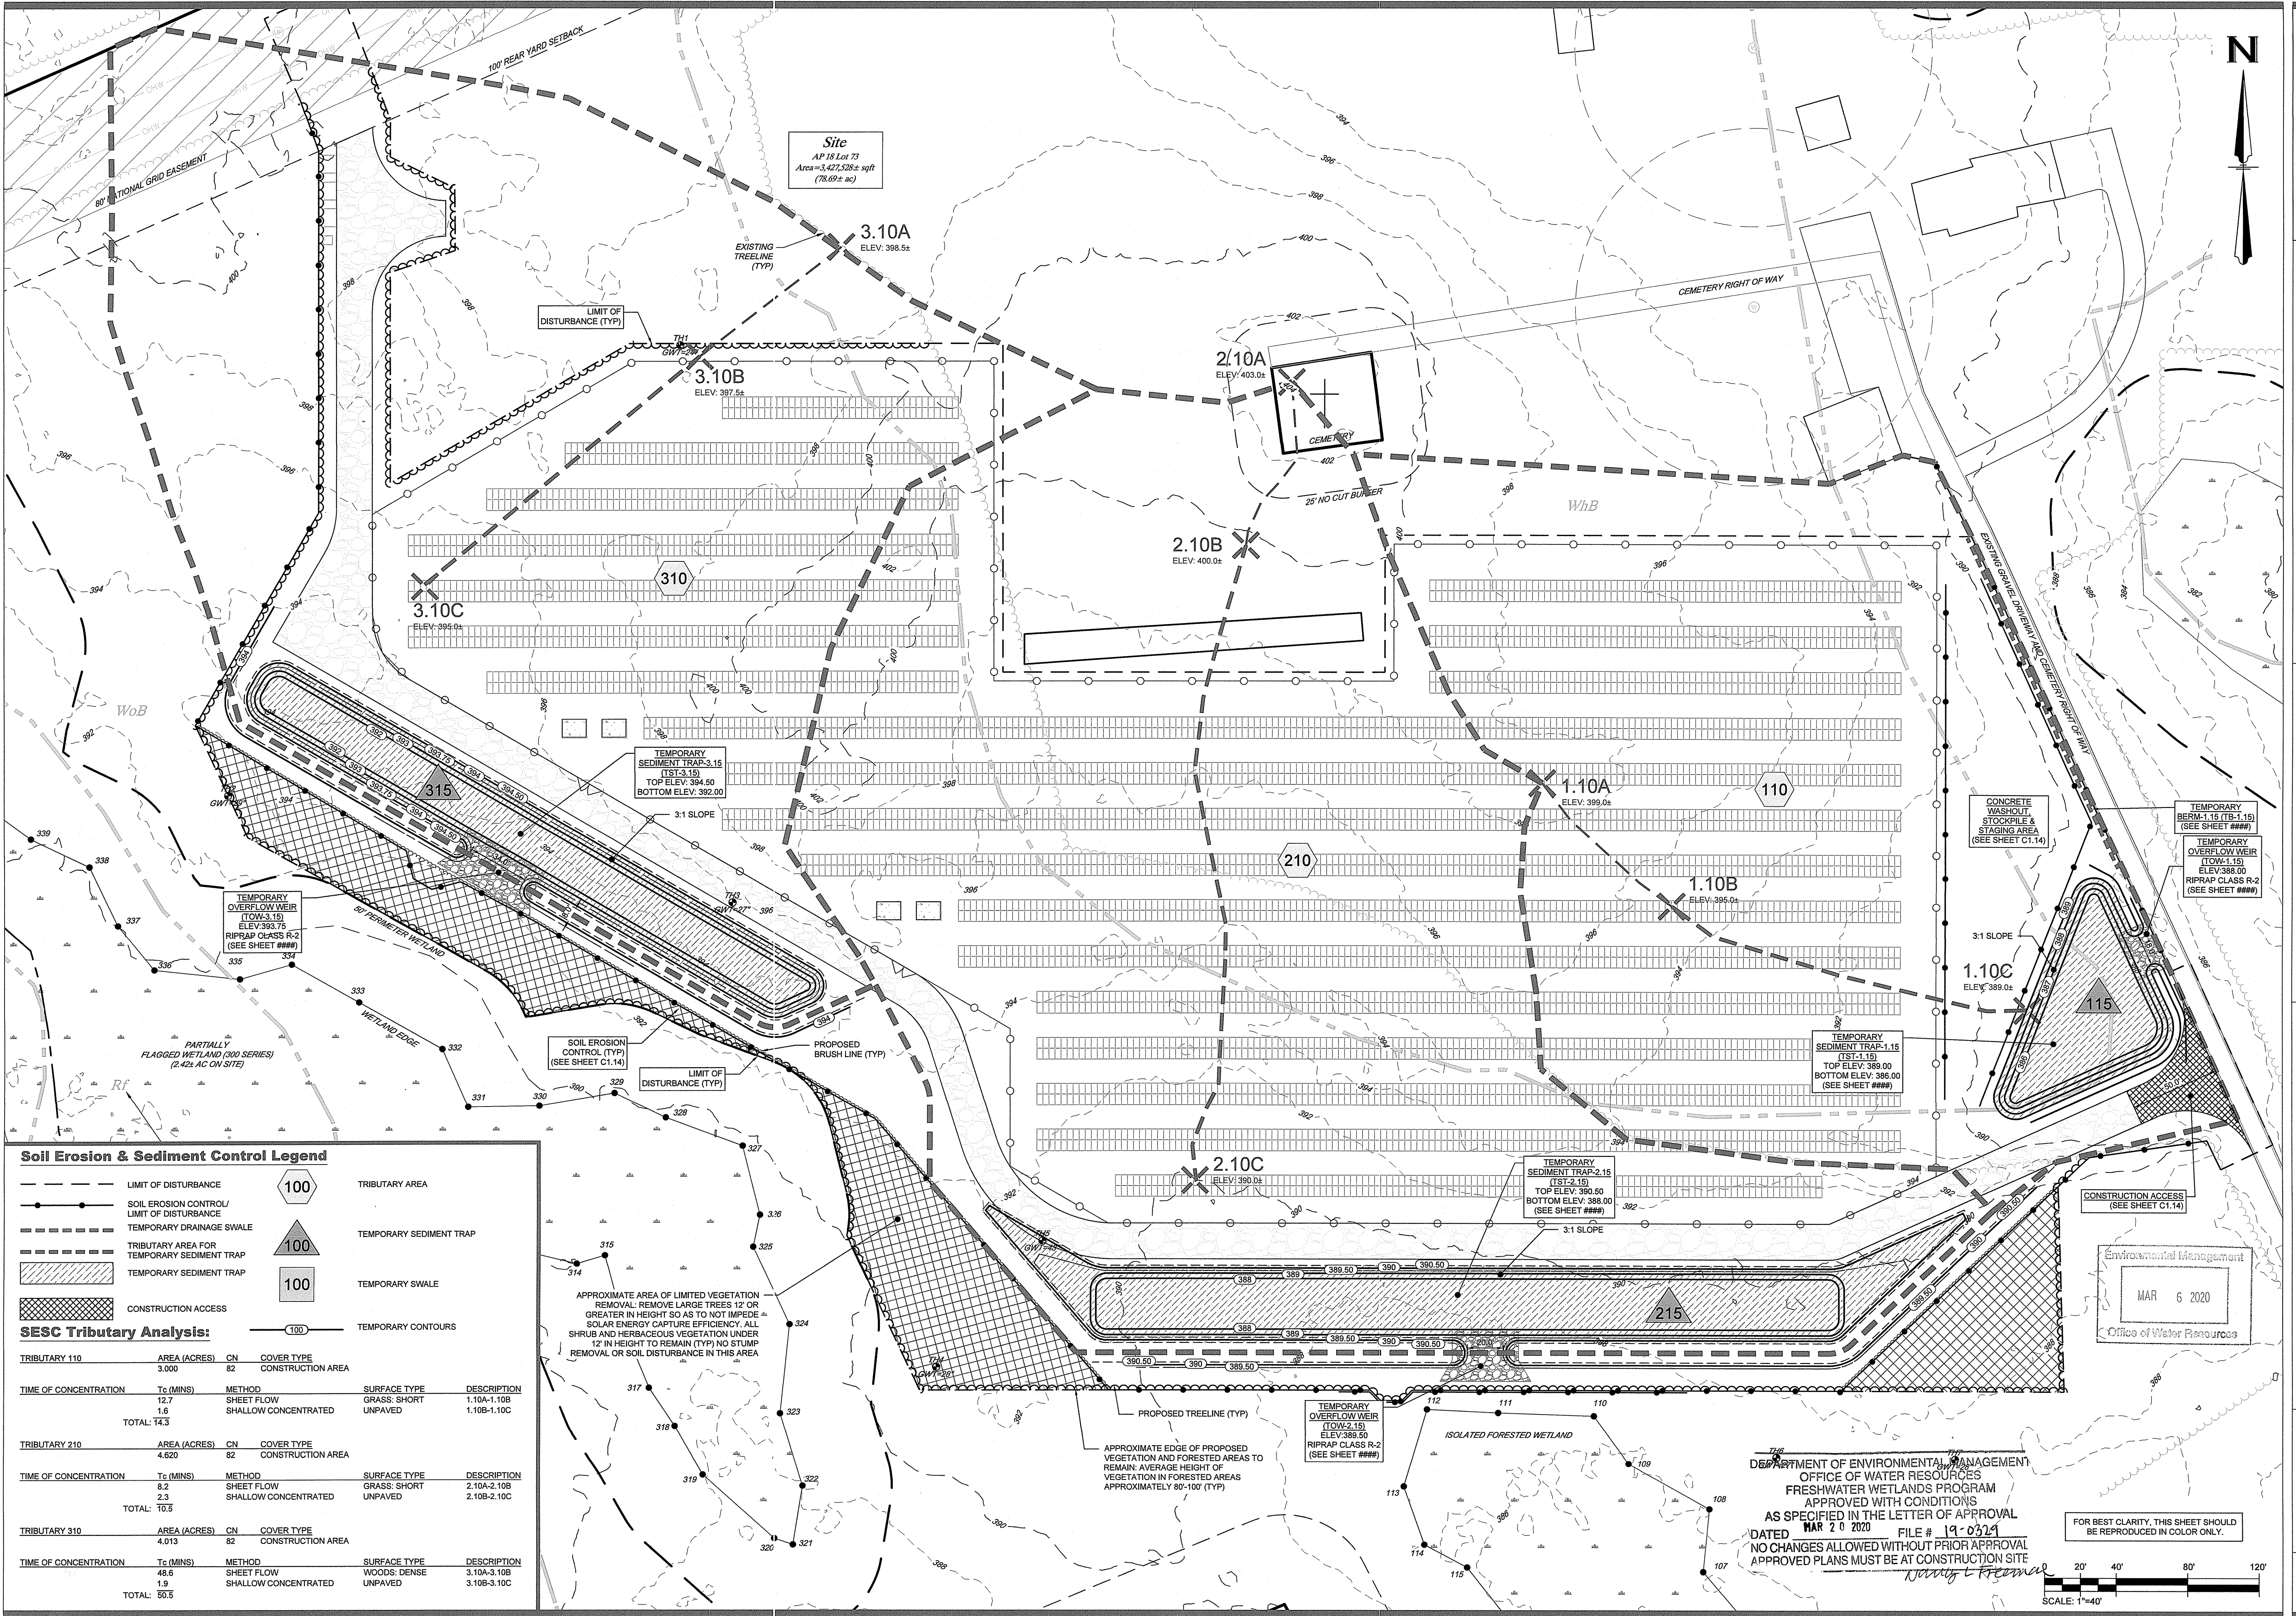- LIMIT OF DISTURBANCE
- SOIL EROSION CONTROL / LIMIT OF DISTURBANCE
- TEMPORARY DRAINAGE SWALE
- TRIBUTARY AREA FOR TEMPORARY SEDIMENT TRAP
- TEMPORARY SEDIMENT TRAP
- CONSTRUCTION ACCESS
- 100 TRIBUTARY AREA
- 100 TEMPORARY SEDIMENT TRAP
- 100 TEMPORARY SWALE
- 100 TEMPORARY CONTOURS

SEESC Tributary Analysis:


TRIBUTARY	AREA (ACRES)	CN	COVER TYPE	
TRIBUTARY 110	3.000	82	CONSTRUCTION AREA	
TIME OF CONCENTRATION	Tc (MINS)	METHOD	SURFACE TYPE	DESCRIPTION
	12.7	SHEET FLOW	GRASS: SHORT	1.10A-1.10B
	1.6	SHALLOW CONCENTRATED	UNPAVED	1.10B-1.10C
TOTAL:	14.3			
TRIBUTARY 210	AREA (ACRES)	CN	COVER TYPE	
TRIBUTARY 210	4.620	82	CONSTRUCTION AREA	
TIME OF CONCENTRATION	Tc (MINS)	METHOD	SURFACE TYPE	DESCRIPTION
	8.2	SHEET FLOW	GRASS: SHORT	2.10A-2.10B
	2.3	SHALLOW CONCENTRATED	UNPAVED	2.10B-2.10C
TOTAL:	10.5			
TRIBUTARY 310	AREA (ACRES)	CN	COVER TYPE	
TRIBUTARY 310	4.013	82	CONSTRUCTION AREA	
TIME OF CONCENTRATION	Tc (MINS)	METHOD	SURFACE TYPE	DESCRIPTION
	48.6	SHEET FLOW	WOODS: DENSE	3.10A-3.10B
	1.9	SHALLOW CONCENTRATED	UNPAVED	3.10B-3.10C
TOTAL:	50.5			

APPROXIMATE AREA OF LIMITED VEGETATION REMOVAL: REMOVE LARGE TREES 12" OR GREATER IN HEIGHT SO AS TO NOT IMPEDE SOLAR ENERGY CAPTURE EFFICIENCY. ALL SHRUB AND HERBACEOUS VEGETATION UNDER 12" IN HEIGHT TO REMAIN (TYP) NO STUMP REMOVAL OR SOIL DISTURBANCE IN THIS AREA

APPROXIMATE EDGE OF PROPOSED VEGETATION AND FORESTED AREAS TO REMAIN: AVERAGE HEIGHT OF VEGETATION IN FORESTED AREAS APPROXIMATELY 80-100' (TYP)

DEPARTMENT OF ENVIRONMENTAL MANAGEMENT
OFFICE OF WATER RESOURCES
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FOR BEST CLARITY, THIS SHEET SHOULD BE REPRODUCED IN COLOR ONLY.

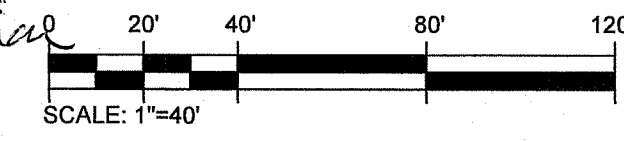

3760 Quaker Lane
North Kingstown, RI 02852
(401) 295-4998
www.green-ri.com

GREEN
development, LLC

APPLICANT: **GD Glocester White Oak I, LLC**
3760 QUAKER LANE, NORTH KINGSTOWN, RI 02852

PREPARED FOR: **Roger N Phillips, Patricia Etals & Paul Phillips**
74 WHITE OAK LANE, PO BOX 89, NORTH SCITUATE, RI 02857

PREPARED BY: **Green Development, LLC**
3760 QUAKER LANE, NORTH KINGSTOWN, RI 02852

REVISION

No.	DATE	REVISION
1	6/9/2018	FIRE APPLICATION SUBMISSION
2	1/17/2019	FIRE APPLICATION SUBMISSION
3	4/23/2019	WATER PLAN ZONING SUBMISSION
4	6/27/2019	TOWN COMMENTS
5	6/27/2019	PRELIMINARY PLAN SUBMISSION
6	11/29/2019	FIRE DEPARTMENT COMMENTS
7	1/29/2020	FIRE DEPARTMENT COMMENTS
8	3/5/2020	RDIM RESUBMISSION

SHEET TITLE:
SEESC - Overall Proposed Site Plan

PROJECT INFORMATION:
GD Glocester White Oak I
ALTERNATING CURRENT (AC): 180 MW
74 WHITE OAK LANE, GLOCESTER, RI 02857
ASSESSOR'S PLAT 18 LOT 73

KEVIN C. MORIN
No. 19051
REGISTERED PROFESSIONAL ENGINEER
CIVIL
3/14/2020

Environmental Management
MAR 6 2020
Office of Water Resources

CONSTRUCTION ACCESS (SEE SHEET C1.14)

Environmental Management
MAR 6 2020
Office of Water Resources

CONSTRUCTION ACCESS (SEE SHEET C1.14)

Environmental Management
MAR 6 2020
Office of Water Resources

CONSTRUCTION ACCESS (SEE SHEET C1.14)



Environmental Management
MAR 6 2020
Office of Water Resources

CONSTRUCTION ACCESS (SEE SHEET C1.14)

Environmental Management
MAR 6 2020
Office of Water Resources

CONSTRUCTION ACCESS (SEE SHEET C1.14)

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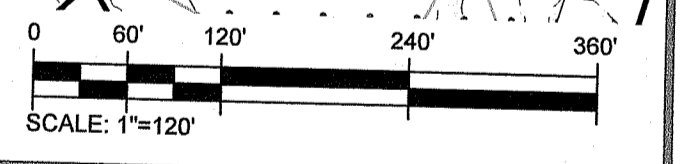


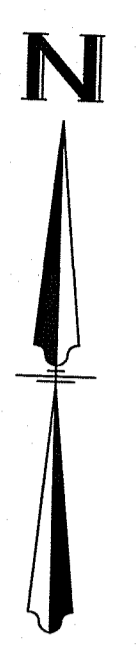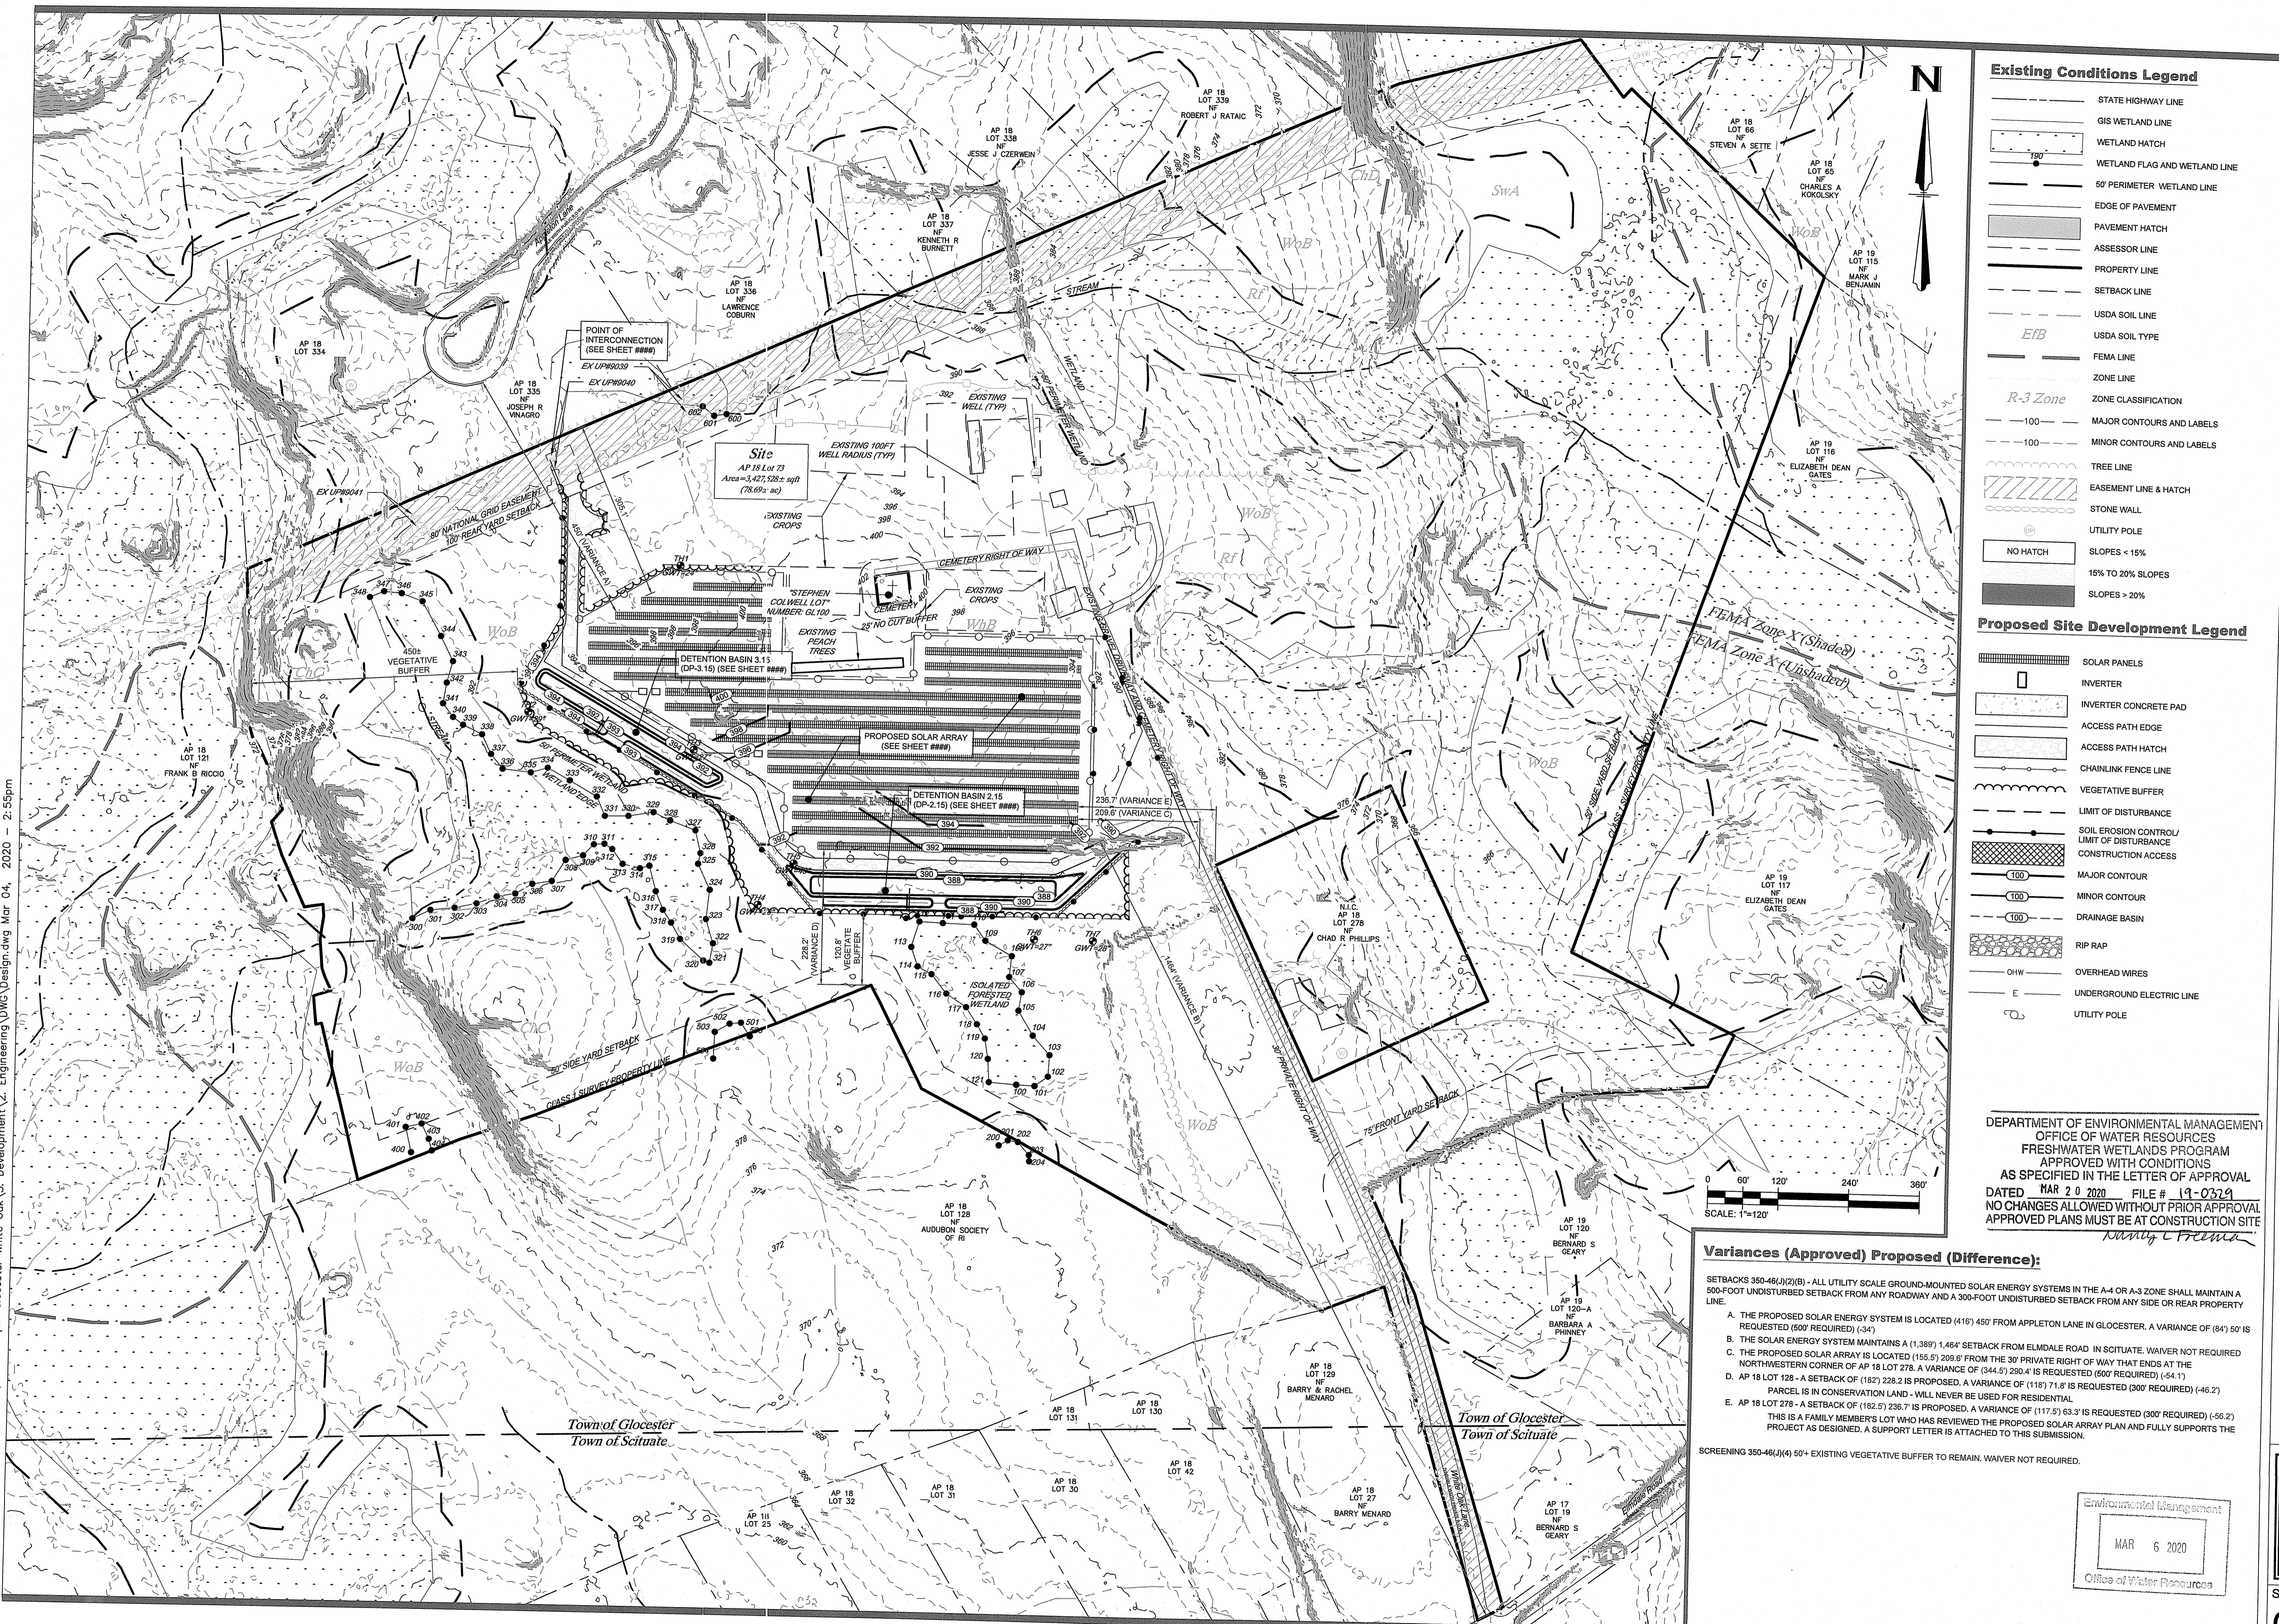Existing Conditions Legend

- STATE HIGHWAY LINE
- GIS WETLAND LINE
- WETLAND HATCH
- WETLAND FLAG AND WETLAND LINE
- 50' PERIMETER WETLAND LINE
- EDGE OF PAVEMENT
- PAVEMENT HATCH
- ASSESSOR LINE
- PROPERTY LINE
- SETBACK LINE
- USDA SOIL LINE
- USDA SOIL TYPE
- FEMA LINE
- ZONE LINE
- R-3 Zone
- ZONE CLASSIFICATION
- MAJOR CONTOURS AND LABELS
- MINOR CONTOURS AND LABELS
- TREE LINE
- EASEMENT LINE & HATCH
- STONE WALL
- UTILITY POLE
- SLOPES < 15%
- 15% TO 20% SLOPES
- SLOPES > 20%

Proposed Site Development Legend

- SOLAR PANELS
- INVERTER
- INVERTER CONCRETE PAD
- ACCESS PATH EDGE
- ACCESS PATH HATCH
- CHAINLINK FENCE LINE
- VEGETATIVE BUFFER
- LIMIT OF DISTURBANCE
- SOIL EROSION CONTROL/ LIMIT OF DISTURBANCE
- CONSTRUCTION ACCESS
- MAJOR CONTOUR
- MINOR CONTOUR
- DRAINAGE BASIN
- RIP RAP
- OHW
- OVERHEAD WIRES
- E
- UNDERGROUND ELECTRIC LINE
- UTILITY POLE



DEPARTMENT OF ENVIRONMENTAL MANAGEMENT
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Nancy L Felma

Variations (Approved) Proposed (Difference):

SETBACKS 350-46(J)(2)(B) - ALL UTILITY SCALE GROUND-MOUNTED SOLAR ENERGY SYSTEMS IN THE A-4 OR A-3 ZONE SHALL MAINTAIN A 500-FOOT UNDISTURBED SETBACK FROM ANY ROADWAY AND A 300-FOOT UNDISTURBED SETBACK FROM ANY SIDE OR REAR PROPERTY LINE.

- THE PROPOSED SOLAR ENERGY SYSTEM IS LOCATED (416) 450' FROM APPLETON LANE IN GLOCESTER. A VARIANCE OF (64) 50' IS REQUESTED (500 REQUIRED) (-34)
- THE SOLAR ENERGY SYSTEM MAINTAINS A (1,389) 1,464' SETBACK FROM ELMDALE ROAD IN SCITUATE. WAIVER NOT REQUIRED
- THE PROPOSED SOLAR ARRAY IS LOCATED (155.5) 202.6' FROM THE 30' PRIVATE RIGHT OF WAY THAT ENDS AT THE NORTH-WESTERN CORNER OF AP 18 LOT 278. A VARIANCE OF (344.5) 280.4' IS REQUESTED (500 REQUIRED) (-54.1)
- AP 18 LOT 128 - A SETBACK OF (182) 228.2' IS PROPOSED. A VARIANCE OF (116) 71.8' IS REQUESTED (300 REQUIRED) (-46.2) PARCEL IS IN CONSERVATION LAND - WILL NEVER BE USED FOR RESIDENTIAL
- AP 18 LOT 278 - A SETBACK OF (182.5) 236.7' IS PROPOSED. A VARIANCE OF (117.5) 63.3' IS REQUESTED (300 REQUIRED) (-66.2) THIS IS A FAMILY MEMBER'S LOT WHO HAS REVIEWED THE PROPOSED SOLAR ARRAY PLAN AND FULLY SUPPORTS THE PROJECT AS DESIGNED. A SUPPORT LETTER IS ATTACHED TO THIS SUBMISSION.

SCREENING 350-46(J)(4) 50' EXISTING VEGETATIVE BUFFER TO REMAIN. WAIVER NOT REQUIRED.

Environmental Management
MAR 6 2020
Office of Water Resources

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GREEN
development, LLC

APPLICANT: **GD Glocester White Oak I, LLC**
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PREPARED FOR: **Roger N Phillips, Patricia Etala & Paul Phillips**
74 WHITE OAK LANE, PO BOX 89, NORTH SCITUATE, RI 02857
PREPARED BY: **Green Development, LLC**
3760 QUAKER LANE, NORTH KINGSTOWN, RI 02882


NO.	DATE	REVISION
1	5/9/2018	FIRE APPLICATION SUBMISSION
2	1/7/2019	FIRE APPLICATION SUBMISSION
3	2/8/2019	FIRE APPLICATION COMMENTS
4	4/23/2019	MASTER PLAN PLAN SUBMISSION
5	6/7/2019	PRELIMINARY PLAN COMMENTS
6	6/7/2019	PRELIMINARY PLAN SUBMISSION
7	7/29/2020	FIRE DEPARTMENT COMMENTS
8	3/9/2020	RIDM RESUBMISSION

SHEET TITLE: **Proposed Overall Site Plan**
PROJECT INFORMATION:
GD Glocester White Oak I
ALTERNATING CURRENT (AC) 1.80 MW
74 WHITE OAK LANE, GLOCESTER, RI 02857
ASSESSOR'S PLAT 18 LOT 73

KEVIN C. MORIN
No. 1951
REGISTERED PROFESSIONAL ENGINEER
CIVIL
3/4/2020

SHEET NO.: **C1.6 OF 10**

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North Kingstown, RI 02882
(401) 295-4998
www.green-h.com

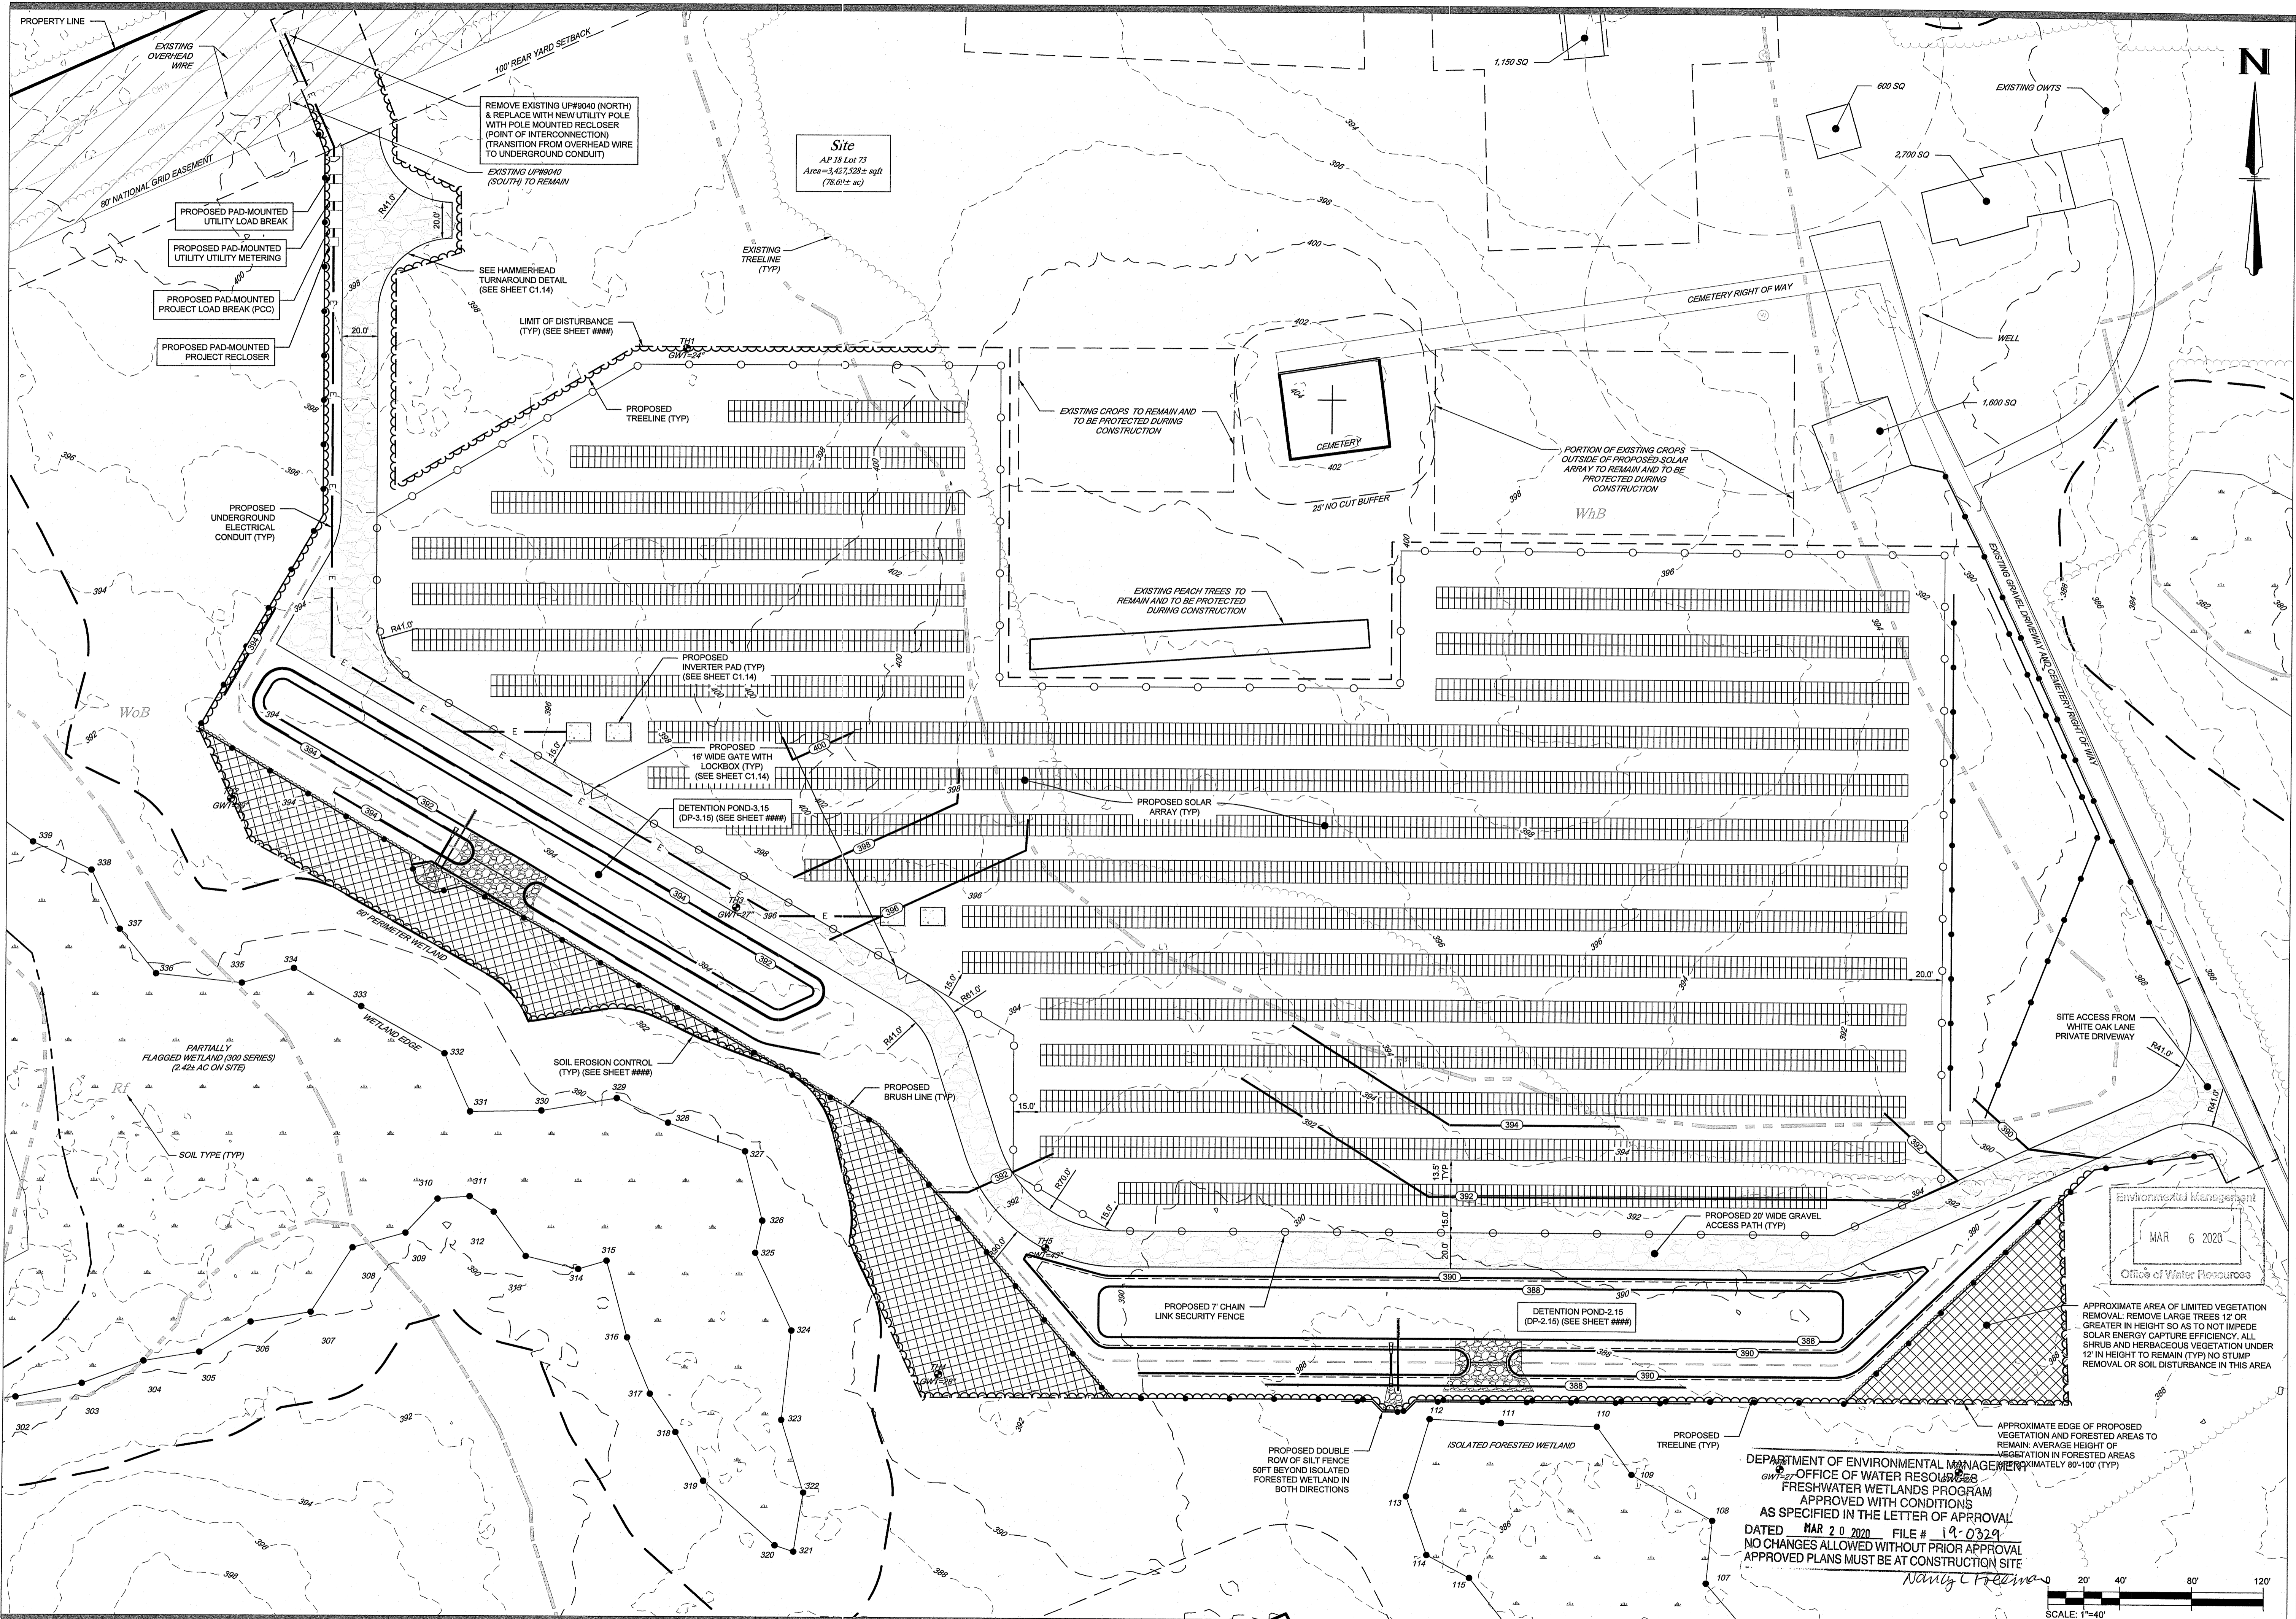GREEN
development, LLC

APPLICANT: **GD Glocester White Oak I, LLC**
3760 QUAKER LANE, NORTH KINGSTOWN, RI 02882


PREPARED FOR: **Roger N Phillips, Patricia Etals & Paul Phillips**
74 WHITE OAK LANE, PO BOX 85, NORTH SCITUATE, RI 02857

PREPARED BY: **Green Development, LLC**
3760 QUAKER LANE, NORTH KINGSTOWN, RI 02882

NO.	DATE	REVISION
1	3/5/2020	INITIAL SUBMISSION
2	3/12/2020	PRELIMINARY PLAN SUBMISSION
3	3/17/2020	FINAL PLAN SUBMISSION
4	4/23/2020	TOWN COMMENTS
5	4/23/2020	MASTER PLAN - ZONING SUBMISSION
6	5/7/2020	PRELIMINARY PLAN SUBMISSION
7	5/7/2020	FINAL PLAN SUBMISSION



SHEET TITLE:
Proposed Site Plan - Enlarged

PROJECT INFORMATION:
GD Glocester White Oak I
ALTERNATING CURRENT(A.C.): 1.80 MW
74 WHITE OAK LANE, GLOCESTER, RI 02857
ASSESSOR'S PLAT 18 LOT 73

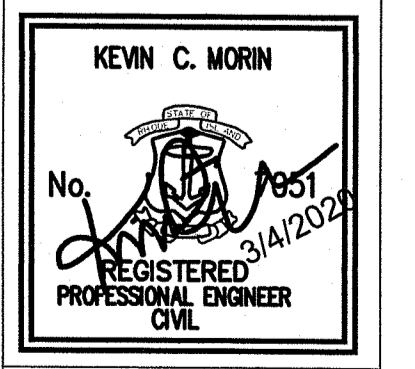

SHEET NO.:
C1.7 OF 10

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3760 Quaker Lane
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GREEN
development, LLC

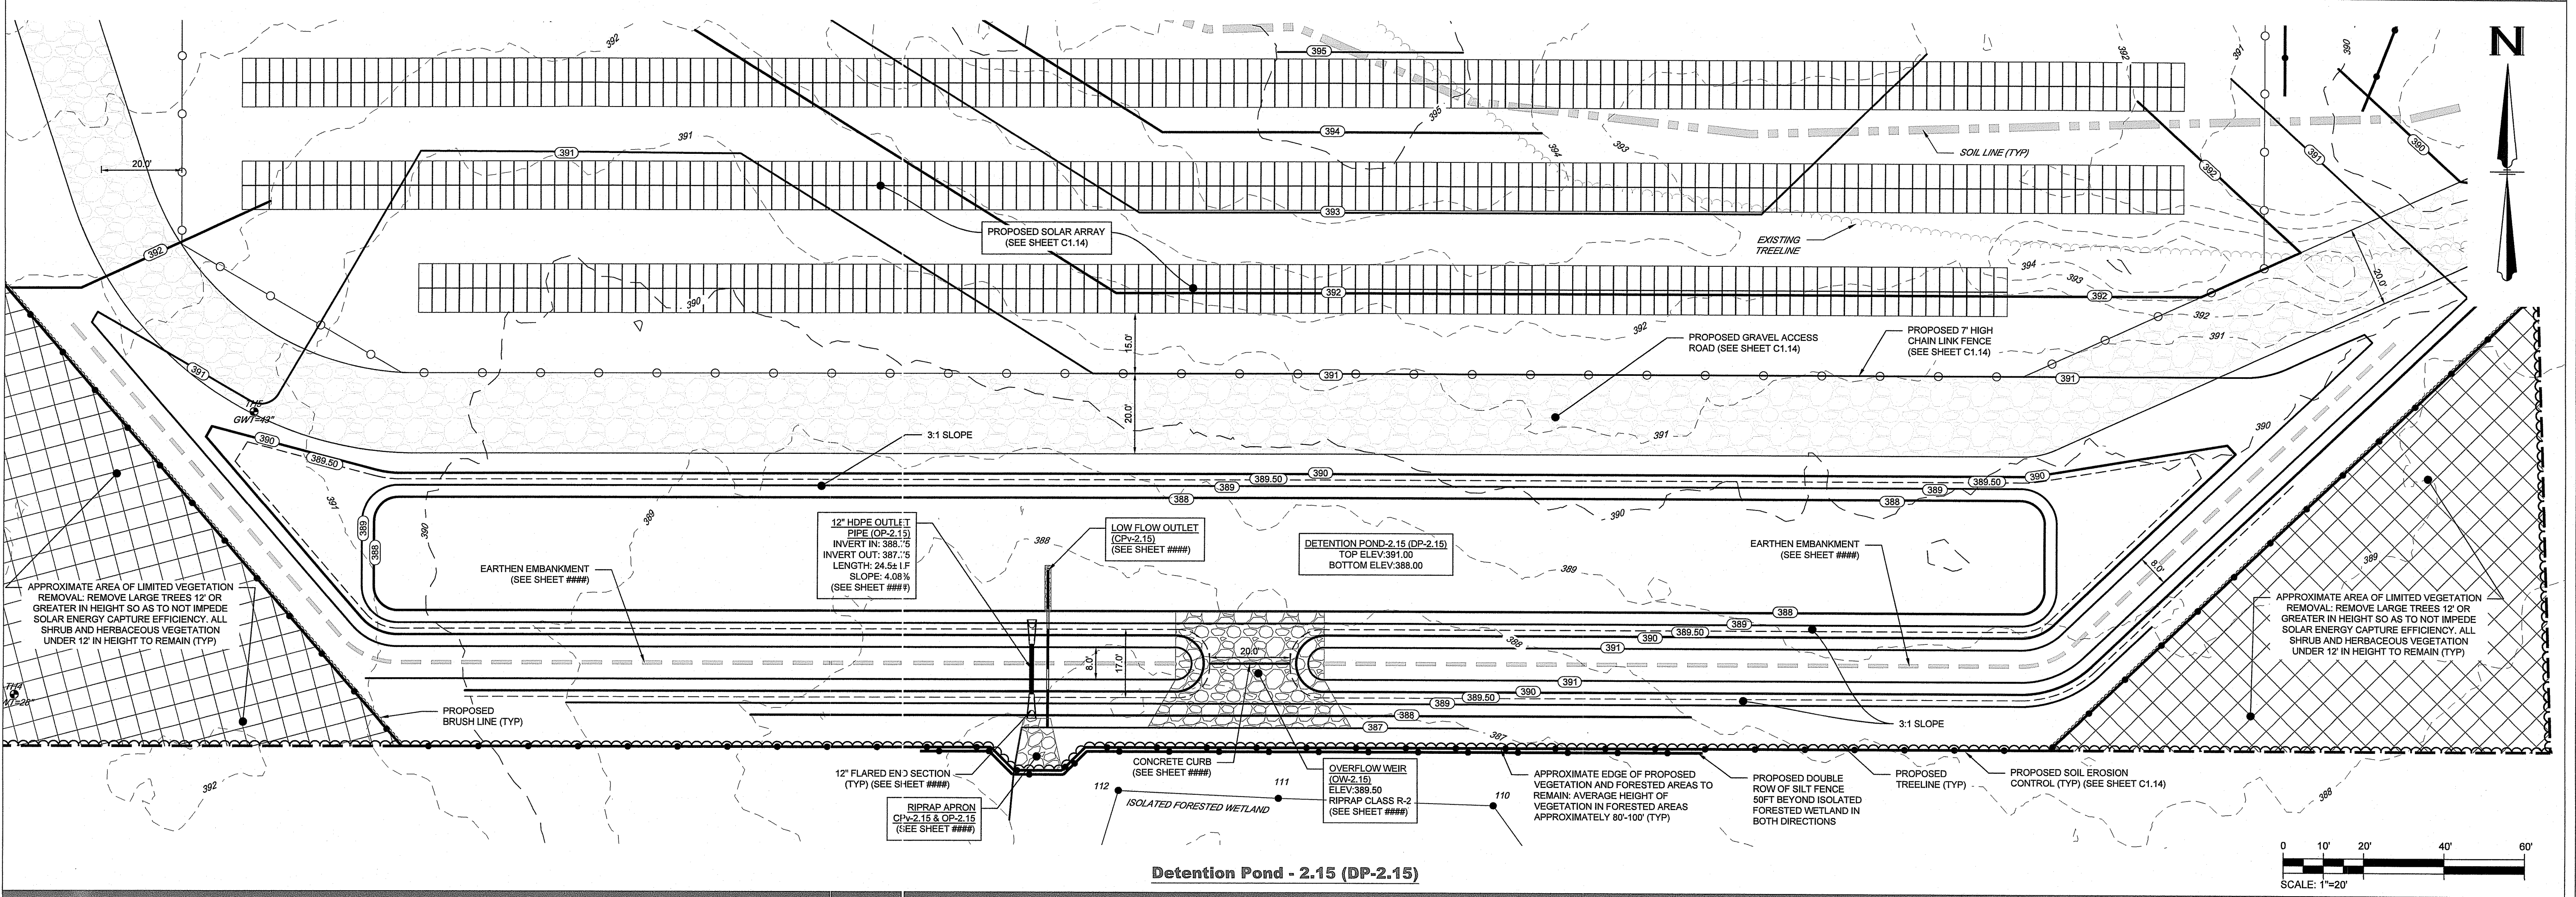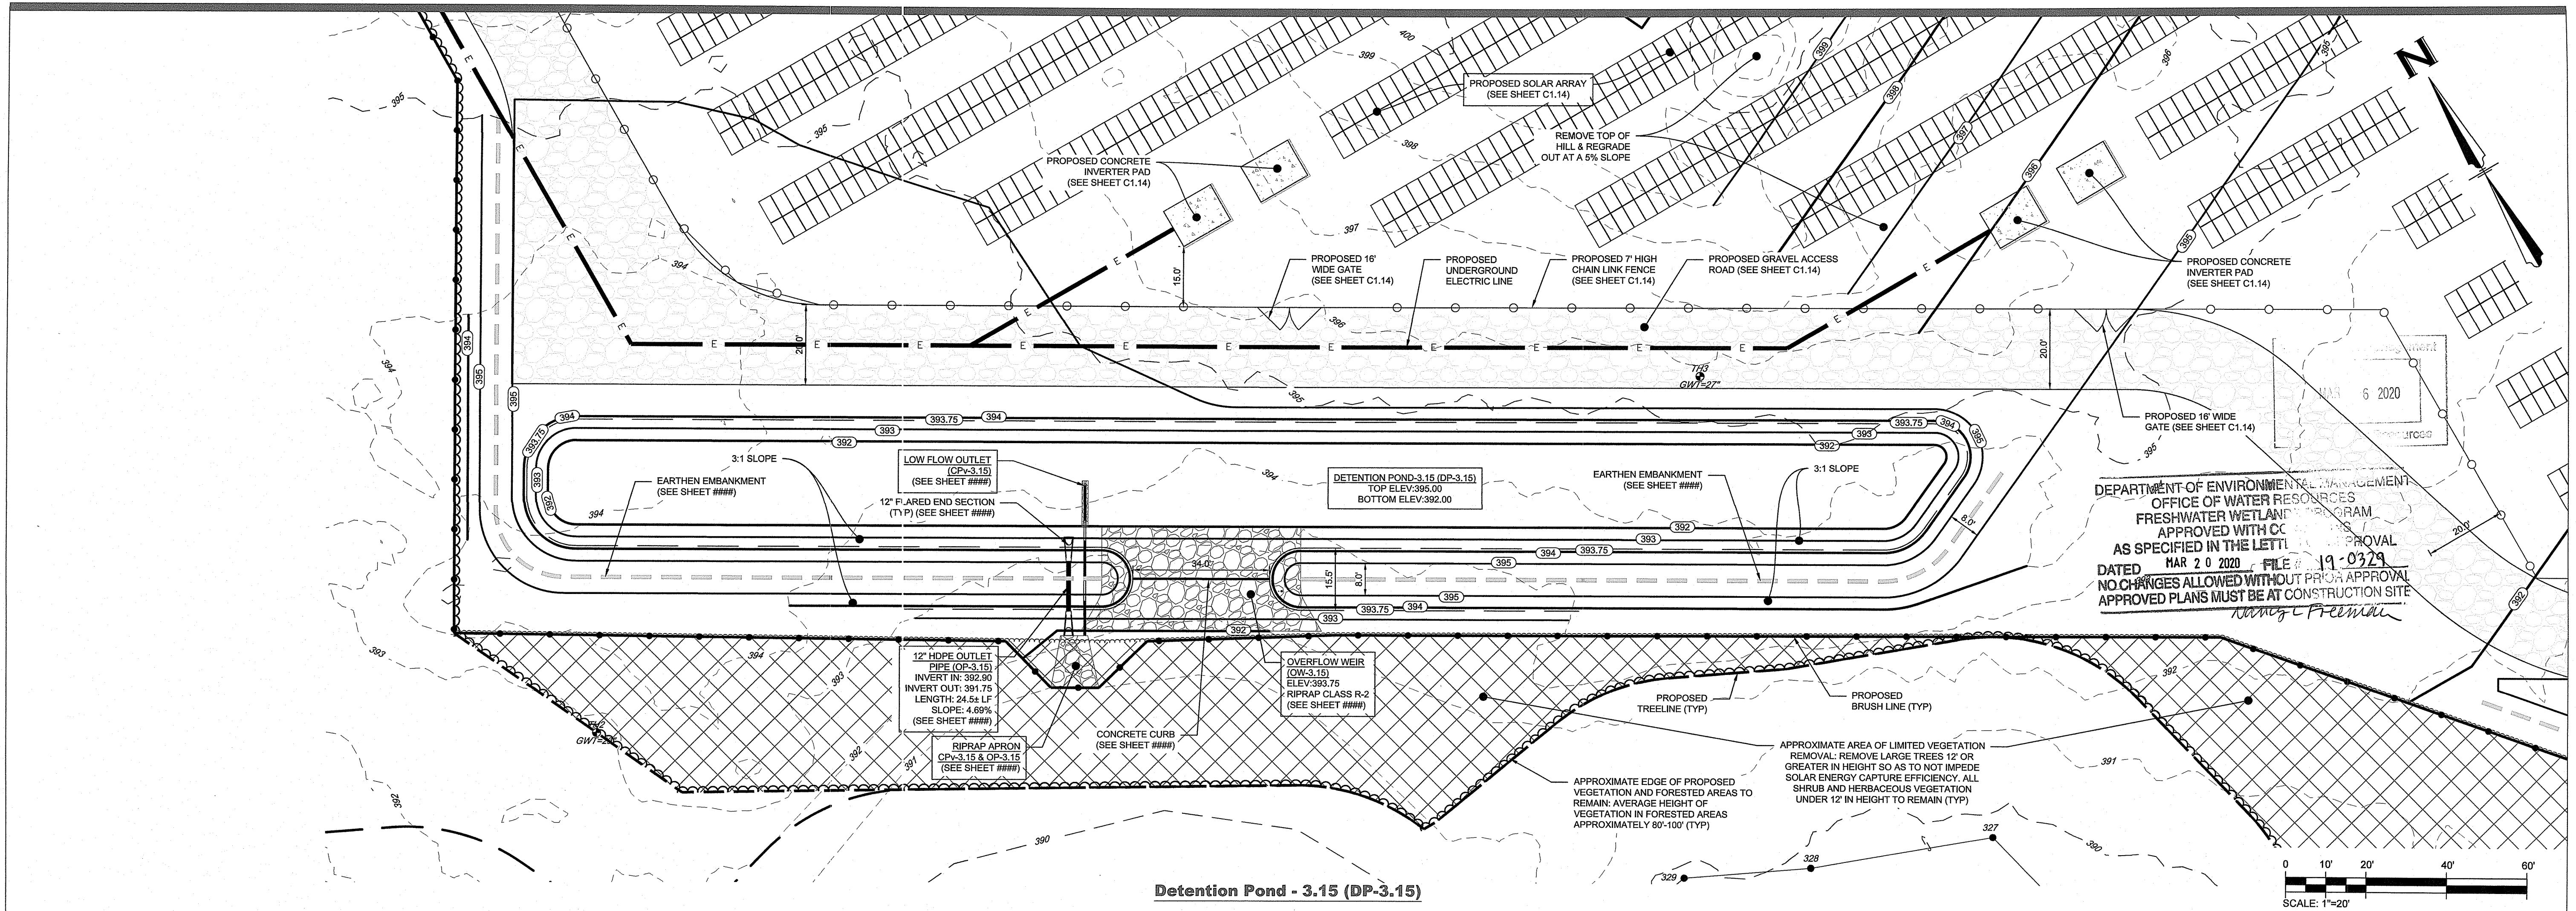APPLICANT: **GD Glocester White Oak I, LLC**
3760 QUAKER LANE, NORTH KINGSTOWN, RI 02852

PREPARED FOR: **Roger N Phillips, Patricia Etals & Paul Phillips**
74 WHITE OAK LANE, PO BOX 89, NORTH SCITUATE, RI 02857

PREPARED BY: **Green Development, LLC**
3760 QUAKER LANE, NORTH KINGSTOWN, RI 02852

NO.	DATE	REVISION
1	6/8/2018	FIRE APPLICATION SUBMISSION
2	1/17/2019	FIRE APPLICATION SUBMISSION
3	2/6/2019	FIRE APPLICATION SUBMISSION
4	6/7/2019	TOWN COMMENTS
5	6/7/2019	TOWN COMMENTS
6	11/29/2019	PRELIMINARY PLAN SUBMISSION
7	1/29/2020	FIRE DEPARTMENT COMMENTS
8	3/25/2020	RDAM RESUBMISSION

SHEET TITLE:
Enlarged View Ponds

PROJECT INFORMATION:
GD Glocester White Oak I
ALTERNATING CURRENT (AC): 150 MW
74 WHITE OAK LANE, GLOCESTER, RI 02857
ASSESSOR'S PLAT 18 LOT 73



KEVIN C. MORIN
No. 1851
REGISTERED PROFESSIONAL ENGINEER
CIVIL
3/14/2020

SHEET NO.:
C1.8 OF 10

TEMPORARY SEDIMENT TRAP DESIGN	TST-1.15	TST-2.15	TST-3.15
TOTAL DRAINAGE AREA (ACRES)	3.000	4.620	4.013
TOP OF SEDIMENT TRAP	388.00	390.50	394.50
BOTTOM OF SEDIMENT TRAP	386.00	388.00	392.00
10 YEAR STORM ELEVATION	388.19	389.57	393.84
100 YEAR STORM ELEVATION	388.49	390.04	394.03
FREEBOARD (FT)	0.51	0.46	0.47
POND SIDE SLOPES (H:V)	3:1	3:1	3:1
WET STORAGE DEPTH (FT) (Dw)	1.00	1.00	1.00
DRY STORAGE DEPTH (FT) (Dd)	1.00	1.00	1.00
TOTAL STORAGE DEPTH (FT) (D)	2.00	2.00	2.00
SURFACE AREA AT OUTLET (SQFT) (A _o)	7,470	21,345	12,770
WETTED SURFACE AREA (SQFT) (A _w)	6,415	16,985	11,055
SURFACE AREA AT BOTTOM (SQFT) (A _b)	4,475	11,690	7,160


TEMPORARY OVERFLOW WEIR (TOW) DESIGN	TOW-1.15	TOW-2.15	TOW-3.15
OVERFLOW WEIR ELEVATION	388.00	389.50	393.75
(OD) OVERFLOW WEIR DEPTH (FT)	1.00	1.00	1.00
(OL) OVERFLOW WEIR LENGTH (FT)	18.0	20.0	34.0
(OS) OVERFLOW WEIR SIDE SLOPE (FT)	3.00	3.00	3.00
(OW) OVERFLOW WEIR WIDTH (FT)	4.0	8.0	8.0
OVERFLOW WEIR RIPRAP CLASS	R-2	R-2	R-2

Top Width vs Height

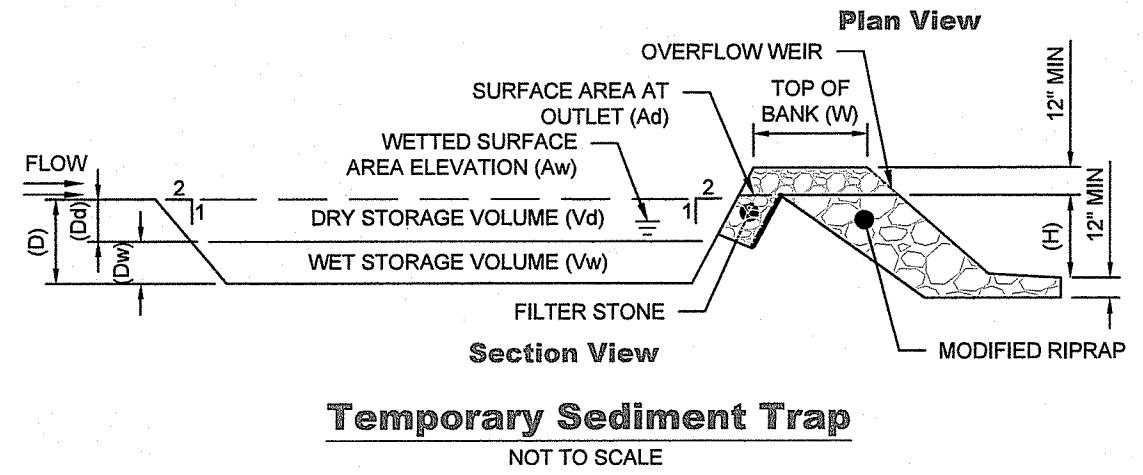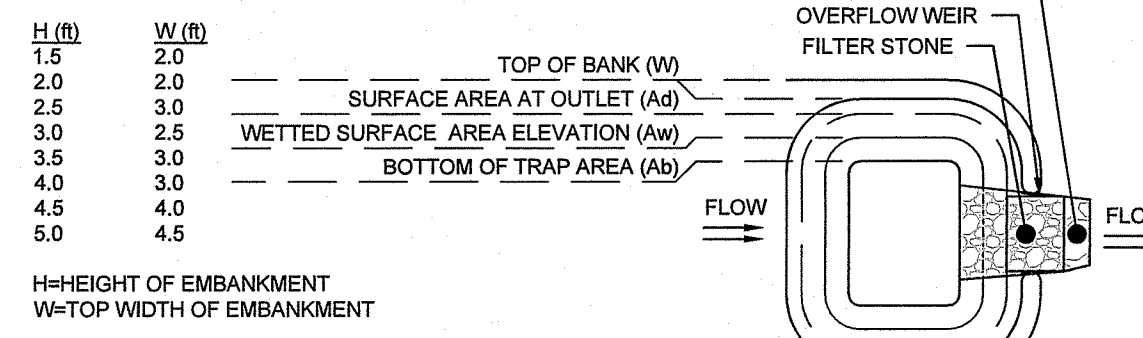

Temporary Sediment Trap
NOT TO SCALE

DESCRIPTION	TB-1.15
(L) LENGTH (FT)	200.0
(W) WIDTH (FT)	3.00
(H) HEIGHT (FT)	1.50
(S) SIDE SLOPES (H:V)	3:1
START ELEVATION	390.00
END ELEVATION	388.00
AVERAGE RUNNING SLOPE (%)	1.0

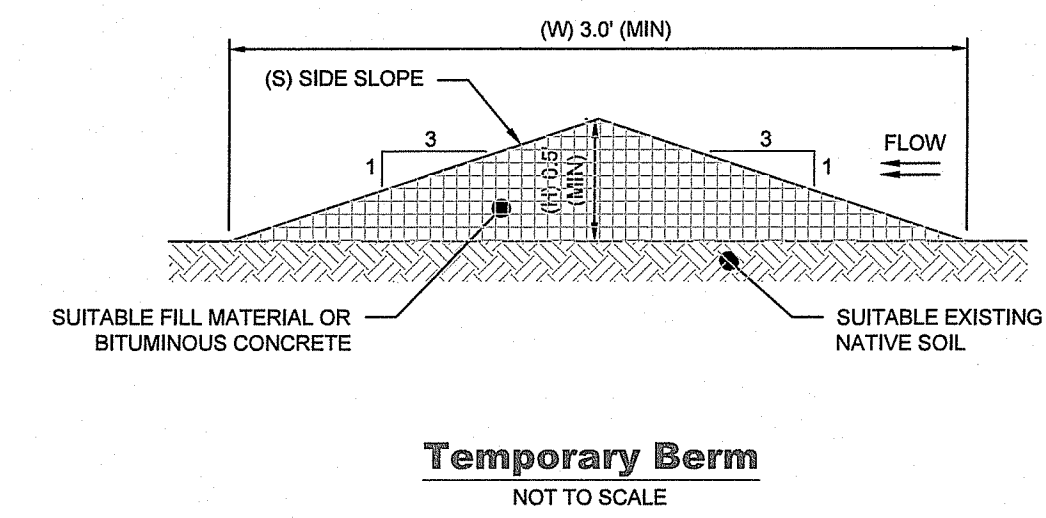

Temporary Berm
NOT TO SCALE

DEPARTMENT OF ENVIRONMENTAL MANAGEMENT
OFFICE OF WATER RESOURCES
FRESHWATER WETLANDS PROGRAM
APPROVED WITH CONDITIONS
AS SPECIFIED IN THE LETTER OF APPROVAL
DATED **MAR 20 2020** FILE # **19-0329**
NO CHANGES ALLOWED WITHOUT PRIOR APPROVAL
APPROVED PLANS MUST BE AT CONSTRUCTION SITE
Nancy L. Flynn



DETENTION POND DESIGN	DP-2.15	DP-3.15
TOP OF POND ELEVATION	391.00	395.00
BOTTOM OF POND ELEVATION	388.00	392.00
1.2" STORM ELEVATION	388.02	392.02
1 YEAR STORM ELEVATION	388.56	392.70
10 YEAR STORM ELEVATION	389.36	393.55
100 YEAR STORM ELEVATION	389.93	393.94
FREEBOARD (FT)	1.07	1.06
POND SIDE SLOPES (H:V)	3:1	3:1

GROUND WATER ANALYSIS	DP-2.15	DP-3.15
TEST HOLE NUMBER USED	TH-4	TH-3
BOTTOM OF POND ELEVATION @ TOP	388.00	392.00
EXISTING GRADE (WORST CASE)	390.00	394.00
GROUND WATER DEPTH (FT)	2.33	2.25
GROUND WATER ELEVATION	387.67	391.75
GROUND WATER SEPARATION (FT)	0.33	0.25


OUTLET PIPE (OP) DESIGN	OP-2.15	OP-3.15
PIPE DIAMETER (IN)	12.0	12.0
PIPE MATERIAL	HDPE	HDPE
PIPE INVERT IN (FT)	388.75	392.90
PIPE INVERT OUT (FT)	387.75	391.75
PIPE LENGTH (FT)	24.5	24.5
PIPE SLOPE (%)	4.08	4.69

OVERFLOW WEIR (OW) DESIGN	OW-2.15	OW-3.15
OVERFLOW WEIR ELEVATION	389.50	393.75
(D) OVERFLOW WEIR DEPTH (FT)	1.50	1.50
(L) OVERFLOW WEIR LENGTH (FT)	20.0	34.0
(W) OVERFLOW WEIR WIDTH (FT)	17.0	15.5
(B) BERM WIDTH (FT)	8.00	8.00
(S) OVERFLOW WEIR SLOPED LENGTH (FT)	4.50	4.50
OVERFLOW WEIR RIPRAP CLASS	R-2	R-2


(SEE OVERFLOW WEIR & EARTHEN EMBANKMENT DETAIL BELOW)

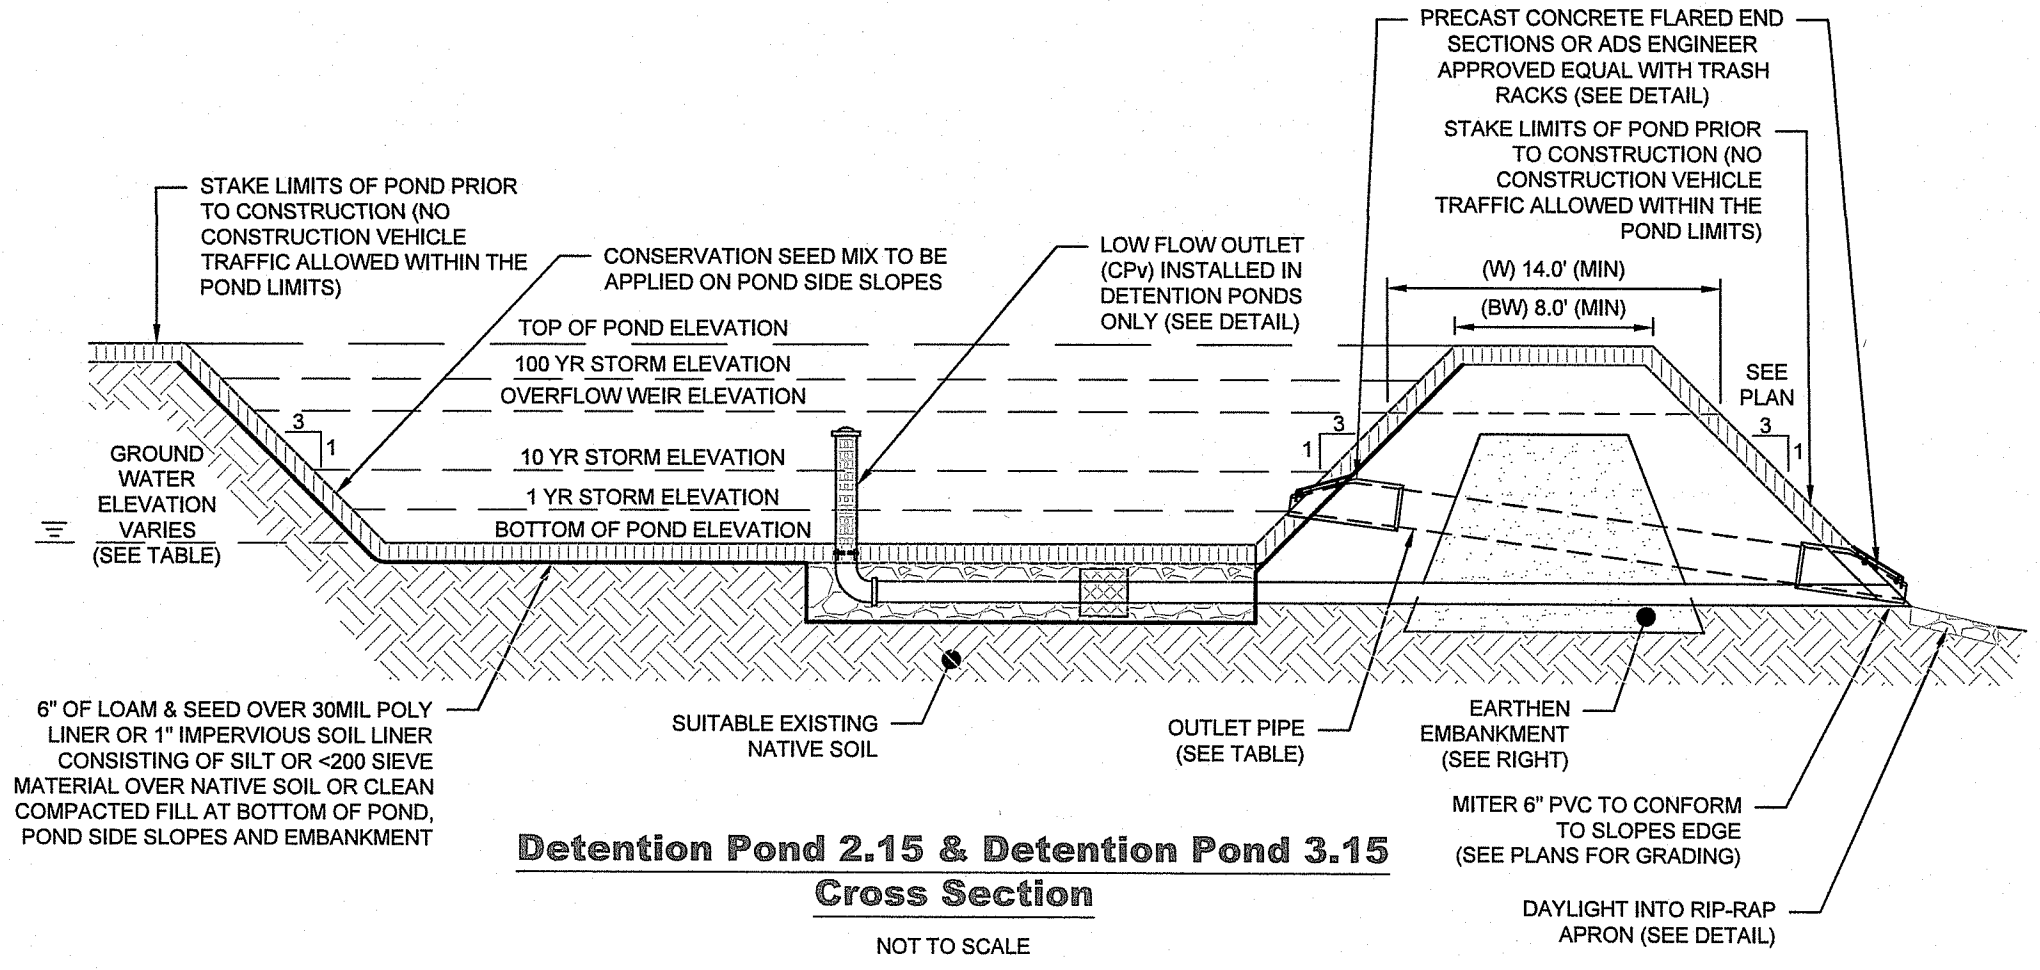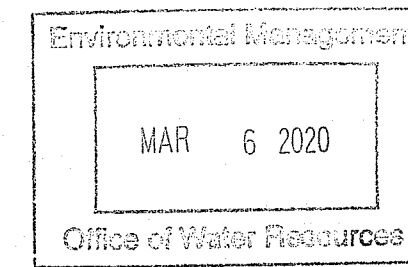


Detention Pond 2.15 & Detention Pond 3.15
Cross Section
NOT TO SCALE

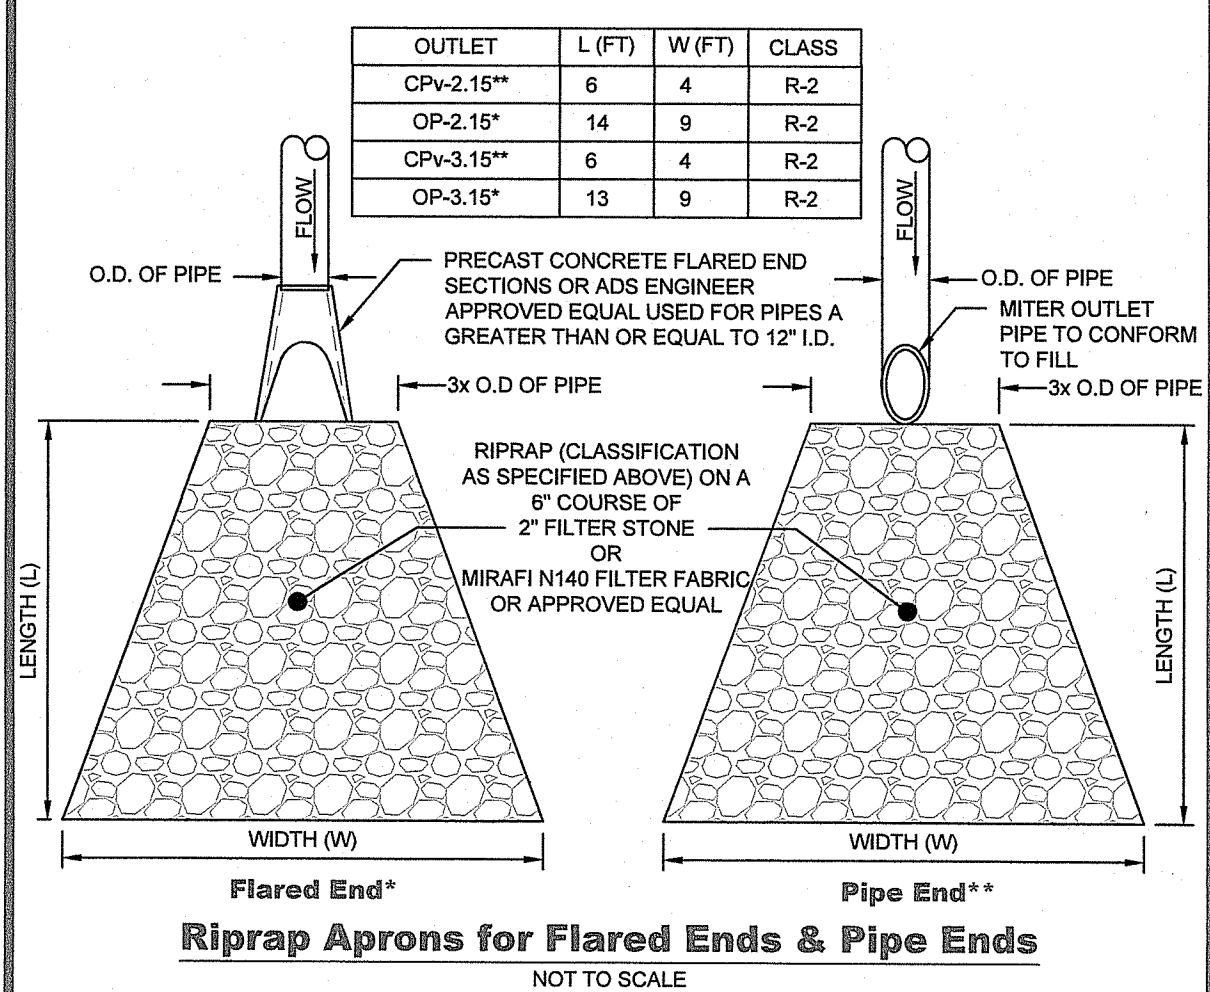


Riprap Aprons for Flared Ends & Pipe Ends
NOT TO SCALE

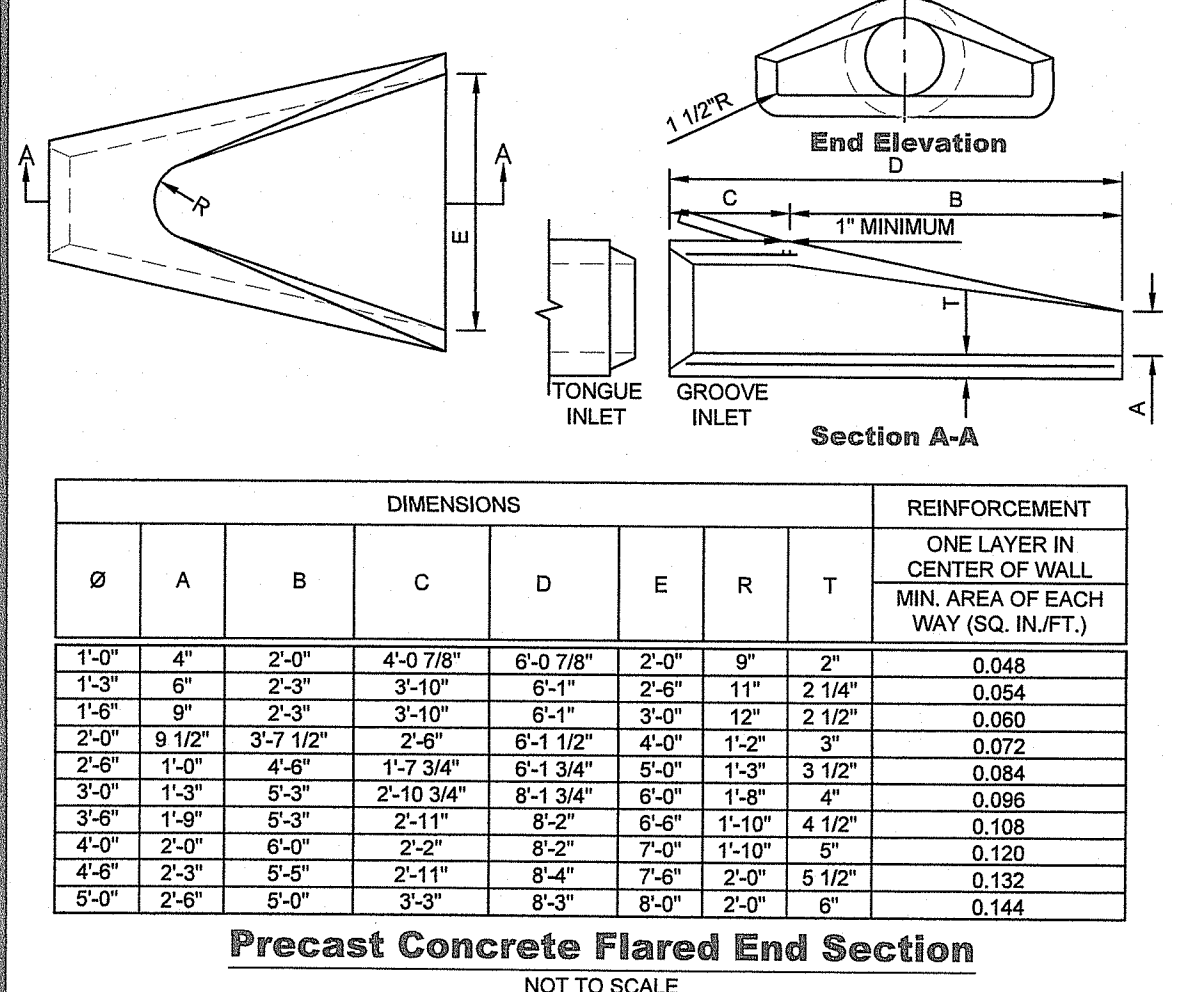


Precast Concrete Flared End Section
NOT TO SCALE

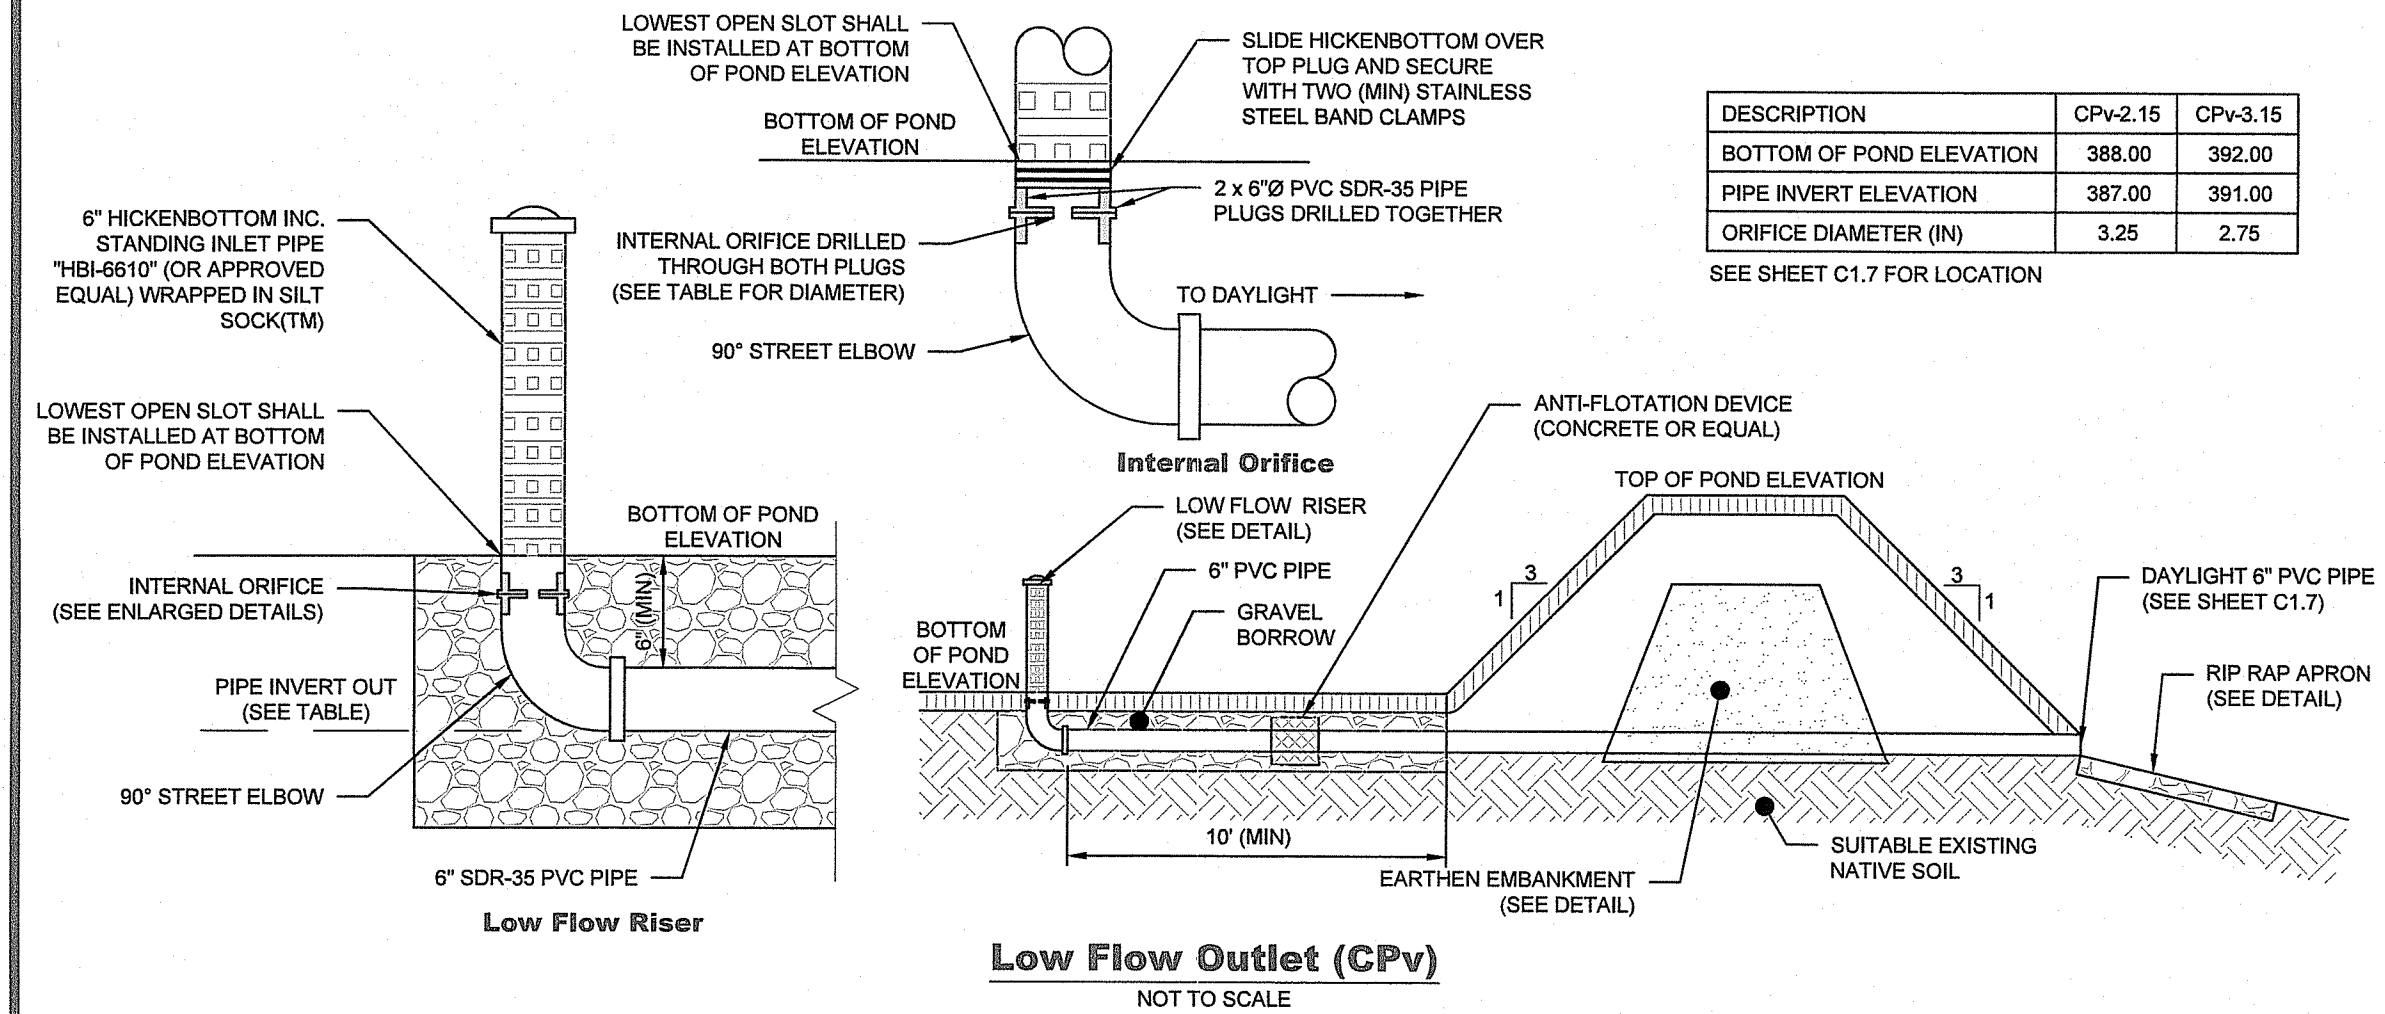

Low Flow Outlet (CPV)
NOT TO SCALE

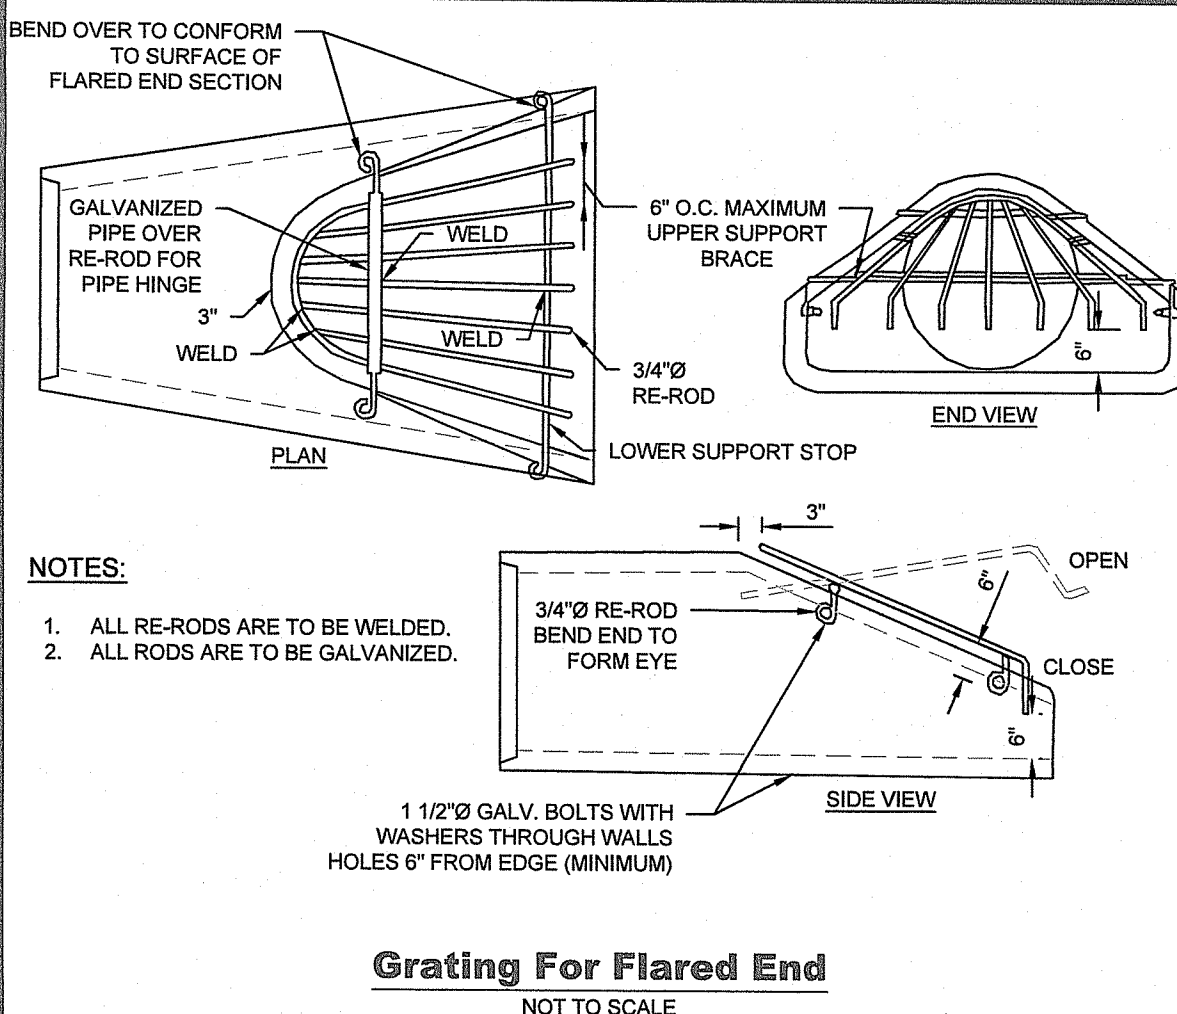

Grating For Flared End
NOT TO SCALE

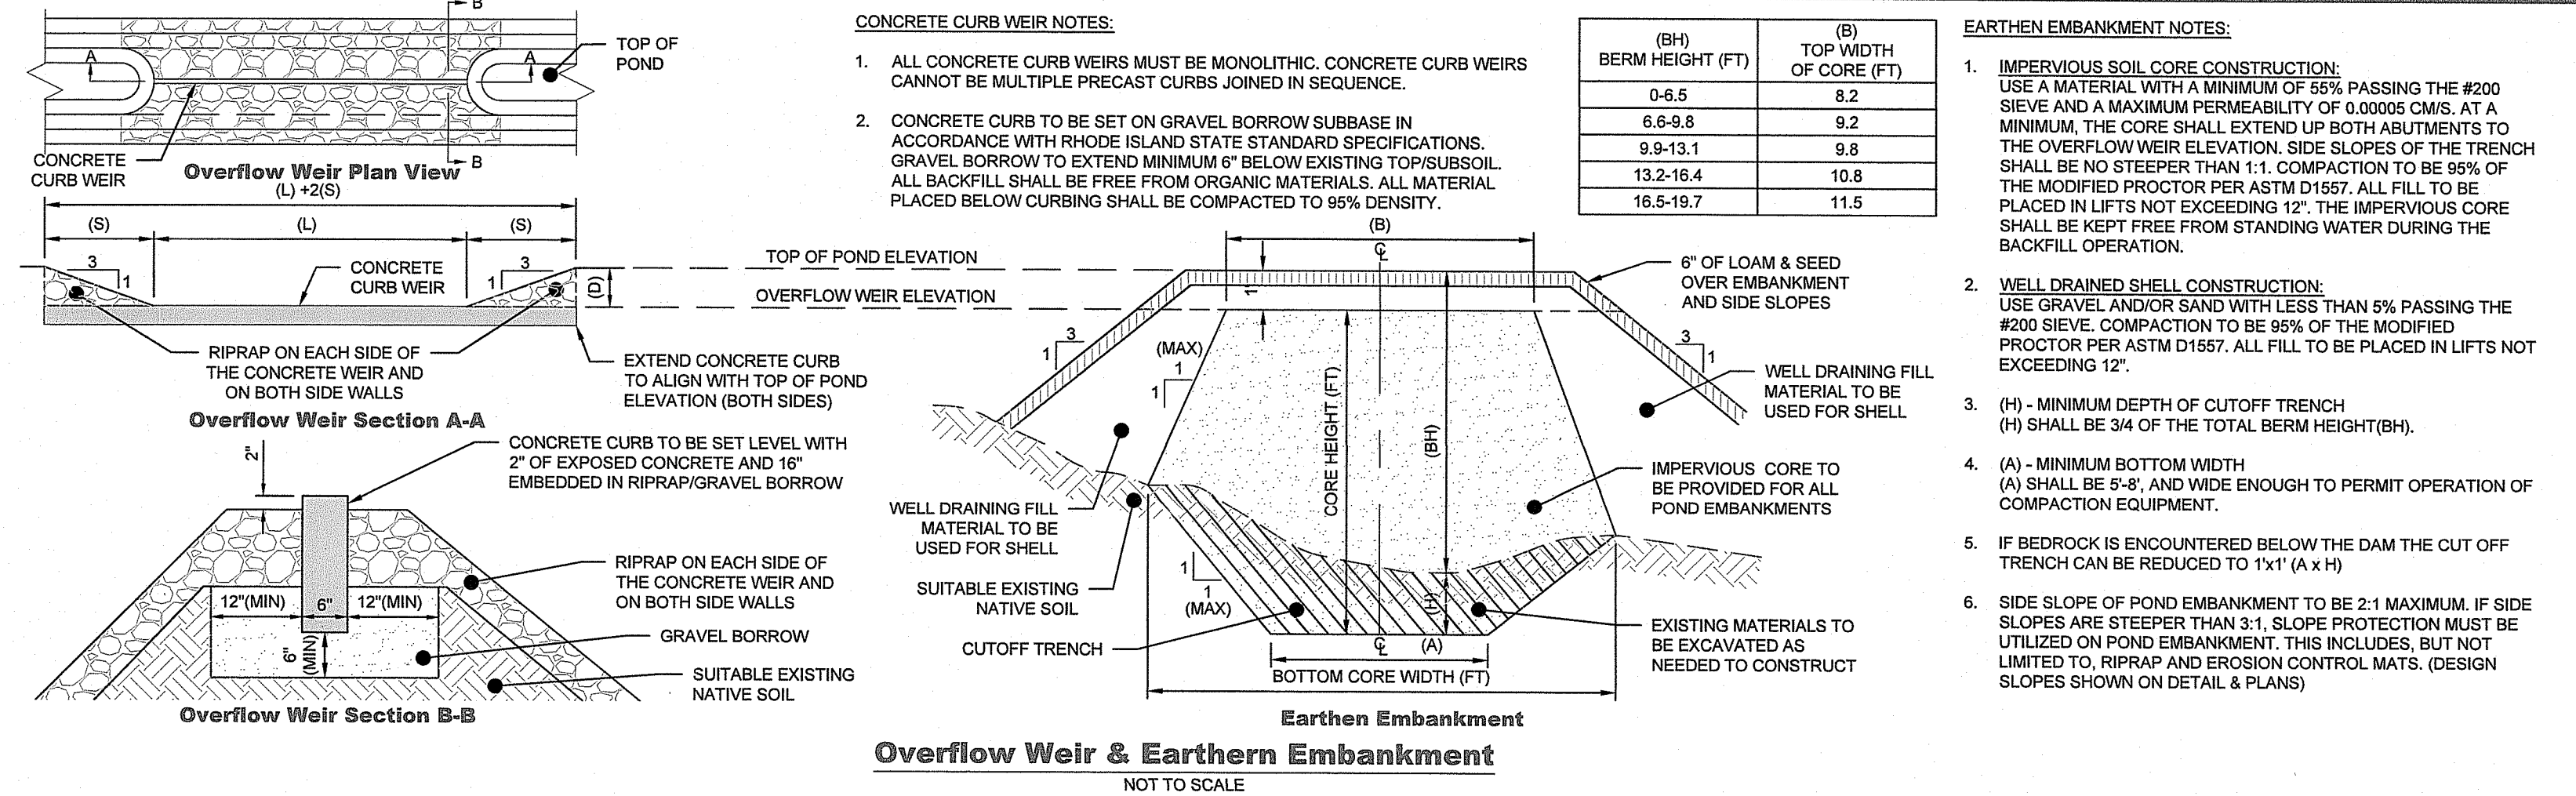

Overflow Weir & Earthen Embankment
NOT TO SCALE

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3760 Quaker Lane
North Kingstown, RI 02852
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GREEN development, LLC

APPLICANT: **GD Glocester White Oak I, LLC**
3760 QUAKER LANE, NORTH KINGSTOWN, RI 02852


PREPARED FOR: **Roger N Phillips, Patricia Etko & Paul Phillips**
74 WHITE OAK LANE, PO BOX 89, NORTH SCITUATE, RI 02857

PREPARED BY: **Green Development, LLC**
3760 QUAKER LANE, NORTH KINGSTOWN, RI 02852

REV	DATE	DESCRIPTION
1	8/8/2018	PRELIMINARY SUBMISSION
2	1/13/2019	PRELIMINARY PLAN SUBMISSION
3	6/7/2019	TOWNSHIP COMMENTS
4	4/23/2019	MASTER PLAN - ZONING SUBMISSION
5	7/29/2019	FRESHWATER WETLANDS COMMENTS
6	8/8/2019	PRELIMINARY SUBMISSION


SHEET TITLE: **Pond Detail Sheet**

PROJECT INFORMATION:
GD Glocester White Oak I
ALTERNATING CURRENT(AO):1.80 MW
74 WHITE OAK LANE, GLOCESTER, RI 02857
ASSESSOR'S PLAT 18 LOT 73

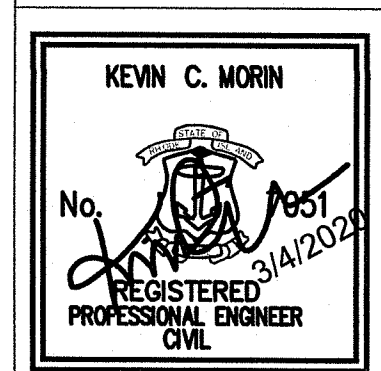


SHEET NO.: **C1.9** OF **10**


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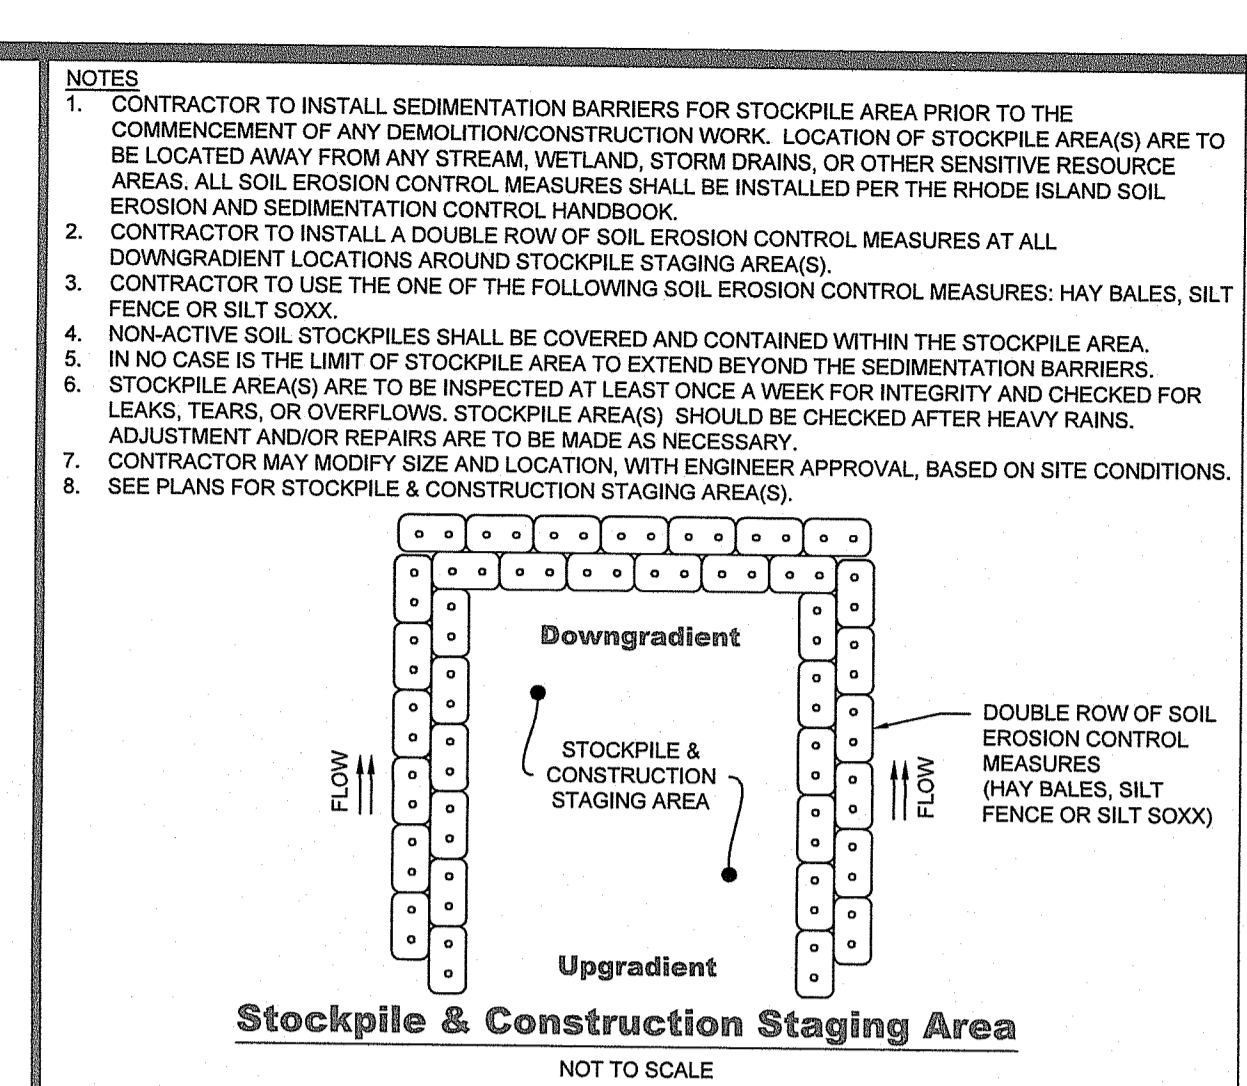
- NOTES:
1. SHALL BE IN ACCORDANCE WITH SECTION 211 OF THE R.I. STANDARD SPECIFICATIONS.
 2. SHALL BE IN ACCORDANCE WITH RHODE ISLAND DEPARTMENT OF TRANSPORTATION R.I. STANDARD DETAIL 9.9.0.
 3. SEE PLANS FOR LOCATION.

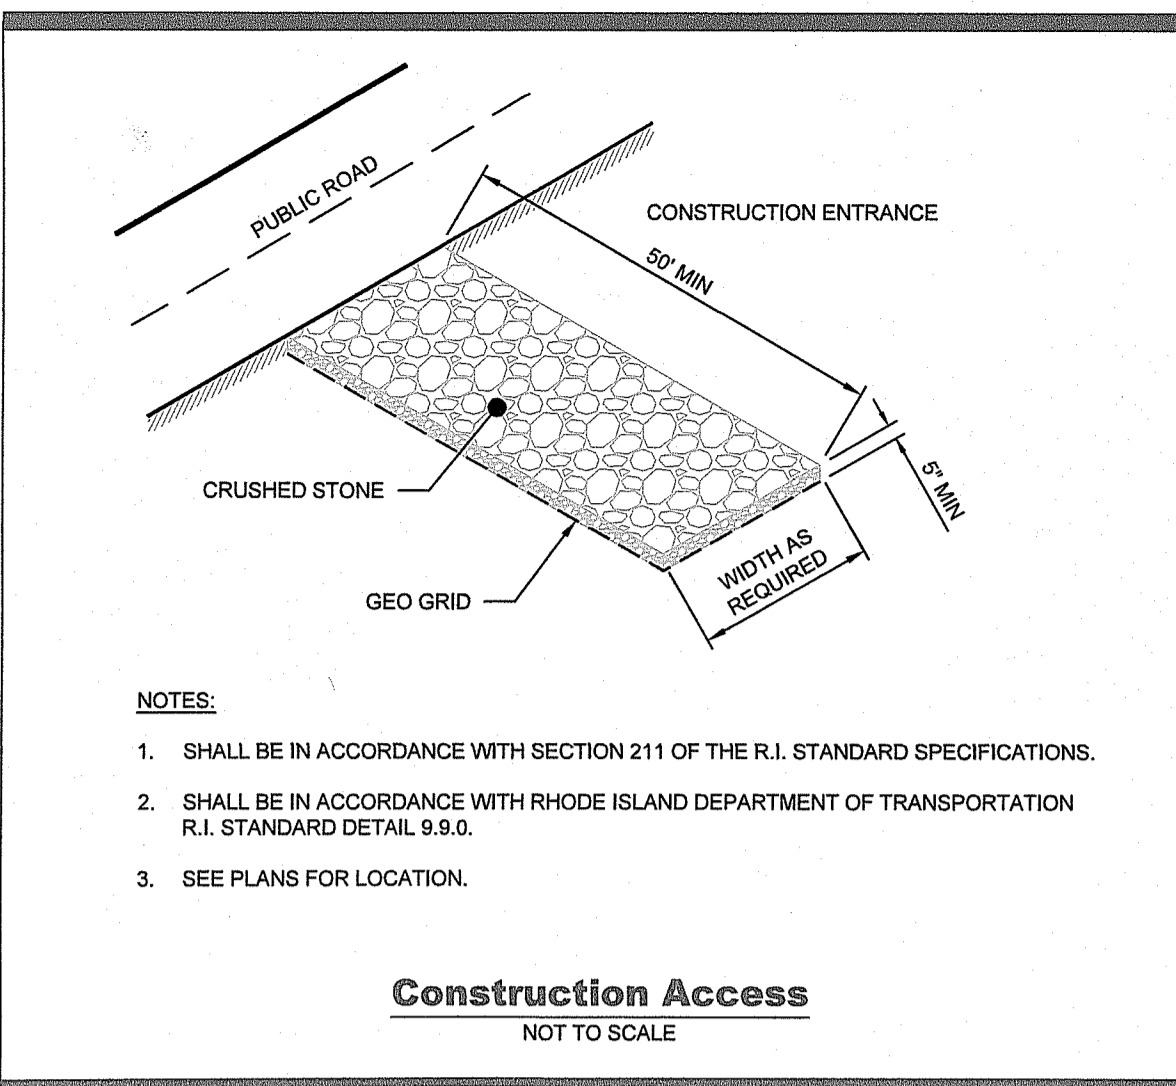

- NOTES:
1. SHALL BE IN ACCORDANCE WITH SECTION 206 OF THE R.I. STANDARD SPECIFICATIONS.
 2. 2"x2"x4'-6" (MAX.) OAK POSTS FOR SILT FENCE SHALL BE LOCATED 8'-0" (MIN.) O.C. IN WETLAND AREAS AND 4'-0" (MAX.) O.C. IN WETLAND RAVINE, GULLY OR DROP-OFF AREAS AS SHOWN ON PLANS.
 3. 1" x 1" x 4'-6" (MIN.) POSTS PERMITTED FOR PRE-FABRICATED SILT FENCE.
 4. SILT FENCE SHALL BE INSTALLED BEFORE ANY GRUBBING OR EARTH EXCAVATION TAKES PLACE.

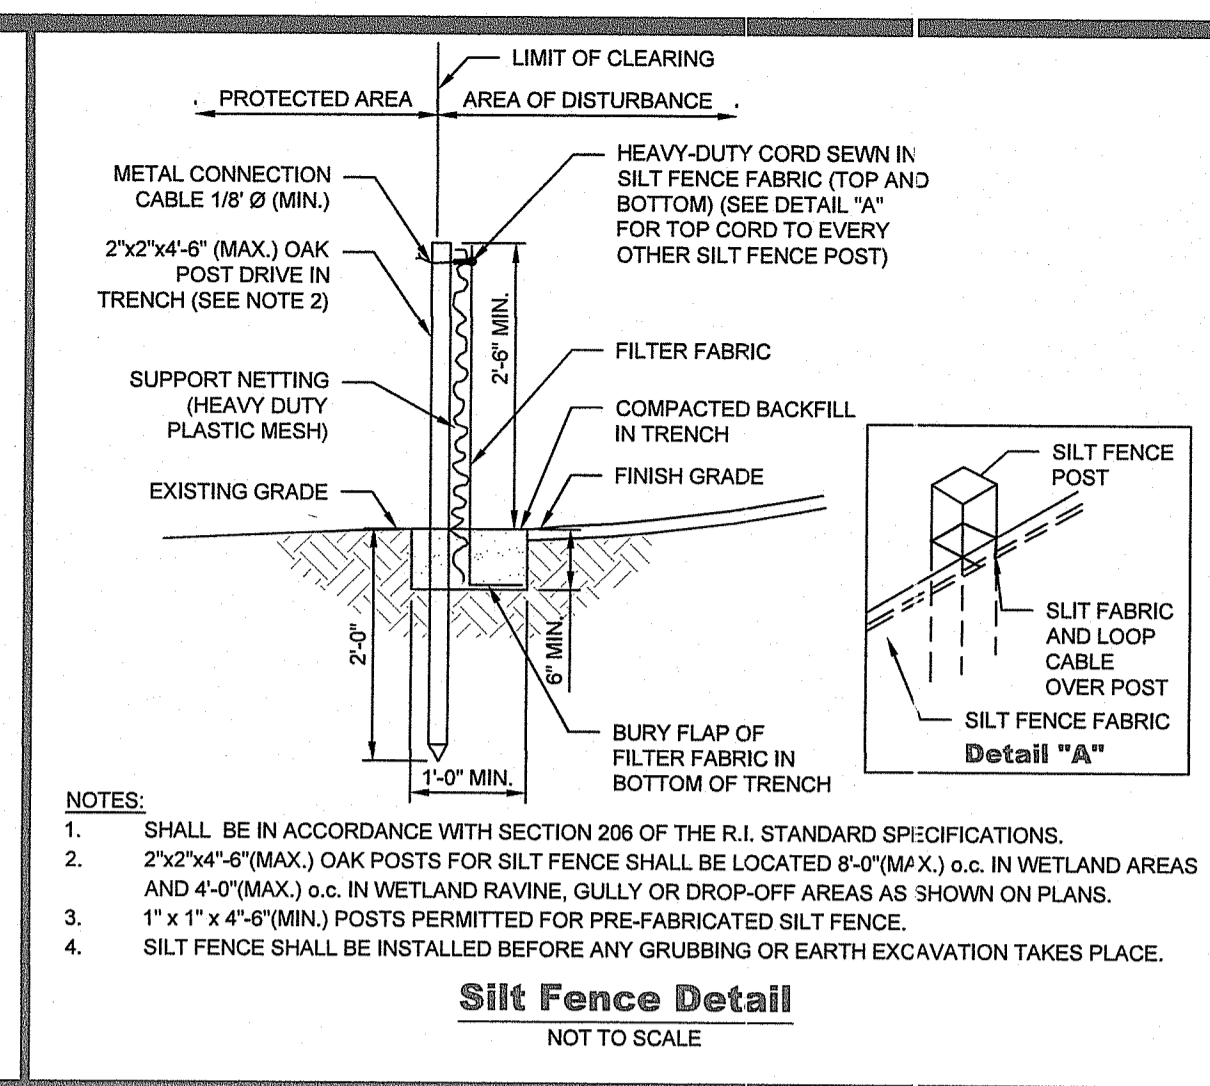

- NOTES:
1. CONCRETE WASHOUT AREA(S) SHALL BE INSTALLED PRIOR TO CONCRETE PLACEMENT ON SITE. THE CONCRETE WASHOUT AREA SHALL BE ENTIRELY SELF-CONTAINED.
 2. THE CONTRACTOR SHALL SUBMIT THE DESIGN, LOCATION AND SIZING OF THE CONCRETE WASHOUT AREA(S) WITH THE PROJECT'S SOIL EROSION AND SEDIMENTATION CONTROL PLAN AND SHALL BE APPROVED BY THE ENGINEER PRIOR TO PROCEEDING WITH ANY CONCRETE WORK.
LOCATION: WASHOUT AREA(S) ARE TO BE LOCATED AWAY FROM ANY STREAM, WETLAND, STORM DRAINS, OR OTHER SENSITIVE RESOURCE AREAS. WASH WATER SHALL NOT BE ALLOWED TO FLOW TO SURFACE WATER. THE FLOOD CONTINGENCY PLAN MUST CONTAIN THE CONCRETE WASHOUT IF THE WASHOUT IS TO BE LOCATED WITHIN THE FLOODPLAIN.
SIZE: THE WASHOUT MUST HAVE SUFFICIENT VOLUME TO CONTAIN ALL LIQUID AND CONCRETE WASTE GENERATED BY WASHOUT OPERATIONS WITH A MINIMUM FREEBOARD OF 12".
 3. SURFACE DISCHARGE IS UNACCEPTABLE. THEREFORE, HAY BALES OR OTHER CONTROL MEASURES, AS APPROVED BY THE ENGINEER, SHOULD BE USED AROUND THE PERIMETER OF THE CONCRETE WASHOUT AREA FOR CONTAINMENT.
 4. SIGNS SHOULD BE PLACED AT THE CONSTRUCTION ENTRANCE, AT THE CONCRETE AREA(S) AND ELSEWHERE AS NECESSARY TO CLEARLY INDICATE THE LOCATION OF THE CONCRETE WASHOUT TO OPERATORS OF CONCRETE TRUCKS AND PUMP TRIGS. WASHOUT AREA(S) SHOULD BE FLAGGED WITH SAFETY FENCING OR OTHER APPROVED METHODS.
 5. WASHOUT AREA(S) ARE TO BE INSPECTED AT LEAST ONCE A WEEK FOR STRUCTURAL INTEGRITY, ADEQUATE HOLDING CAPACITY AND CHECKED FOR LEAKS, TEARS, OR OVERFLOWS. (AS REQUIRED BY THE CONTRACTOR SITE ENVIRONMENTAL INSPECTION REPORT) WASHOUT AREA(S) SHOULD BE CHECKED AFTER HEAVY RAINS. WASHOUT AREA(S) SHALL NOT BE FILLED BEYOND 95% CAPACITY UNLESS A NEW WASHOUT AREA IS CONSTRUCTED.
 6. HARDENED CONCRETE WASTE SHOULD BE REMOVED AND DISPOSED OF WHEN THE WASTE HAS ACCUMULATED TO HALF OF THE CONCRETE WASHOUT'S HEIGHT. THE WASTE CAN BE STORED AT AN UPLAND LOCATION, AS APPROVED BY THE ENGINEER. ALL CONCRETE WASTE SHALL BE DISPOSED OF IN A MANNER CONSISTENT WITH ALL APPLICABLE LAWS, REGULATIONS, AND GUIDELINES.

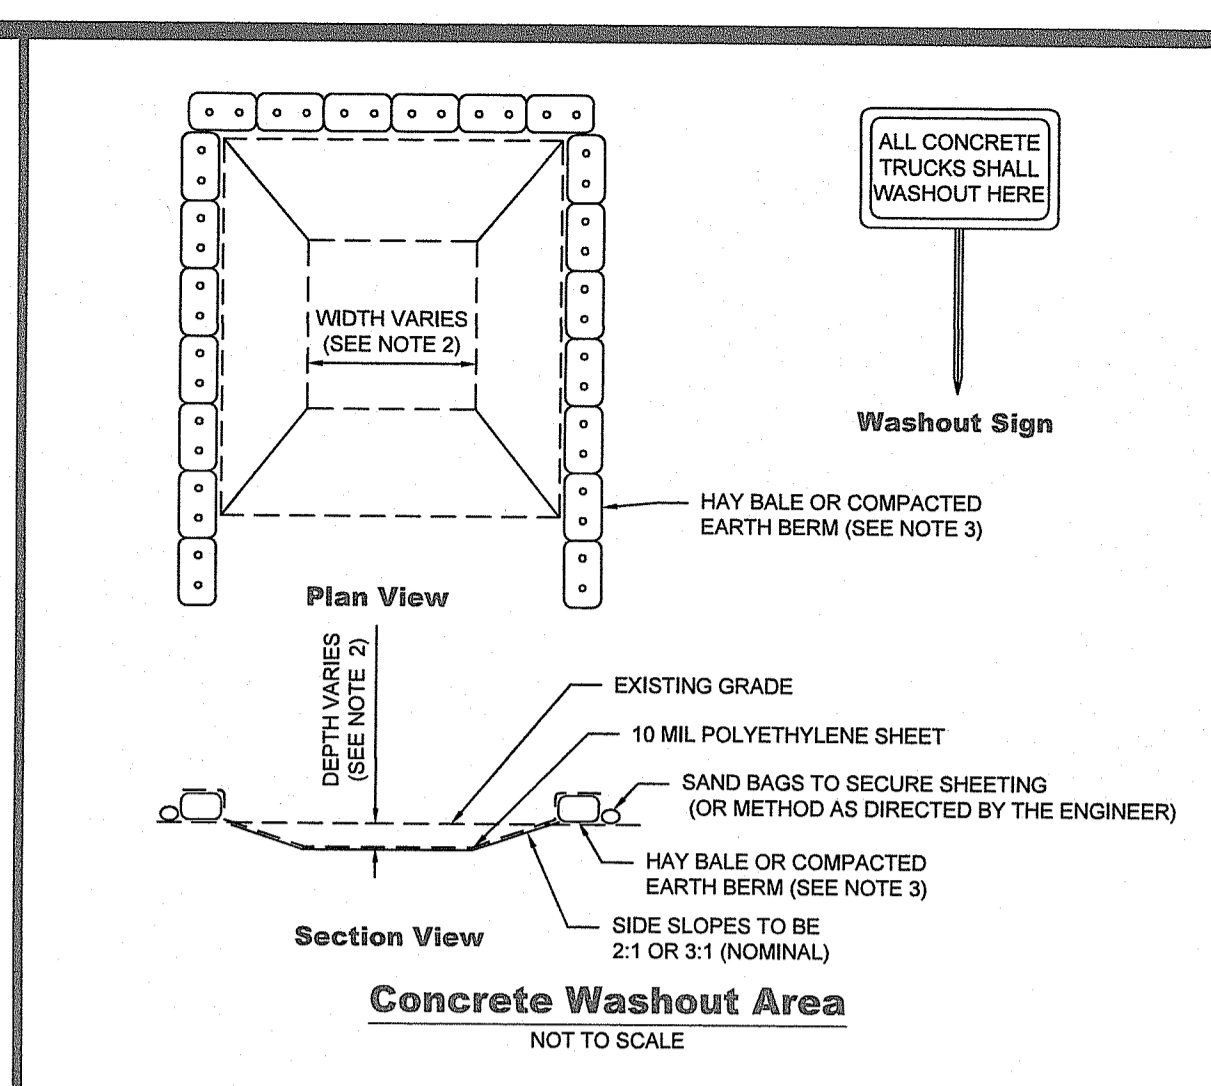

- NOTES:
1. CONTRACTOR TO INSTALL SEDIMENTATION BARRIERS FOR STOCKPILE AREA PRIOR TO THE COMMENCEMENT OF ANY DEMOLITION/CONSTRUCTION WORK. LOCATION OF STOCKPILE AREA(S) ARE TO BE LOCATED AWAY FROM ANY STREAM, WETLAND, STORM DRAINS, OR OTHER SENSITIVE RESOURCE AREAS. ALL SOIL EROSION CONTROL MEASURES SHALL BE INSTALLED PER THE RHODE ISLAND SOIL EROSION AND SEDIMENTATION CONTROL HANDBOOK.
 2. CONTRACTOR TO INSTALL A DOUBLE ROW OF SOIL EROSION CONTROL MEASURES AT ALL DOWNGRADIENT LOCATIONS AROUND STOCKPILE STAGING AREA(S).
 3. CONTRACTOR TO USE ONE OF THE FOLLOWING SOIL EROSION CONTROL MEASURES: HAY BALES, SILT FENCE OR SILT SOCK.
 4. NON-ACTIVE SOIL STOCKPILES SHALL BE COVERED AND CONTAINED WITHIN THE STOCKPILE AREA.
 5. IN NO CASE IS THE LIMIT OF STOCKPILE AREA TO EXTEND BEYOND THE SEDIMENTATION BARRIERS.
 6. STOCKPILE AREA(S) ARE TO BE INSPECTED AT LEAST ONCE A WEEK FOR INTEGRITY AND CHECKED FOR LEAKS, TEARS, OR OVERFLOWS. STOCKPILE AREA(S) SHOULD BE CHECKED AFTER HEAVY RAINS. ADJUSTMENT AND/OR REPAIRS ARE TO BE MADE AS NECESSARY.
 7. CONTRACTOR MAY MODIFY SIZE AND LOCATION, WITH ENGINEER APPROVAL, BASED ON SITE CONDITIONS.
 8. SEE PLANS FOR STOCKPILE & CONSTRUCTION STAGING AREA(S).







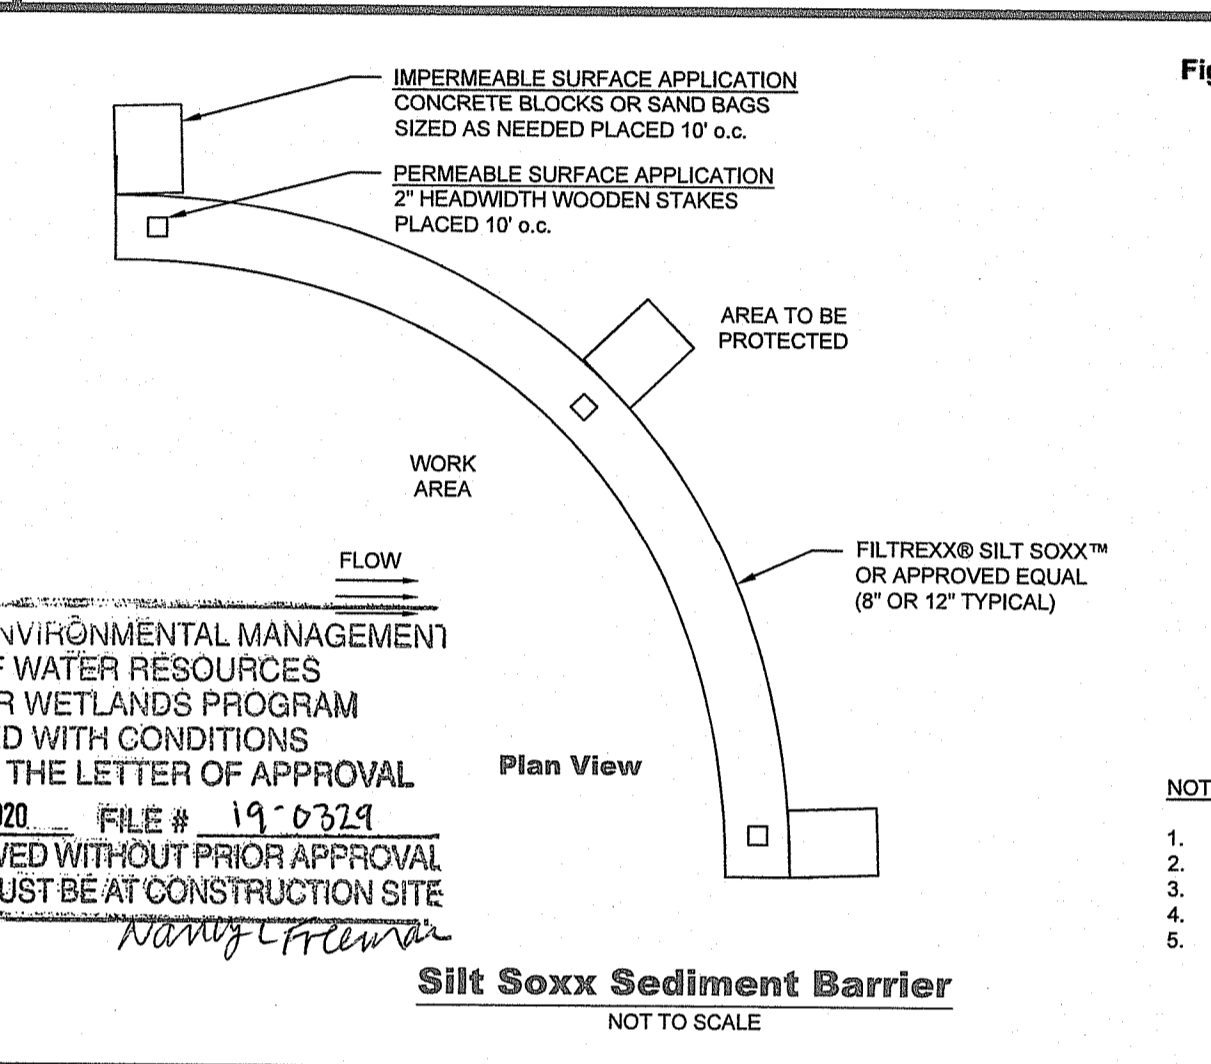


Figure 2: Recommended Spacing and Diameter Requirements for Compost Filter Socks





Slope %	Diameter of compost filter sock required			
	8-inch (200-mm)	12-inch (300-mm)	18-inch (450-mm)	24-inch (600-mm)
2 (or less)	300 (90)	375 (110)	500 (150)	650 (200)
5	200 (60)	250 (75)	375 (85)	500 (150)
10	100 (30)	125 (35)	150 (45)	200 (60)
15	70 (20)	85 (25)	100 (30)	100 (30)
20	60 (15)	65 (20)	70 (20)	100 (30)
25	40 (12)	50 (15)	55 (15)	100 (30)
30	30 (9)	40 (12)	45 (13)	55 (15)
35	30 (9)	40 (12)	45 (13)	55 (15)
40	30 (9)	40 (12)	45 (13)	50 (15)
45	20 (6)	25 (8)	30 (9)	40 (12)
50	20 (6)	25 (8)	30 (9)	35 (10)

NOTES:


1. CONTRACTOR TO USE FILTREXX® SILT SOCK™ OR APPROVED EQUAL.
2. ALL MATERIAL TO MEET FILTREXX® SPECIFICATIONS.
3. SILT SOCK™ FILL TO MEET APPLICATION REQUIREMENTS.
4. FILTER MEDIA TO BE DISPERSED ON SITE, AS DETERMINED BY ENGINEER.
5. SEE PLANS FOR LOCATION AND SURFACE APPLICATION TYPE.

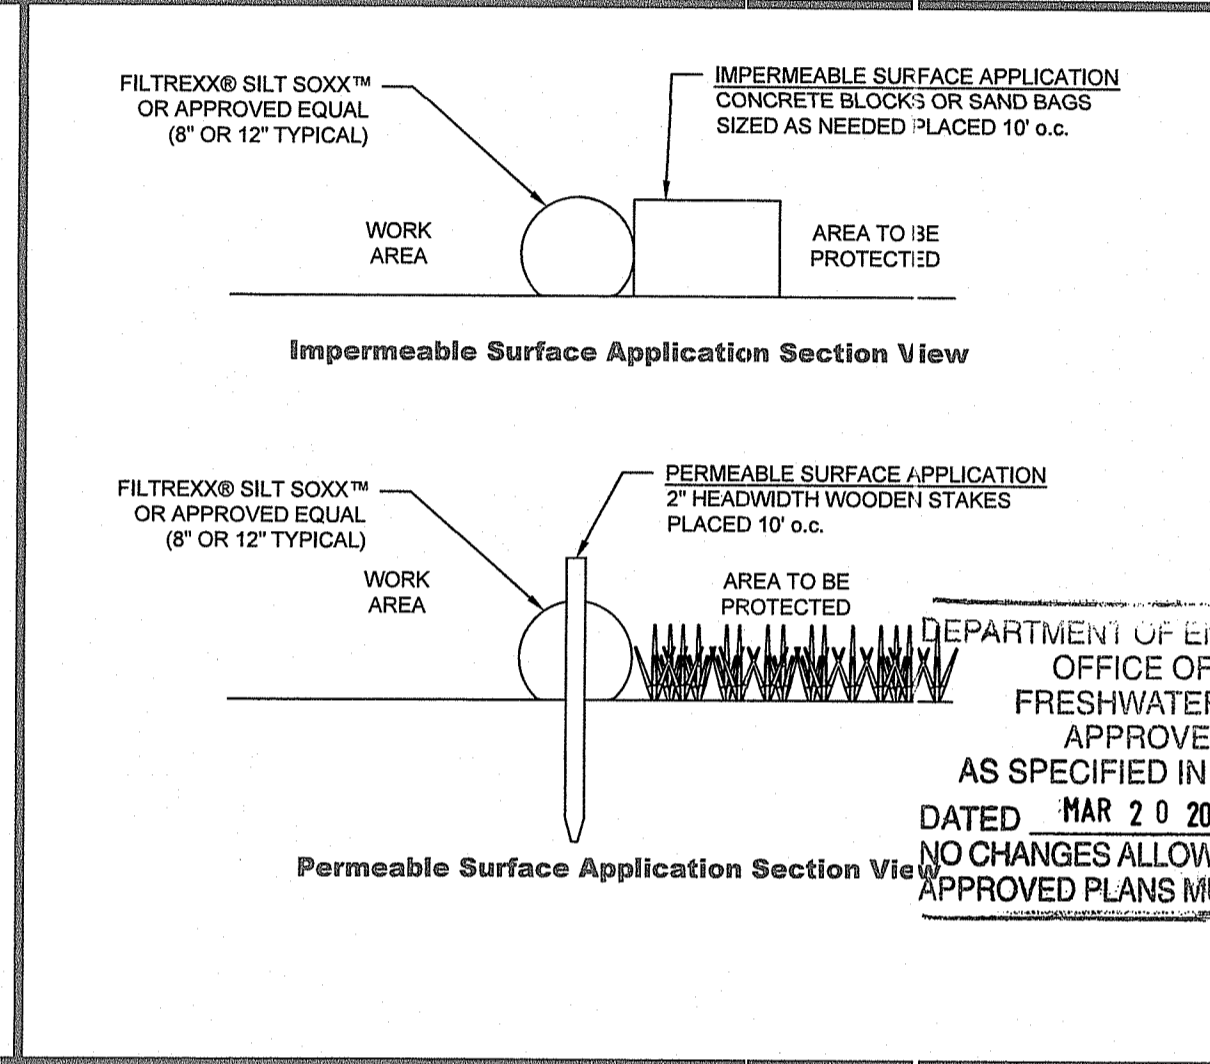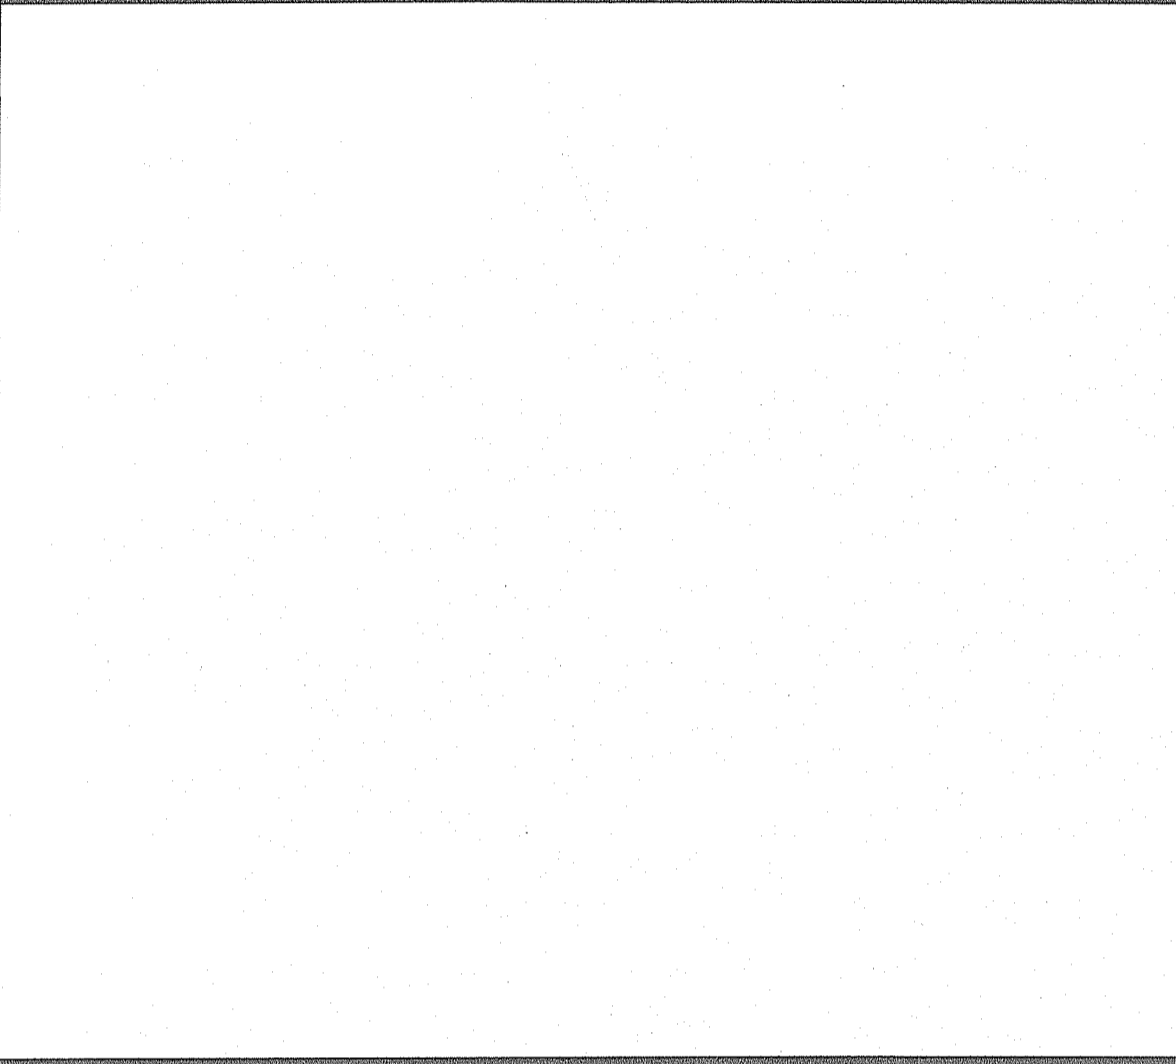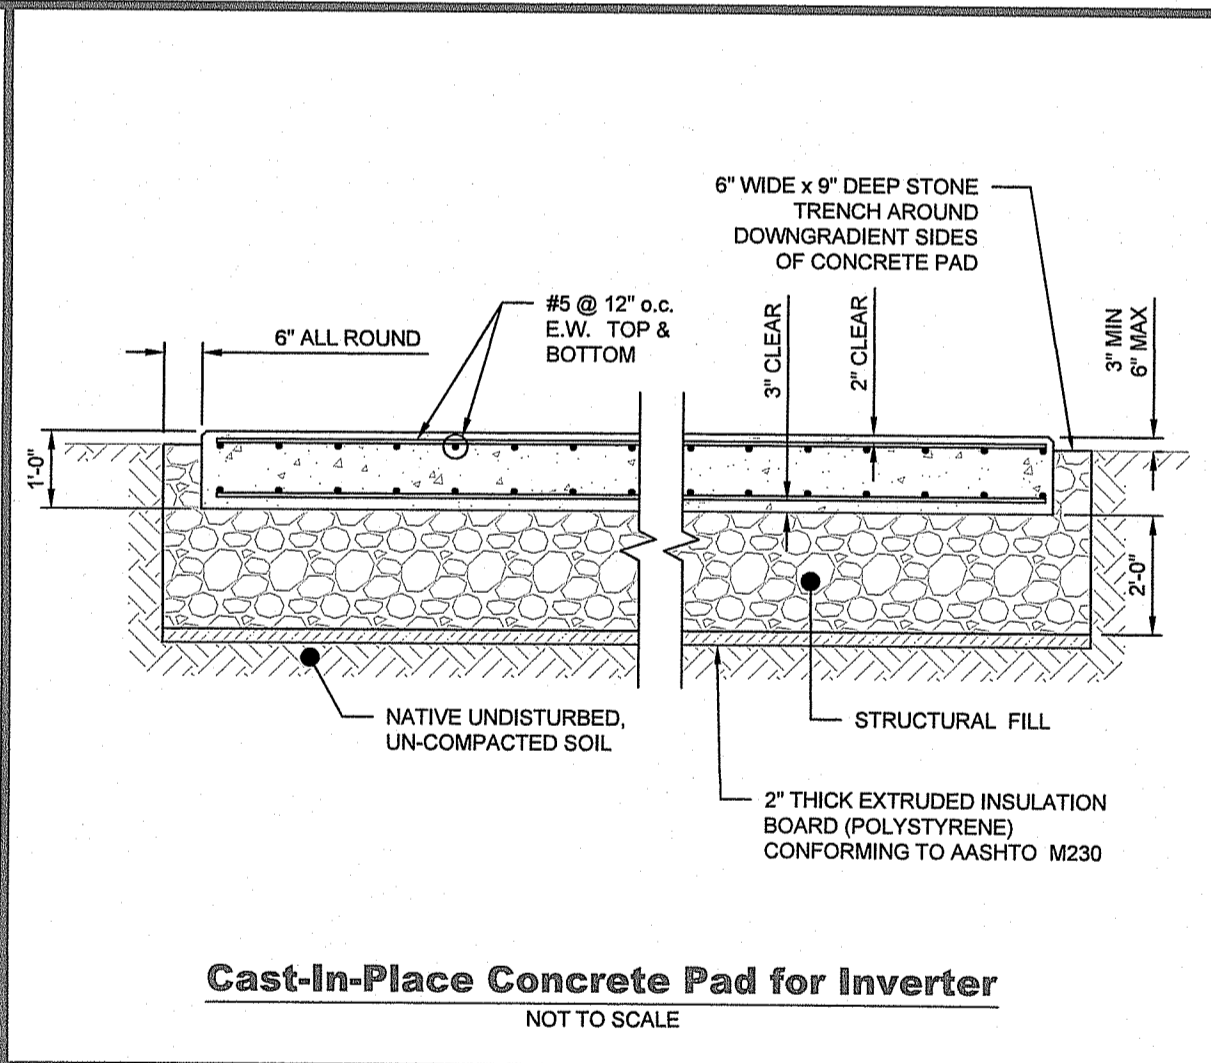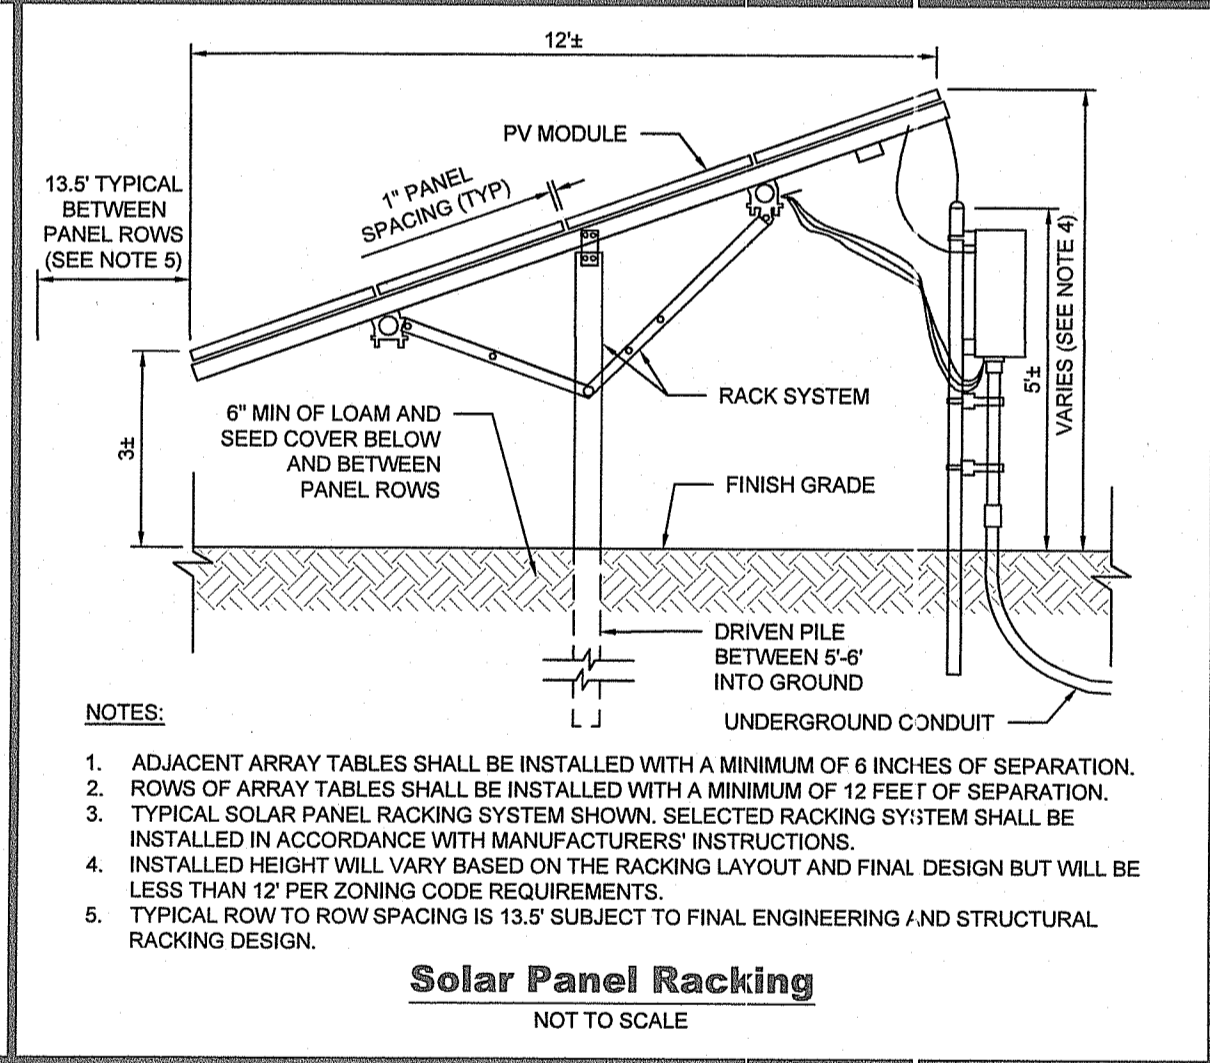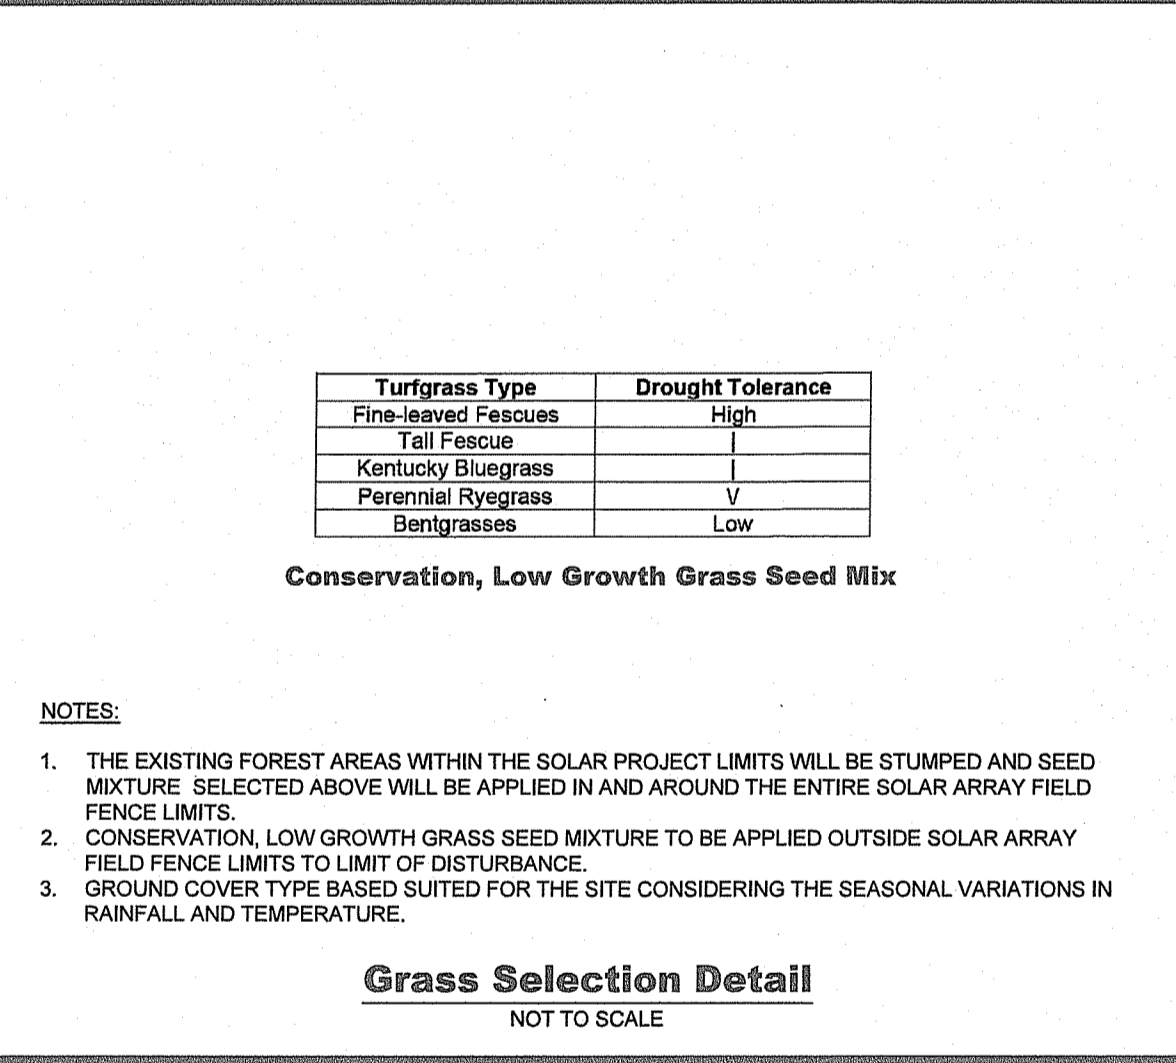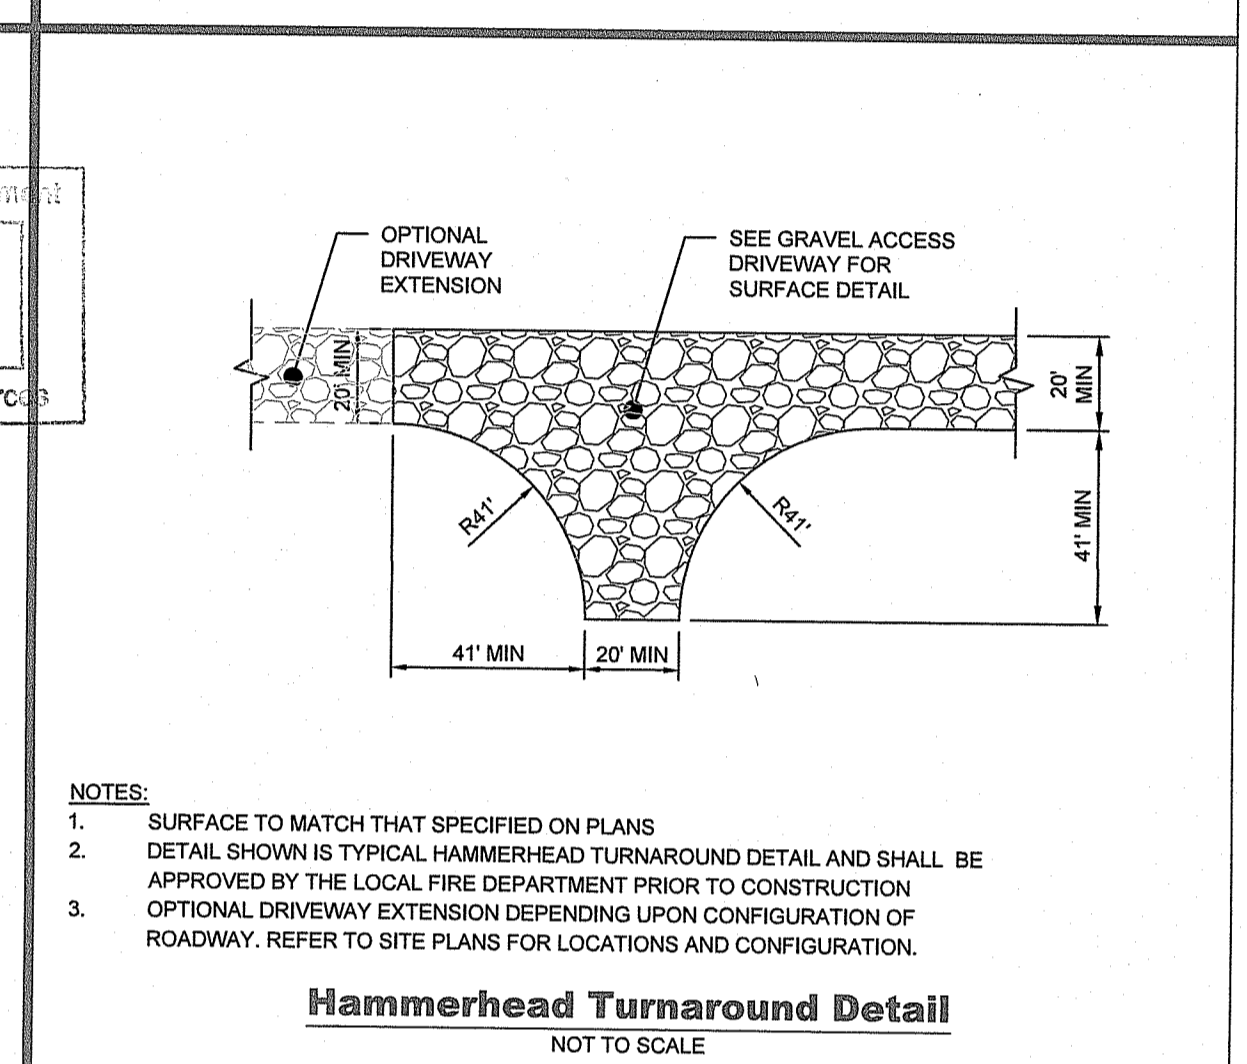

- NOTES:
1. ALL CONCRETE WORK SHALL CONFORM TO ACI 301 "SPECIFICATIONS FOR STRUCTURAL CONCRETE BUILDINGS".
 2. ALL REINFORCING STEEL SHALL CONFORM TO ASTM A615 GRADE 60 AND BE DETAILLED IN ACCORDANCE WITH ACI 315 "MANUAL OF STANDARD PRACTICE FOR DETAILING REINFORCED CONCRETE STRUCTURES".
 3. REBAR SHALL HAVE A MINIMUM CONCRETE COVER AS FOLLOWS:
• CONCRETE DEPOSITED AGAINST GROUND.....3 IN.
• CONCRETE EXPOSED TO WEATHER OR CONTACT WITH GROUND:
FOR BARS #5 AND LARGER.....2 IN.
FOR BARS SMALLER THAN #5.....1 1/2 IN.
• CONCRETE NOT EXPOSED TO THE WEATHER OR THE GROUND SLABS AND WALLS.....3/4 IN.
 4. ALL REINFORCED BARS SHALL BE CONTINUOUS AND LAPPED A MINIMUM OF 48 BAR DIAMETERS AT ALL SPLICES, CORNERS AND INTERSECTIONS UNLESS NOTED OTHERWISE.
 5. ALL REINFORCEMENT SHALL BE SECURELY TIED IN ITS PROPOSED LOCATIONS PRIOR TO AND DURING PLACEMENT OF CONCRETE USING APPROVED CHAIRS, SPACERS AND THE WIRE AS REQUIRED. NO BARS SHALL BE CUT OR OMITTED IN THE FIELD WITH OUT THE APPROVAL OF THE ENGINEER.
 6. CONCRETE PROTECTION FOR REINFORCEMENT SHALL, IN ALL CASES, BE AT LEAST EQUAL TO THE DIAMETER OF THE BAR EXCEPT FOR CONCRETE.
 7. CONCRETE SHALL BE CAST-IN-PLACE, NORMAL WEIGHT CONCRETE AND SHALL DEVELOP A COMPRESSIVE STRENGTH OF 4,000 PSI IN 28 DAYS. CONCRETE SHALL HAVE A MAXIMUM AGGREGATE SIZE OF 3/4 INCH, MINIMUM CEMENT CONTENT OF 650 LBS/CY, VD, AND A MAXIMUM SLUMP OF 4 INCHES.
 8. ALL EXPOSED EDGES OF CONCRETE SHALL HAVE A 3/4 INCH CHAMFER UNLESS NOTED.
 9. ALL CONCRETE EXPOSED TO THE WEATHER SHALL BE AIR-ENTRAINED.
 10. SIZES AND LOCATIONS OF ALL REQUIRED EMBEDDED ITEMS FOR ALL TRADES SUCH AS ANCHOR BOLTS, PIPING SLEEVES HOLD DOWN ANCHORS, ETC. SHALL BE COORDINATED BY THE CONTRACTOR WITH OTHER TRADES.

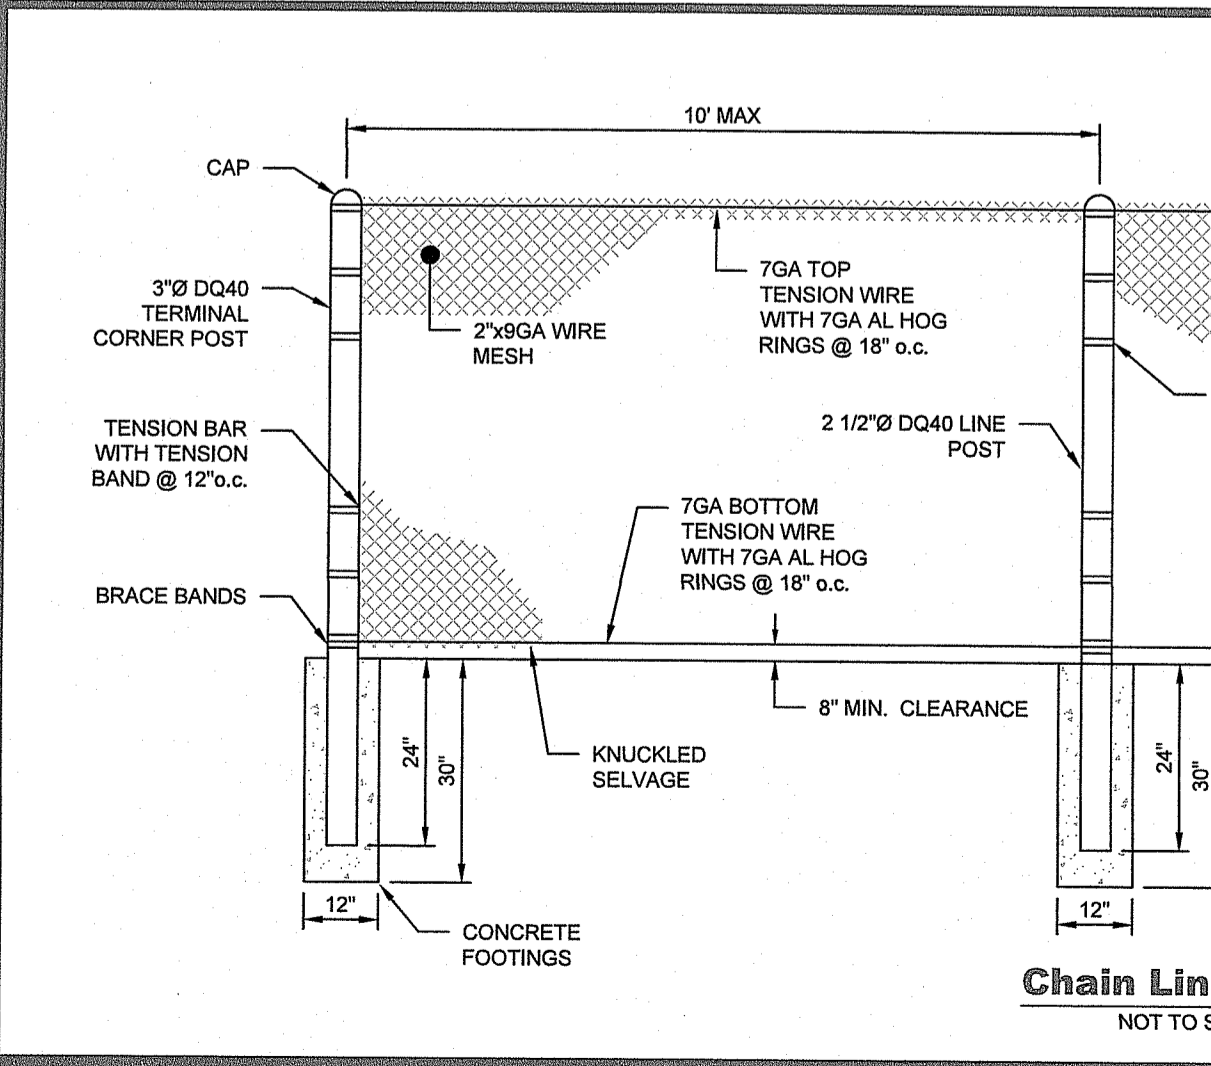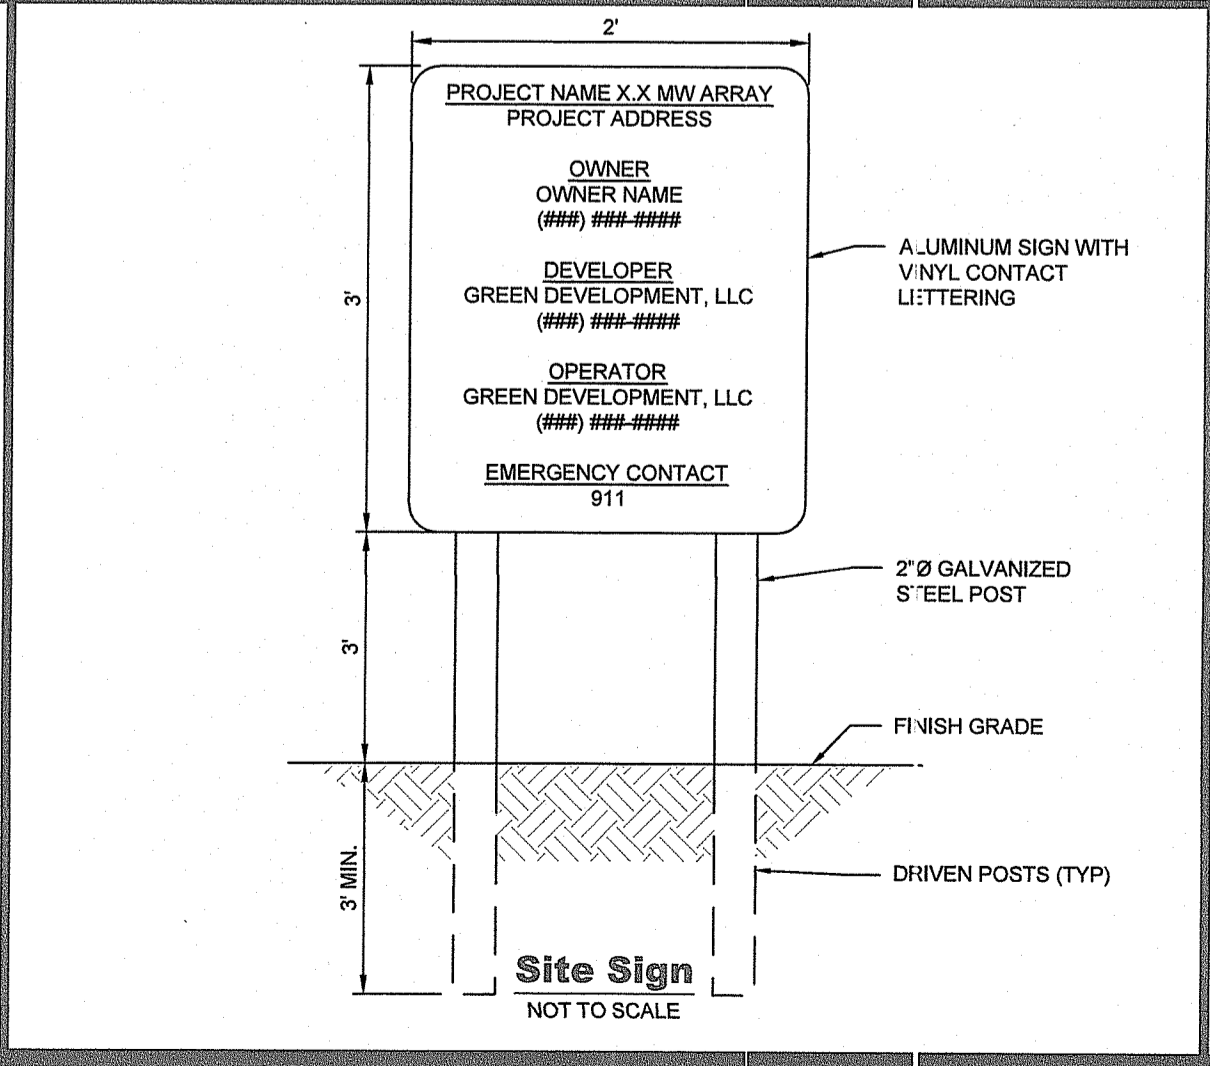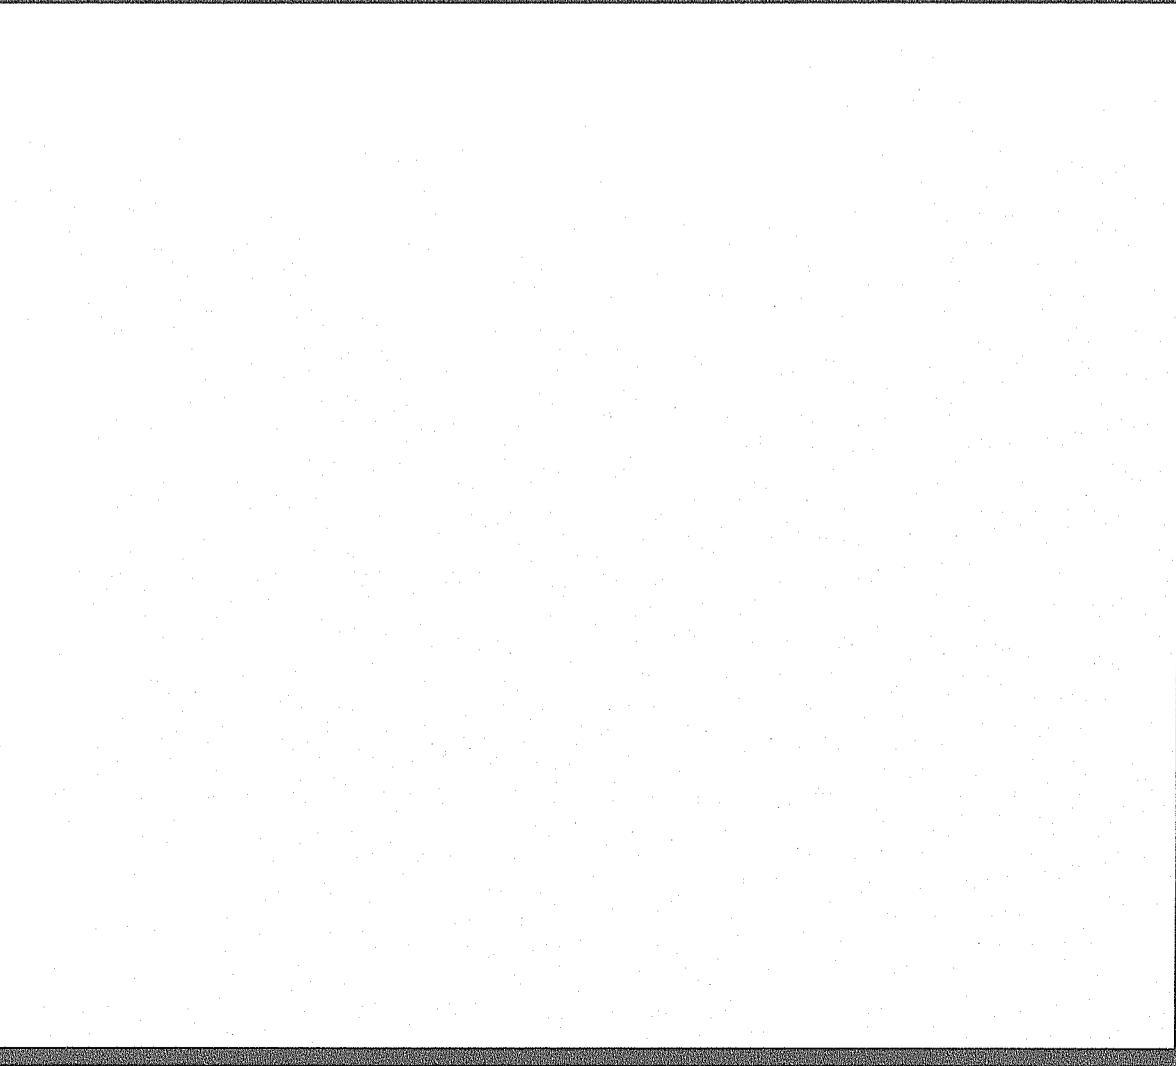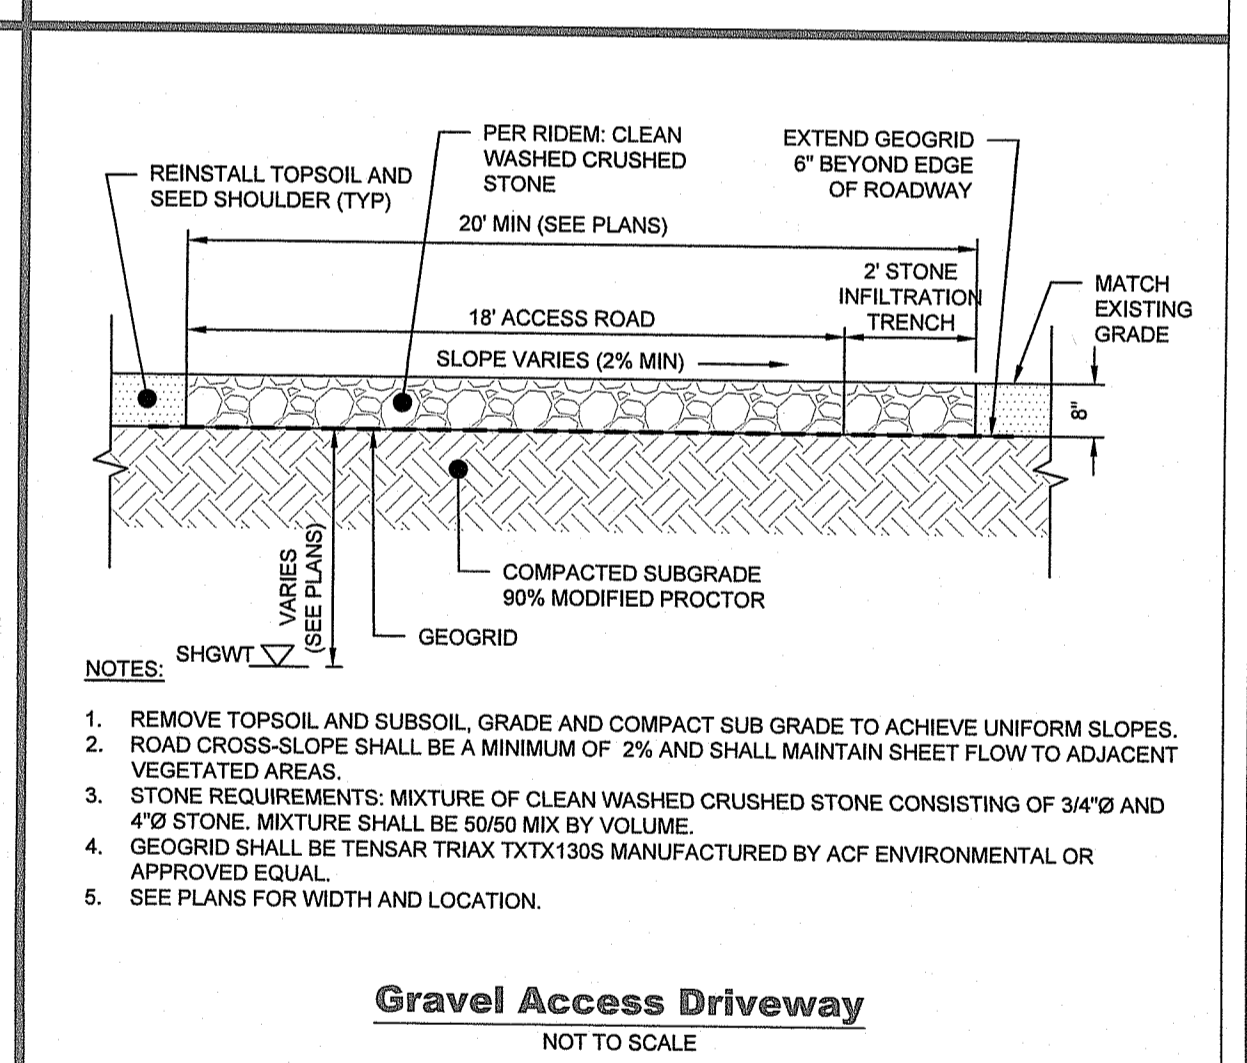

- NOTES:
1. SHALL BE IN ACCORDANCE WITH SECTION 903 OF THE RI STANDARD SPECIFICATIONS.
 2. ALL MATERIALS ARE GALVANIZED.
 3. GATE POST 4"x2".
 4. TERMINAL POSTS 3"x2".
 5. GATE FRAME 2.5"x2".
 6. 7GA TOP AND BOTTOM TENSION WIRE TO MATCH FABRIC ATTACHED BY 7GA HOG RINGS WITH STEEL CORE.
 7. TENSION BARS WITH TENSION BANDS @ 12" o.c.
 8. DOME CAPS FOR POST ENDS.
 9. 9GA TIE WIRES WITH STEEL CORE ON LINE POSTS.
 10. 3" BRACE BANDS ON TERMINAL CORNER POSTS.
 11. GALVANIZED 2" WIRE MESH WITH 9GA STEEL CORE.
 12. CONTRACTOR TO PROVIDE A 6" MINIMUM OF GROUND CLEARANCE BELOW FENCE TO ALLOW FOR SMALL WILDLIFE PASSAGE.
 13. SEE PLANS FOR LOCATION.

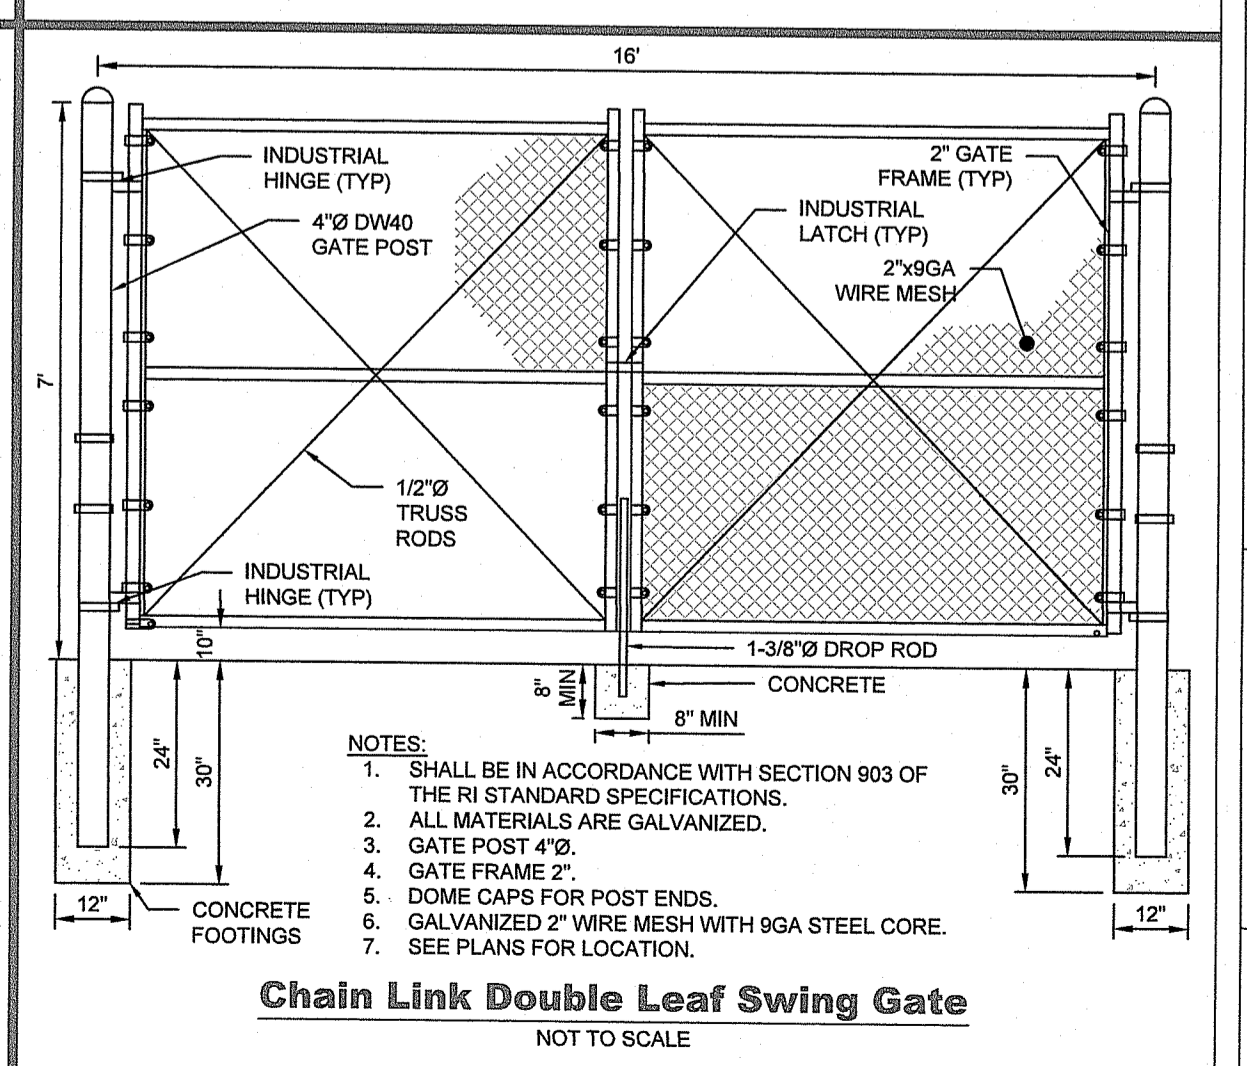

3760 Quaker Lane, North Kingstown, RI 02852
www.green-ti.com

GREEN development, LLC

APPLICANT: **GD Glocester White Oak I, LLC**
3760 QUAKER LANE, NORTH KINGSTOWN, RI 02852

PREPARED FOR: **Roger N Phillips, Patricia Etals & Paul Phillips**
74 WHITE OAK LANE, PO BOX 89, NORTH SCITUATE, RI 02857

PREPARED BY: **Green Development, LLC**
3760 QUAKER LANE, NORTH KINGSTOWN, RI 02852

DATE: MAR 6 2020
Office of Water Resources

REVISIONS:

No.	DATE	REVISION
1	1/7/2018	PRE APPLICATION SUBMISSION
2	1/17/2018	PRE APPLICATION SUBMISSION
3	2/2/2018	PRE APPLICATION SUBMISSION
4	2/2/2018	PRE APPLICATION SUBMISSION
5	2/2/2018	PRE APPLICATION SUBMISSION
6	3/6/2020	RIBA RESUBMISSION
7	1/20/2020	FIRE DEPARTMENT COMMENTS
8	1/15/2019	PRELIMINARY PLAN SUBMISSION
9	8/7/2018	TOWN COMMENTS
10	8/2/2018	REGISTER PLAN - ZONING SUBMISSION
11	6/6/2018	PRE APPLICATION SUBMISSION
12	6/6/2018	PRE APPLICATION SUBMISSION

SHEET TITLE: **Detail Sheet**

PROJECT INFORMATION:
GD Glocester White Oak I
ALTERNATING CURRENT (AC): 150 MW
74 WHITE OAK LANE, GLOCESTER, RI 02857
ASSESSOR'S PLAT 18 LOT 73

DATE: 3/4/2020

SHEET NO.: **C1.10** OF 10