OWNER:

BRISA BERNON MILLS, LP. 119 FRONT STREET, #401 WOONSOCKET, RI 02895

APPLICANT:



CIVIL ENGINEER:



PARE CORPORATION
ENGINEERS - SCIENTISTS - PLANNERS
8 BLACKSTONE VALLEY PLACE
LINCOLN, RI 02865
401-334-4100

ARCHITECT:



111 CHESTNUT STREET PROVIDENCE, RI 02903

LANDSCAPE ARCHITECT:



422 FARNUM PIKE SMITHFIELD, RI 02917

ATTORNEY:




2 WILLIAMS STREET PROVIDENCE, RI 02903

HISTORIC ADVISOR:



SURVEYOR 1:

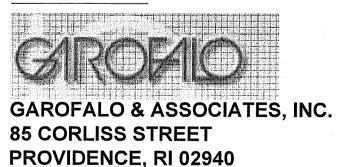

SURVEYOR 2:

DiPrete Engineering

2 STAFFORD COURT CRANSTON, RI 02920

Bernon Mills Redevelopment

MAP D3, LOTS 15-15 & 15-61 MAP D4, LOT 15-221 115 & 119 Front Street Woonsocket, Rhode Island



Scale : N.T.S.

INDEX OF DRAWINGS

SHEET No.	DRAWING No.	DESCRIPTION
1	-	COVER SHEET
2	- -	EXISTING CONDITIONS SURVEY
3	C0.1	SUBDIVISION PLAN
4	C1.1	NOTES & LEGEND
5	C2.1	EROSION & SEDIMENT CONTROL PLAN
6	C3.1	DEMOLITION PLAN
7	C4.1	GENERAL PLAN
8	C5.1	GRADING PLAN
9	C6.1	DRAINAGE & UTILITY PLAN
10 - 16	C7.1 - C7.7	DETAILS
17	L1.0	LANDSCAPE PLAN
18	L1.1	LANDSCAPE DETAILS

DEC 2 0 2021
Office of Water Resources

RIDEM SUBMISSION DECEMBER 10, 2021 OFFICE OF WATER RESOURCES
FRESHWATER WETLANDS PROGRAM

APPROVED WITH CONDITIONS AS
SPECIFIED IN THE LETTER OF APPROVAL


DATED: 11 2022 FILE #: 21-0330


NO CHANGES ALLOWED WITHOUT PRIOR APPROVAL
APPROVED PLANS MUST BE AT CONSTRUCTION SITE

RI DEPARTMENT OF ENVIRONMENTAL MANAGEMENT OFFICE OF WATER RESOURCES FRESHWATER WETLANDS PROGRAM

NOTE PER **DEM**:

Kindly be advised that this Permit is not equivalent to a verification of the type or extent of freshwater wetlands on site

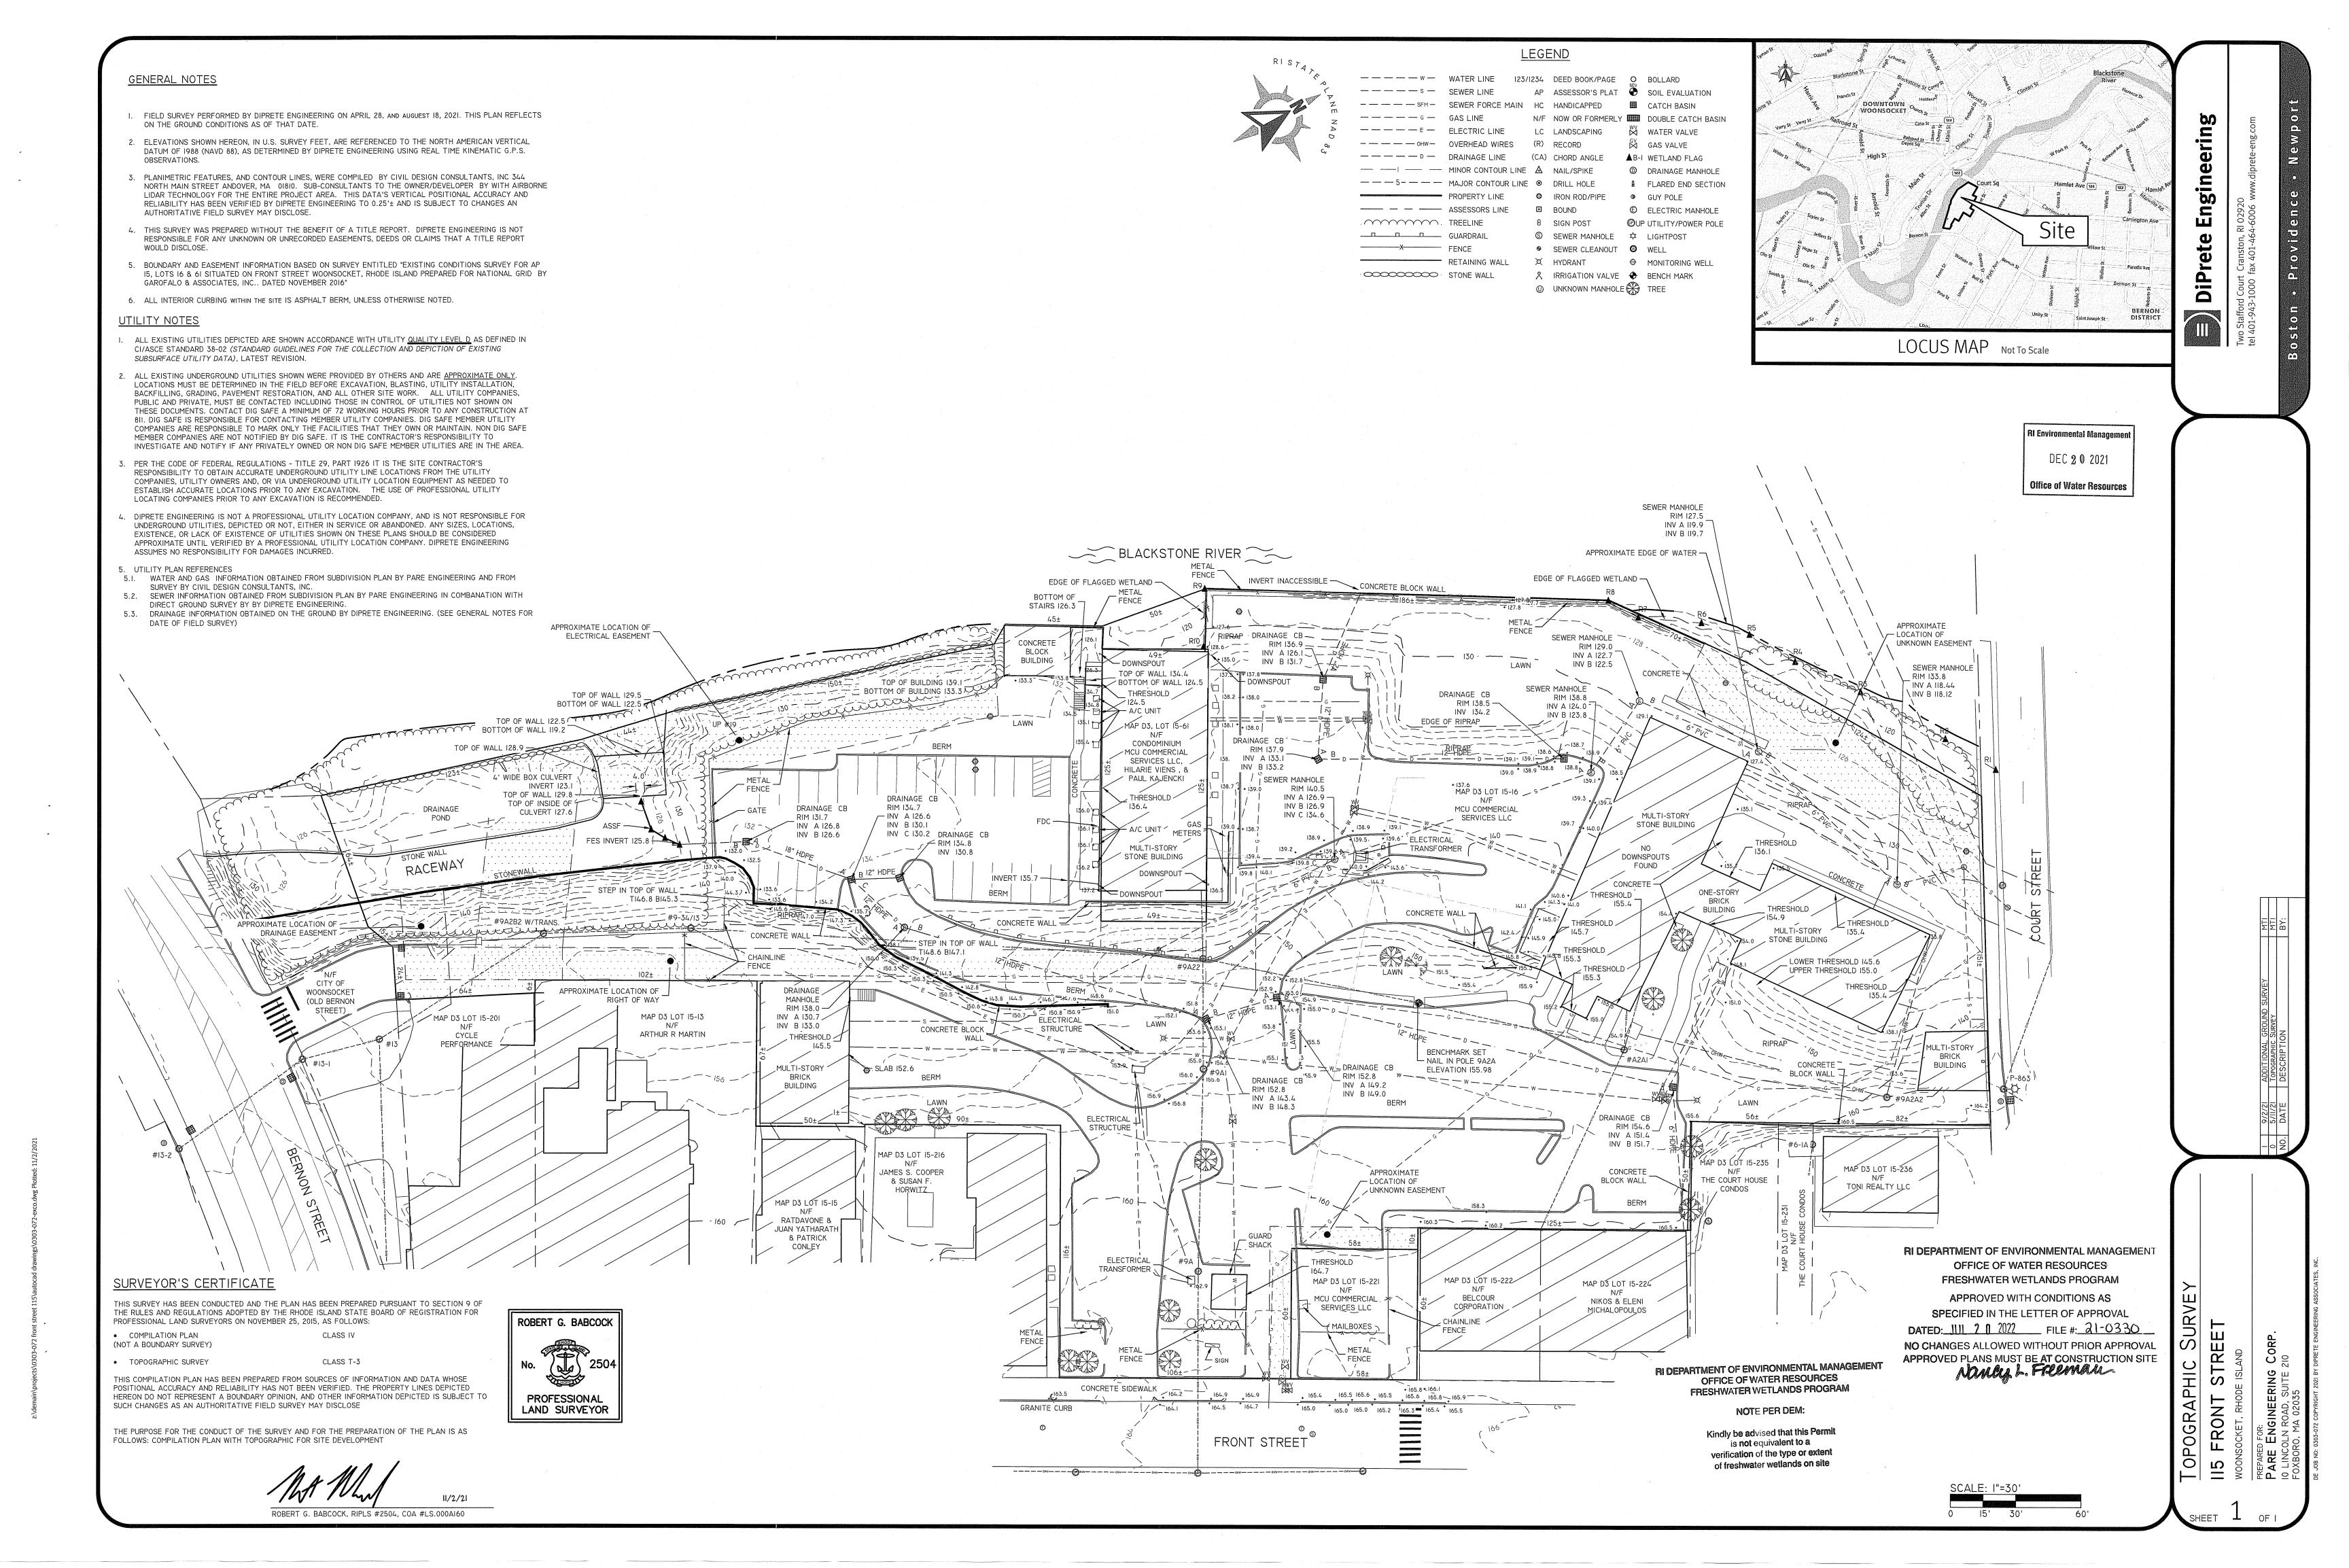

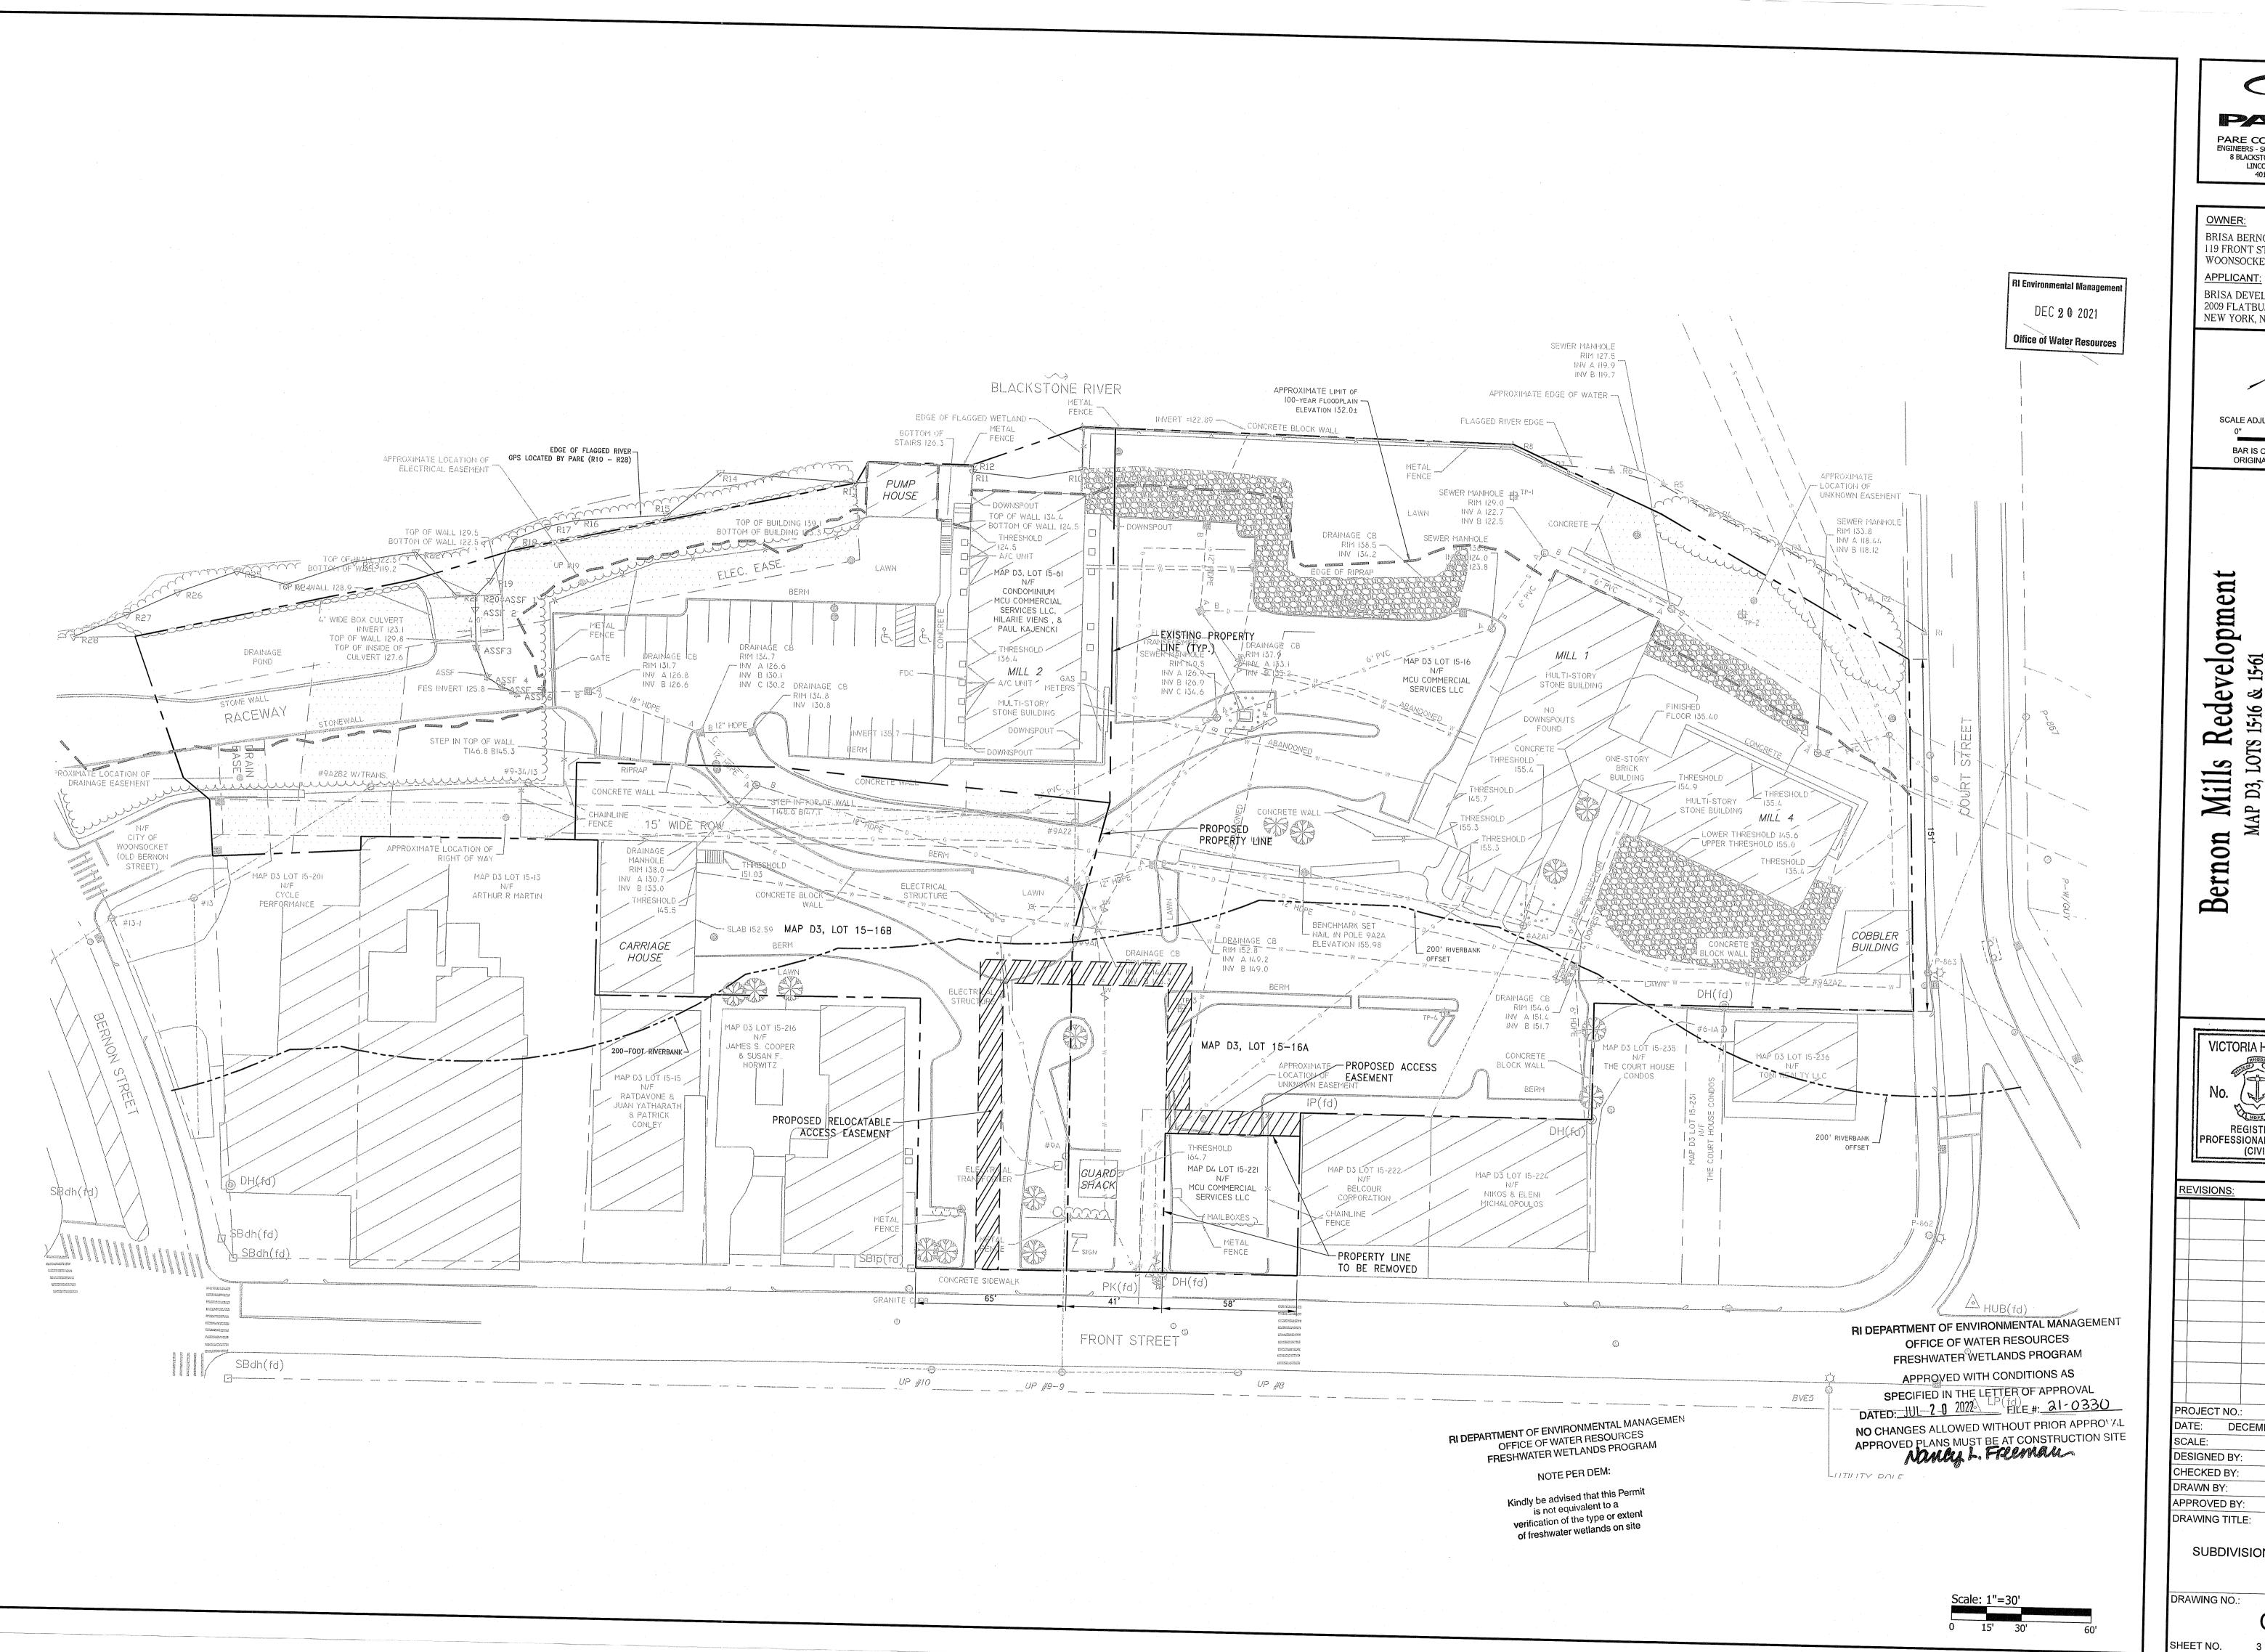



BRISA BERNON MILLS, LP. 119 FRONT STREET, #401 WOONSOCKET, RI 02895

BRISA DEVELOPMENT, LLC 2009 FLATBUSH AVENUE NEW YORK, NY 11234

SCALE ADJUSTMENT GUIDE

BAR IS ONE INCH ON ORIGINAL DRAWING


VICTORIA HOWLAND REGISTERED 12 PROFESSIONAL ENGINEER (CIVIL)

21022.00 DATE: DECEMBER 10, 2021 1"=30' KM VAH AKL VAH

SUBDIVISION PLAN

C0.1 3 OF 18

EROSION AND SEDIMENTATION CONTROL NOTES - RHODE ISLAND **EXISTING** PROPOSED PROJECT LOCATION: 115, 119 FRONT STREET, WOONSOCKET, RI 02895. THE CONTRACTOR AND RELEVANT SUBCONTRACTORS SHALL READ AND UNDERSTAND THE RIPDES GENERAL PERMIT FOR STORMWATER DISCHARGES ASSESSOR'S MAP D3, LOTS 15-16, & 15-61, ASSESSOR'S MAP D4, LOT 15-221 <u>ASSOCIATED WITH CONSTRUCTION ACTIVITY</u> (GENERAL PERMIT) AND THE SITE SPECIFIC <u>SOIL EROSION AND SEDIMENT CONTROL PLAN</u> (SESC) PREPARED FOR PROPERTY LINE HE PROJECT. ALL EROSION CONTROLS SHALL BE IN ACCORDANCE WITH THE RHODE ISLAND SOIL EROSION AND SEDIMENT CONTROL HANDBOOK, LATEST EXISTING CONDITIONS MAPPING TAKEN FROM PLAN ENTITLED "TOPOGRAPHIC SURVEY, 115 FRONT STREET" PREPARED BY DIPRETE ENGINEERING ASSOCIATES. SETBACKS INC. DATED SEPTEMBER 2, 2021. 2. THE CONTRACTOR SHALL BECOME FAMILIAR WITH THE CONDITIONS ISSUED FOR THE PROJECT BY RIDEM AND BE RESPONSIBLE FOR CONFORMANCE WITH ALL PARE CORPORATION EASEMENT LINE WETLAND FLAGS IDENTIFYING WETLAND RESOURCE AREAS WERE PLACED BY PARE CORPORATION ON APRIL 19, 2021 AND FIELD SURVEYED BY DIPRETE PERMIT REQUIREMENTS AND CONSTRUCTION DOCUMENTS. **ENGINEERS - SCIENTISTS - PLANNER** ENGINEERING, AND GPS LOCATED BY PARE CORPORATION ON DECEMBER 3, 2021. 8 BLACKSTONE VALLEY PLACE THE CONTRACTOR SHALL BE RESPONSIBLE FOR ESTABLISHING OR INSTALLING ALL TEMPORARY SEDIMENT AND EROSION CONTROLS AS SHOWN ON THESE CONTOUR LINCOLN, RI 02865 PLANS AND SHALL MAINTAIN ALL EROSION CONTROL MEASURES AS NECESSARY DURING THE ENTIRE CONSTRUCTION PERIOD. 401-334-4100 GENERAL NOTES X 407.5 SPOT ELEVATION ANTI-TRACKING PADS (R.I. STD. DETAIL 9.9.0) SHALL BE PROVIDED AT ALL POINTS OF VEHICULAR INGRESS AND EGRESS ON THE CONSTRUCTION SITE AND PER AVAILABLE RHODE ISLAND DEPARTMENT OF ENVIRONMENTAL MANAGEMENT (RIDEM) MAPPING, THE PROJECT SITE IS LOCATED OUTSIDE OF A NATURAL SHALL BE MAINTAINED TO LIMIT TRACKING OR FLOWING OF SEDIMENT ONTO PUBLIC ROADS. DRAINAGE LINE 5. EROSION CONTROL BARRIERS SHALL BE INSTALLED AS SHOWN ON THE EROSION CONTROL PLAN PRIOR TO COMMENCEMENT OF CONSTRUCTION OPERATIONS. OWNER: THE STATE OF RHODE ISLAND STANDARD SPECIFICATIONS FOR ROAD AND BRIDGE CONSTRUCTION, AMENDED MARCH 2018 WITH ALL REVISIONS AND WATER LINE ____w___w____ ADDENDA, AND THE RHODE ISLAND STANDARD DETAILS ARE MADE A PART HEREOF AS FULLY AND COMPLETELY AS IF ATTACHED HERETO. ALL WORK SHALL BRISA BERNON MILLS, LP. SOIL EROSION AND SEDIMENTATION CONTROL MEASURES SHALL BE INSPECTED AND MAINTAINED ON A WEEKLY BASIS AND AFTER EACH STORM EVENT OF MEET OR EXCEED THE RHODE ISLAND STANDARD SPECIFICATIONS FOR ROAD AND BRIDGE CONSTRUCTION, WITH LATEST REVISIONS. THE LATEST REVISION OF FIRE WATER LINE 0.25 INCH OR GREATER DURING CONSTRUCTION TO ENSURE THAT CHANNELS, DITCHES AND PIPES ARE CLEAR OF DEBRIS AND THAT THE EROSION CONTROL ————FW —————FW ———— 119 FRONT STREET, #401 THE STANDARD SPECIFICATIONS MAY BE OBTAINED AT THE RHODE ISLAND DEPARTMENT OF TRANSPORTATION. BARRIERS ARE INTACT. IDENTIFIED DEFICIENCIES SHALL BE CORRECTED IMMEDIATELY. WOONSOCKET, RI 02895 SANITARY SEWER LINE THE CONTRACTOR SHALL MAKE ALL NECESSARY CONSTRUCTION NOTIFICATIONS AND APPLY FOR AND OBTAIN ALL NECESSARY CONSTRUCTION PERMITS, PAY 7. DUST SHALL BE CONTROLLED BY WATERING OR OTHER APPROVED METHODS AS NECESSARY, OR AS DIRECTED BY THE OWNER OR OWNER'S REPRESENTATIVE. APPLICANT ALL FEES AND POST ALL BONDS ASSOCIATED WITH THE SAME, AND COORDINATE WITH THE ENGINEER AND OWNER'S REPRESENTATIVE AS REQUIRED. GAS LINE THE CONTRACTOR SHALL CLEAN AND MAINTAIN EROSION CONTROL BARRIER WHEN SEDIMENT ACCUMULATES TO ONE HALF THE HEIGHT OF THE BARRIER. BRISA DEVELOPMENT, LLC THE CONTRACTOR SHALL BE SOLELY RESPONSIBLE FOR JOB SITE SAFETY AND PREPARE THEIR OWN SITE-SPECIFIC HEALTH AND SAFETY PLAN BEFORE MATERIAL COLLECTED FROM THE SEDIMENTATION BARRIERS SHALL BE REMOVED AS NECESSARY AND DISPOSED IN AN UPLAND AREA. 2009 FLATBUSH AVENUE ---E----E-----E------ELECTRIC COMMENCING WORK. THE CONTRACTOR SHALL PROVIDE TEMPORARY FENCING AND/OR BARRIERS AROUND ALL OPEN EXCAVATED AREAS IN ACCORDANCE WITH NEW YORK, NY 11234 9. THE CONTRACTOR SHALL SCHEDULE HIS WORK TO ALLOW THE FINISHED SUBGRADE ELEVATIONS TO DRAIN PROPERLY WITHOUT PONDING. SPECIFICALLY TELEPHONE LINE ALLOW WATER TO ESCAPE WHERE PROPOSED CURB MAY RETAIN RUNOFF PRIOR TO APPLICATION OF SURFACE PAVING. PROVIDE TEMPORARY POSITIVE THE CONTRACTOR SHALL BE RESPONSIBLE FOR VERIFYING THAT THE PROPOSED IMPROVEMENTS SHOWN ON THE PLANS DO NOT CONFLICT WITH ANY KNOWN DRAINAGE, AS REQUIRED, TO STABILIZED DISCHARGE POINTS. EXISTING OR OTHER PROPOSED IMPROVEMENTS. IF ANY CONFLICTS ARE DISCOVERED, THE CONTRACTOR SHALL NOTIFY THE OWNER AND THE ENGINEER ----OHW -----OVERHEAD ELECTRIC LINE PRIOR TO INSTALLATION OF ANY PORTION OF THE SITE WORK WHICH WOULD BE AFFECTED. NO FIELD ADJUSTMENTS IN THE LOCATION OF SITE ELEMENTS 10. INSTALLATION OF THE EROSION CONTROL BARRIERS AS ILLUSTRATED IS INTENDED TO REPRESENT THE MINIMUM SEDIMENTATION CONTROL FACILITIES SHALL BE MADE WITHOUT THE ENGINEER'S APPROVAL. NECESSARY TO MEET ANTICIPATED SITE CONDITIONS. ADDITIONAL EROSION CONTROL MEASURES SHALL BE IMPLEMENTED AS CONDITIONS WARRANT OR AS LIMIT OF DISTURBANCE DIRECTED BY THE OWNER OR OWNER'S REPRESENTATIVE. 6. IF ANY DEVIATION OR ALTERATION OF THE WORK PROPOSED ON THESE DRAWINGS IS REQUIRED, THE CONTRACTOR SHALL IMMEDIATELY CONTACT AND CATCH BASIN COORDINATE ANY DEVIATIONS WITH THE ENGINEER AND OWNER. 11. REQUIRED SEDIMENTATION CONTROL FACILITIES MUST BE PROPERLY ESTABLISHED, CLEARLY VISIBLE AND IN OPERATION PRIOR TO INITIATING ANY LAND RI Environmental Managem CLEARING ACTIVITY AND/OR OTHER CONSTRUCTION RELATED WORK. SUCH FACILITIES SHALL REPRESENT THE LIMIT OF WORK. WORKERS SHALL BE INFORMED HYDRANT 7. ANY AREA OUTSIDE OF THE LIMIT OF WORK THAT IS DISTURBED SHALL BE RESTORED TO ITS ORIGINAL CONDITION AT NO ADDITIONAL COST TO THE OWNER. THAT NO CONSTRUCTION ACTIVITY IS TO OCCUR BEYOND THE LIMIT OF WORK AT ANY TIME THROUGHOUT THE CONSTRUCTION PERIOD. SCALE ADJUSTMENT GUIDE ALL SITE WORK SHALL MEET OR EXCEED THE SITE WORK SPECIFICATIONS PREPARED FOR THIS PROJECT DRAINAGE MANHOLE 12. THE CONTRACTOR SHALL MAINTAIN A SUFFICIENT RESERVE OF VARIOUS EROSION CONTROL MATERIALS ONSITE AT ALL TIMES FOR EMERGENCY PURPOSES OR ROUTINE MAINTENANCE BAR IS ONE INCH ON ALL SIGNS SHALL BE REFLECTORIZED TYPE III SHEETING AND CONFORM WITH THE MANUAL OF UNIFORM TRAFFIC CONTROL DEVICES (MUTCD), LATEST SEWER MANHOLE Office of Water Resource ORIGINAL DRAWING 13. EXISTING AND NEWLY INSTALLED CATCH BASINS AND STORM DRAIN INLETS SHALL BE PROTECTED WITH APPROPRIATE TEMPORARY INLET PROTECTION IN ACCORDANCE WITH THE RHODE ISLAND SOIL EROSION AND SEDIMENT CONTROL HANDBOOK. UTILITY POLE 10. ALL UTILITIES (LOCATION AND ELEVATION) DEPICTED SHALL BE CONSIDERED APPROXIMATE ONLY. BEFORE COMMENCING SITE WORK IN ANY AREA, CONTACT "DIG SAFE" AT 1-888-DIG-SAFE (1-888-344-7233) TO ACCURATELY LOCATE UNDERGROUND UTILITIES. ANY DAMAGE TO EXISTING UTILITIES OR 14. DEWATERING WASTE WATERS PUMPED FROM EXCAVATIONS SHALL BE CONVEYED BY HOSE TO AN UPLAND AREA AND DISCHARGED INTO STRAW BALE WATER VALVE CORRALS OR SEDIMENTATION BAGS. STRUCTURES AND THE COST TO REPAIR THE DAMAGES TO INITIAL CONDITIONS, AS DEPICTED ON THE PLANS, SHALL BE THE CONTRACTOR'S RESPONSIBILITY. LIGHT POLE 11. NO EXCAVATION SHALL BE DONE UNTIL UTILITY COMPANIES ARE PROPERLY NOTIFIED IN ADVANCE. NOTE THAT NOT ALL EXISTING UNDERGROUND UTILITIES 15. THE CONTRACTOR SHALL NOT REMOVE ANY TEMPORARY SEDIMENT CONTROL BARRIERS UNTIL THE CONTRIBUTING DRAINAGE AREA HAS BEEN PERMANENTLY ARE SHOWN. IT IS THE CONTRACTOR'S RESPONSIBILITY TO CONTACT ALL RESPECTIVE UTILITY COMPANIES TO VERIFY AND LOCATE EXISTING UTILITIES. TREE LINE 16. CONSTRUCTION SITE WASTE MATERIALS SHALL BE PROPERLY CONTAINED ONSITE AND DISPOSED OFF SITE AT A LOCATION IN ACCORDANCE WITH THE LOCAL 12. THE CONTRACTOR SHALL FAMILIARIZE THEMSELVES WITH THE EXISTING SITE ENVIRONMENTAL LAND USE RESTRICTION AND SOIL MANAGEMENT PLAN. AND STATE REGULATIONS. STONE WALL LAYOUT NOTES 17. RIP-RAP OR OTHER ENERGY DISSIPATERS SHALL BE USED WHERE NECESSARY TO PREVENT SCOUR. _____X____X_____X_____X CHAIN LINK FENCE 1. ALL LINES ARE PERPENDICULAR OR PARALLEL TO THE LINES FROM WHICH THEY ARE MEASURED UNLESS OTHERWISE INDICATED. 18. ALL DISTURBED AREAS SHALL BE STABILIZED WITHIN 14 DAYS UPON COMPLETION OF WORK IN THAT AREA. ACCESSIBLE RAMPS SHALL BE PER THE AMERICANS WITH DISABILITIES ACT (ADA) ACCESSIBILITY GUIDELINES. DECORATIVE FENCE ALL DRAINAGE STRUCTURES SHALL BE CLEARED OF ACCUMULATED SEDIMENT PRIOR TO ACCEPTANCE OF FINAL PROJECT. PRIOR TO COMMENCING WORK, THE CONTRACTOR SHALL PERFORM BENCHMARK FIELD LEVEL VERIFICATION AND COORDINATE LAYOUT CHECK. THE CURBING CONTRACTOR SHALL CONTACT THE ENGINEER IF ANY DISCREPANCIES ARE FOUND. 20. NEWLY VEGETATED AREAS SHALL BE MAINTAINED REGULARLY TO ENSURE STABLE VEGETATED SURFACES. ASPHALT BERM 0 DIMENSIONS OF PARKING SPACES AND DRIVEWAYS ARE FROM FACE OF CURB TO FACE OF CURB. DIMENSIONS FROM BUILDING ARE FROM FACE OF BUILDING 21. EROSION AND SEDIMENTATION CONTROLS SHALL BE UTILIZED AS SHOWN ON THE PLANS. POTENTIAL EROSION AND SEDIMENTATION PROBLEMS ASSOCIATED evel WITH THE CONSTRUCTION OF THE PROJECT SHALL BE AVOIDED THROUGH THE PROJECT SCHEDULING AND THE USE OF APPROPRIATE STANDARD CONTROLS FLUSH CURB (RHODE ISLAND SOIL EROSION AND SEDIMENTATION CONTROL HANDBOOK) AS ILLUSTRATED ON THE PROJECT PLANS. 5. ALIGN WALKWAYS ON DOORWAYS THEY SERVE TO PROVIDE MINIMUM REQUIRED MANEUVERING CLEARANCE IN ACCORDANCE WITH THE AMERICAN WITH **EDGE OF PAVEMENT** DISABILITIES ACT (ADA) ACCESSIBILITY GUIDELINES. 22. WHERE EROSION CONTROLS ARE NEEDED ON IMPERVIOUS SURFACES, THE CONTRACTOR SHALL PROVIDE SAND BAG EROSION CONTROL BARRIER. 16 15. Str SAWCUT LINE eq 23. TEMPORARY DIVERSION (TD) MAY CONSIST OF A DITCH OR SWALE, OR MAY BE ACHIEVED USING WOOD CHIPS, COIR LOGS, OR SIMILAR MATERIALS. TS 15-1 LOT THE CONTRACTOR SHALL COORDINATE ALL DEMOLITION OF STRUCTURES, PAVEMENT AND CONCRETE MATERIALS, AND UTILITIES WITH APPROPRIATE PROPOSED 24. TEMPORARY SEDIMENT TRAPS (TST) AND TEMPORARY SWALES (TSW) SHALL BE SIZED BY THE CONTRACTOR USING THE PARAMETERS CONTAINED IN THE SITE GENERAL, GRADING, UTILITY, AND LANDSCAPING DRAWINGS. RHODE ISLAND SOIL EROSION AND SEDIMENT CONTROL HANDBOOK. COMPOST FILTER SOCK ALL NOTED UTILITIES TO BE REMOVED AND DISPOSED OF, RELOCATED OR CAPPED REPRESENT ALL KNOWN SITE CONDITIONS TO BE DEMOLISHED. THE CONTRACTOR SHALL COORDINATE ALL UNFORESEEN CONDITIONS WITH THE PROJECT ENGINEER, OWNER AND/OR RESPECTIVE UTILITY COMPANIES PRIOR TO 25. EROSION SHALL BE MANAGED DURING AND AFTER CONSTRUCTION AND STORMWATER FROM NEW IMPERVIOUS SURFACE RESULTING FROM DEVELOPMENT SHALL NO. OF PARKING SPACES BE MANAGED AFTER CONSTRUCTION PER SECTION 8.7 OF THE CITY'S SUBDIVISION REGULATIONS AND CHAPTERS 7.5 AND 7.75 OF THE CITY'S CODE OF WETLAND EDGE 500 3. WATER, SEWER, DRAINAGE, GAS, AND OTHER SITE UTILITIES SERVICING THE EXISTING FACILITIES ARE TO REMAIN ACTIVE THROUGHOUT CONSTRUCTION, THERE + STORMWATER MANAGEMENT SYSTEM INSPECTION AND MAINTENANCE NOTES P D MA 115 SHALL BE NO INTERRUPTION OF UTILITY SERVICES DURING THE CONSTRUCTION OPERATION WITHOUT APPROVAL FROM THE OWNER. 50' PERIMETER WETLAND DURING CONSTRUCTION (CONTRACTOR'S RESPONSIBILITY) 200' RIVERBANK THE CONTRACTOR SHALL REMOVE SEDIMENT AND DEBRIS FROM ALL CATCH BASINS, MANHOLES, AND THE DRAINAGE SYSTEM ON A ROUTINE BASIS. UNDERGROUND UTILITIES DEPICTED WERE COMPILED FROM AVAILABLE RECORD PLANS AND SHALL BE CONSIDERED APPROXIMATE ONLY. BEFORE COMMENCING SITE WORK IN ANY AREA, CONTACT "DIG SAFE" AT 1-888-DIG-SAFE (1-888-344-7233) TO ACCURATELY LOCATE UNDERGROUND UTILITIES. ANY DAMAGE IMMEDIATELY FOLLOWING SITE STABILIZATION, AND PRIOR TO PROJECT COMPLETION AND ACCEPTANCE. ATD) = ASHPALT TURNDOWN RA) = RAILING TO EXISTING UTILITIES OR STRUCTURES DEPICTED OR NOT DEPICTED ON THE PLANS SHALL BE THE CONTRACTOR'S RESPONSIBILITY. COSTS TO REPAIR SUCH THE CLOSED DRAINAGE SYSTEM AND ASSOCIATED STRUCTURES SHALL BE CLEANED AND FLUSHED BY THE CONTRACTOR AT THE COMPLETION OF DAMAGES SHALL BE THE CONTRACTOR'S RESPONSIBILITY. NO EXCAVATION SHALL BE DONE UNTIL UTILITY COMPANIES ARE PROPERLY NOTIFIED. CONSTRUCTION, AND THE CONTRACTOR SHALL BE RESPONSIBLE FOR INSPECTION AND MAINTENANCE OF THE DRAINAGE SYSTEM UNTIL ACCEPTANCE OF THE (ATG) = ADJUST TO GRADE(RLS) = RIPRAP LEVEL SPREADER (SEE DETAIL) SYSTEM BY THE ENGINEER AND THE CITY OF WOONSOCKET. FOLLOWING ACCEPTANCE OF THE PROPOSED DRAINAGE SYSTEM, THE OWNER OF THE SITE ALL WORK PERFORMED AND ALL MATERIALS FURNISHED SHALL CONFORM WITH THE LINES AND GRADES ON THE PLANS AND SITE WORK SPECIFICATIONS SHALL BE RESPONSIBLE FOR THE LONG-TERM INSPECTION AND MAINTENANCE OF THE DRAINAGE SYSTEM. (BOL) = BOLLARDRRS) = RIPRAP SLOPE AT ALL LOCATIONS WHERE EXISTING CURBING OR PAVEMENT ABUT NEW CONSTRUCTION, THE EDGE OF THE EXISTING CURB OR PAVEMENT SHALL BE SAWCUT 3. ANY ACCUMULATION OF PONDING WATER IN AREAS WITHIN THE LIMITS OF DISTURBANCE, OTHER THAN DESIGNATED AREAS, SHALL BE REMOVED RS) = RIPRAP SPILLWAY (SEE DETAIL) $\mathbf{\Omega}$ (CFS) = COMPOST FILTER SOCK (SEE DETAIL) TO A CLEAN, SMOOTH EDGE. BLEND NEW PAVEMENT AND CURBS SMOOTHLY INTO EXISTING BY MATCHING LINES, GRADES AND JOINTS. ACCORDINGLY AND PREVENTED IN THE FUTURE. ALL UTILITY COVERS, GRATES, ETC. SHALL BE ADJUSTED TO BE FLUSH WITH THE SURROUNDING SURFACE OR PAVEMENT FINISH GRADE. RIM ELEVATIONS OF RTAD = REFER TO ARCHITECTURAL DRAWINGS (CG) = CLEAR AND GRUB VEGETATION STRUCTURES AND MANHOLES ARE APPROXIMATE. FINAL ELEVATIONS ARE TO BE SET FLUSH AND CONSISTENT WITH THE GRADING PLANS. POST CONSTRUCTION (OWNER'S RESPONSIBILITY) (RTED) = REFER TO ELECTRICAL DRAWINGS (CM) = SAWCUT AND MATCHTRASH, LITTER, SEDIMENT AND OTHER DEBRIS SHALL BE REMOVED FROM ANY STORMWATER MANAGEMENT SYSTEM FACILITY (INCLUDING BUT NOT LIMITED TO THE CONTRACTOR SHALL MAKE ALL ARRANGEMENTS FOR THE ALTERATION OF PRIVATE UTILITIES BY THE UTILITY COMPANIES, AS REQUIRED. CATCH BASINS, MANHOLES, INLET, OUTLET AND DIVERSION STRUCTURES, AND STORMWATER BEST MANAGEMENT PRACTICES (BMPs)) A MINIMUM OF TWO (RTFPD) = REFER TO FIRE PROTECTION DRAWINGS (CP) = CONCRETE PAD TIMES PER YEAR, PREFERABLY IN THE SPRING AND FALL WHERE AN EXISTING UTILITY IS FOUND TO CONFLICT WITH THE PROPOSED WORK, THE LOCATION, ELEVATION AND SIZE OF THE UTILITY SHALL BE ACCURATELY DETERMINED WITHOUT DELAY BY THE CONTRACTOR AND THE INFORMATION SHALL BE PROVIDED ON A SKETCH TO SCALE OF THE EXISTING (RTLD) = REFER TO LANDSCAPE DRAWINGS (CSTR) = CONCRETE STAIRS (SEE DETAIL) UTILITY WITH TIES TO KNOWN POINTS, PHOTOS AND FURNISHED TO THE ENGINEER FOR RESOLUTION. 2. THE PARKING LOT AND ENTRY DRIVE SHALL BE SWEPT BY THE OWNER AS EARLY AS POSSIBLE EVERY SPRING AND ONCE IN THE FALL TO REMOVE SEDIMENTS. (RTMD) = REFER TO MECHANICAL DRAWINGS (CTE) = CONNECT TO EXISTINGTHE CONTRACTOR SHALL PROTECT ALL UNDERGROUND DRAINAGE. SEWER AND UTILITY FACILITIES FROM EXCESSIVE VEHICULAR LOADS DURING CONSTRUCTION. 3. ALL CLEANING AND MAINTENANCE OF STORMWATER MANAGEMENT SYSTEMS POST-CONSTRUCTION SHALL BE THE RESPONSIBILITY OF THE OWNER. ANY DAMAGE TO THESE FACILITIES RESULTING FROM CONSTRUCTION LOADS SHALL BE RESTORED TO ORIGINAL CONDITION AT NO ADDITIONAL COST TO THE (CW) = CROSSWALK (SEE DETAIL) (RTPD) = REFER TO PLUMBING DRAWINGS CATCH BASINS WITH SUMPS INSPECTION, MAINTENANCE, AND REPAIR NOTES $(\mathsf{RTSD}) = \mathsf{REFER} \mathsf{TO} \mathsf{STRUCTURAL} \mathsf{DRAWINGS}$ DAC = REMOVE AND DISPOSE ASPHALT CURB 8. GAS, ELECTRIC, AND COMMUNICATIONS ROUTING ARE SUBJECT TO REVIEW AND APPROVAL BY APPROPRIATE UTILITY COMPANIES. **VICTORIA HOWLAND** INSPECTIONS SHALL BE PERFORMED A MINIMUM OF TWO TIMES PER YEAR (SPRING/FALL). UNITS SHALL BE CLEANED ANNUALLY AND WHENEVER THE DEPTH OF SEDIMENT IS GREATER THAN OR EQUAL TO HALF THE SUMP DEPTH. DB) = REMOVE AND DISPOSE BOLLARD R&D) = REMOVE AND DISPOSE 9. DURING CONSTRUCTION OPERATIONS, THE CONTRACTOR SHALL PROTECT EXISTING UTILITIES BY PROVIDING TEMPORARY SUPPORTS OR SHEETING AS REQUIRED AT NO ADDITIONAL COST TO THE OWNER. 2. THE INLET GRATE SHALL NOT BE WELDED TO THE FRAME OR PAVED OVER SO THAT THE SUMP CAN BE EASILY INSPECTED AND MAINTAINED. DC) = REMOVE AND DISPOSE CURB = SAND BAG BARRIER SB) No. 10. ALL GRAVITY SANITARY PIPING SHALL BE SDR-35 PVC. ALL SEWER CONSTRUCTION SHALL CONFORM TO CHAPTER 18: "WATER AND SEWERS AND SEWAGE 3. CARE SHALL BE TAKEN TO AVOID DAMAGING AND DISPLACING HOODS PLACED ON HOODED OUTLETS DURING CLEANING. DCP (SFCD) = SEDIMENT FOREBAY CHECK DAM (SEE DETAIL) = REMOVE AND DISPOSE CONCRETE PAD DISPOSAL" OF THE WOONSOCKET CITY ORDINANCE. SEDIMENT FOREBAY INSPECTION, MAINTENANCE, AND REPAIR NOTES 11. ALL WATER LINE BENDS AND TEES SHALL BE REINFORCED WITH THRUST BLOCKS. ALL WATER DISTRIBUTION PIPING AND FITTINGS MUST ADHERE TO THE DCW) = REMOVE AND DISPOSE CONCRETE WALK SHP) = HANDICAP PARKING PAVEMENT MARKING (SEE DETAIL) REGISTERED 12-16 LOCAL WATER JURISDICTION SPECIFICATIONS AND SHALL BE INSPECTED BEFORE, DURING, AND AFTER CONSTRUCTION PRIOR TO TAPPING THE SERVICE MAIN. FOLLOWING CONSTRUCTION, THE COMPLETION OF THE INSPECTION AND MAINTENANCE REQUIREMENTS BELOW SHALL BE THE RESPONSIBILITY OF THE OWNER. THE CONTRACTOR SHALL COORDINATE AND CONFIRM ALL WATER DISTRIBUTION MATERIAL PRODUCTS WITH THE LOCAL WATER JURISDICTION PRIOR TO PROFESSIONAL ENGINEER DD) = REMOVE AND DISPOSE DRAINGE SM) = SEDIMENT MARKER SEDIMENT FOREBAY SHALL BE INSPECTED A MINIMUM OF TWO TIMES PER YEAR AND AFTER EVERY STORM OF 2.7" INCH OR GREATER FOR TRASH, (CIVIL) DF SRW) = SEGMENTAL BLOCK RETAINING WALL DEBRIS, SEDIMENT, EROSION, STANDING WATER, AND OVERALL PERFORMANCE. DEFECTS SHALL BE REPAIRED BY THE OWNER. = REMOVE AND DISPOSE FENCE 12. EXCAVATION REQUIRED WITHIN THE PROXIMITY OF EXISTING UTILITY LINES SHALL BE DONE BY HAND. CONTRACTOR SHALL REPAIR ANY DAMAGE TO EXISTING UTILITY LINES OR STRUCTURES INCURRED DURING CONSTRUCTION OPERATIONS AT NO ADDITIONAL COST TO THE OWNER. 2. SEDIMENT FOREBAYS SHALL BE CLEANED IF SEDIMENT REACHES HALF THE DESIGN DEPTH. DFP = REMOVE AND DISPOSE FLEXIBLE PAVMENT TDS) = TEMPORARY DIVERSION SWALE REVISIONS: TCP = TREE GROUP PROTECTION 13. PITCH EVENLY BETWEEN SPOT GRADES. ALL PAVED AREAS MUST PITCH TO DRAIN AT A MIN. OF 1/8" PER FOOT UNLESS SPECIFIED OTHERWISE. 3. SEDIMENT FOREBAY CHECK DAMS SHALL BE REPLACED IF DRAWDOWN TIMES WITHIN THE SEDIMENT FOREBAY EXCEED 48 HOURS FOLLOWING DG = REMOVE AND DISPOSE GAS THE STORM EVENT. 14. THE PROPOSED WALKWAYS SHALL HAVE A MAXIMUM CROSS SLOPE OF 2% AND A MAXIMUM RUNNING SLOPE OF 5% AS SHOWN ON CONSTRUCTION DETAILS (DLP) = REMOVE AND DISPOSE LIGHT POLE TIP) = TEMPORARY INLET PROTECTION 4. ALL SEDIMENTS REMOVED SHALL BE DISPOSED OF AT AN APPROVED AND PERMITTED LOCATION. AND GRADING PLAN. RI DEPARTMENT OF ENVIRONMENTAL MANAGEMENT DW) = REMOVE AND DISPOSE WATER TRM) = TURF REINFORCEMENT MAT VEGETATION SHALL NOT EXCEED 18" IN HEIGHT IN THE SEDIMENT FOREBAYS. ABBREVIATIONS OFFICE OF WATER RESOURCES ETR (TST) = TEMPORARY SEDIMENT TRAP = EXISTING TO REMAIN. PROTECT DURING CONSTRUCTION. ADA = AMERICANS WITH DISABILITIES ACT MAX. = MAXIMUNBIORETENTION AREA INSPECTION, MAINTENANCE, AND REPAIR NOTES FRESHWATER WETLANDS PROGRAM ASSF = AREA SUBJECT TO STORM FLOWAGE MIN. = MINIMUM1. FOLLOWING FIRST 6 MONTHS AFTER CONSTRUCTION GV) = GATE VALVE VCP) = VEHICULAR CONCRETE PAVEMENT BM = BENCHMARK MON. = MONITORING APPROVED WITH CONDITIONS AS NTS, N.T.S. = NOT TO SCALE INSPECT BIORETENTION AREA AFTER FIRST TWO RAINFALL EVENTS OF 1" OR MORE. BMP = BEST MANAGEMENT PRACTICE 12W = 12" SOLID WHITE EPOXY RESIN PAVEMENT MARKING SPECIFIED IN THE LETTER OF APPROVAL (HMA) = HOT MIXED ASPHALT PAVEMENT (SEE DETAIL) OSHA = OCCUPATIONAL SAFETY AND HEALTH ADMINISTRATION RIT. = BITUMINOUS 2. FOLLOWING STORM EVENTS WITH RAINFALL EXCEEDING 2.7" OWS = OIL WATER SEPARATOR $BOT_{\bullet} = BOTTOM$ BC = BOTTOM OF CURB (FINISHED GRADE ON LOW SIDE OF CURB) OCS = OUTLET CONTROL STRUCTURE INSPECT BIORETENTION AREA FOR TRASH, DEBRIS, SEDIMENT, EROSION, STANDING WATER, AND OVERALL PERFORMANCE. DEFECTS SHALL BE (PCFES) = PRECAST CONCRETE FLARED END SECTION BS = BOTTOM OF STAIR (FINISHED GRADE AT BOTTOM STAIR) PERF. = PERFORATED NO CHANGES ALLOWED WITHOUT FRIOR APPROVAL BW = BOTTOM OF WALL (FINISHED GRADE ON LOW SIDE OF WALL) PE = POLYETHYLENE APPROVED PLANS MUST BE AT CONSTRUCTION SITE PVC = POLYVINYL CHLORIDE 3. BI-ANNUALLY CI = CAST IRONRIDOT STANDARDS LEGEND: CB = CATCH BASIN, 4' DIA. UNLESS OTHERWISE NOTED R=X = RADIUS (IN FEET). INSPECT BIORETENTION AREA A MINIMUM OF TWO TIMES PER YEAR, PREFERABLY IN APRIL AND OCTOBER. SEDIMENT SHALL BE REMOVED FROM Duly L. Freenan (4.2.0) = PRECAST 4'-0" ROUND MANHOLE - R.I. STD. 4.2.0 RCP = REINFORCED CONCRETE PIPE CLDI = CEMENT-LINED DUCTILE IRON BIORETENTION AREA IF THE SEDIMENT EXCEEDS 1" RIDEM = RHODE ISLAND DEPARTMENT OF ENVIRONMENTAL MANAGEMENT CL. = CLASS MOW SIDE SLOPES AND BOTTOM OF BIORETENTION AREA A MINIMUM OF TWO TIMES PER YEAR. RIDOT = RHODE ISLAND DEPARTMENT OF TRANSPORTATION CLSM = CONTROLLED LOW STRENGTH MATERIAL (7.1.0) = PRECAST CONCRETE CURB - R.I. STD. 7.1.0 RIHP = RHODE ISLAND HIGHWAY PLAT CO = CLEANOUT RIPDES = RHODE ISLAND POLLUTION DISCHARGE ELIMINATION SYSTEM CONC. = CONCRET INSPECT BIORETENTION AREA OUTLET CONTROL STRUCTURE AND ALL OVERFLOW CHANNELS. THE OWNER SHALL STABILIZE ERODED BANKS AND (7.1.1) = 3'-0" Precast concrete transition curb - r.i. std. 7.1.1 CC = CONCRETE CURB, VERTICAL R.I. STD. = RHODE ISLAND STANDARD REPAIR ERODED AREAS AT INFLOW AND OUTFLOW STRUCTURES AS NECESSARY. PROJECT NO.: 21022.00 SMH = SEWER MANHOLE DEMO = DEMOLITION (7.1.2) = 6'-0" PRECAST CONCRETE TRANSITION CURB - R.I. STD. 7.1.2 DATE: **DECEMBER 10, 202** DIA = DIAMETERSWL = SINGLE SOLID WHITE LINE 5. IF SEDIMENT BUILD-UP HAS LIMITED THE FILTERING CAPABILITIES TO BELOW THE DESIGN RATE OR PONDING HAS EXCEEDED 48 HOURS SESC = SOIL EROSION AND SEDIMENT CONTROL DIV = DIVERSION THE FOLLOWING SHALL BE COMPLETED: (7.3.0) = GRANITE CURB - R.I. STD. 7.3.0 SCALE: NOT TO SCALI DYL = DOUBLE YELLOW LINE SDR = STANDARD DIMENSIONAL RATIO • THE TOP 6" OF SOIL SHALL BE REMOVED AND DISPOSED AT A PERMITTED LOCATION. DMH = DRAIN MANHOLE TD = TEMPORARY DIVERSION DESIGNED BY: THE EXPOSED SURFACE SHALL BE SCARIFIED. (7.5.1) = BITUMINOUS BERM - R.I. STD. 7.5.1 EOP = EDGE OF PAVEMENT TST = TEMPORARY SEDIMENT TRAP THE TOP 6" SHALL BE RESTORED TO THE ORIGINAL DESIGN SPECIFICATIONS TSW = TEMPORARY SWALE RI DEPARTMENT OF ENVIRONMENTAL MANAGEMENT CHECKED BY ELEV, EL = ELEVATION (9.7.0) = DEWATERING BASIN - R.I. STD. 9.7.0 ELUR = ENVIRONMENTAL LAND USE RESTRICTION TP = TEST PIT 6. TRASH AND DEBRIS SHALL BE REMOVED FROM BIORETENTION AREA AS NECESSARY. OFFICE OF WATER RESOURCES DRAWN BY: AKL TC = TOP OF CURB EX, EXIST. = EXISTINGFRESHWATER WETLANDS PROGRAM (9.9.0) = CONSTRUCTION ACCESS - R.I. STD. 9.9.0EXCB = EXISTING CATCH BASIN TS = TOP OF STAIR (FINISHED GRADE OF TOP STAIR) APPROVED BY: VAH EXDMH = EXISTING DRAIN MANHOLE TW = TOP OF WALL(34.4.0) = STEEL BACKED TIMBER GUARDRAIL - R.I. STD. 34.4.0 FFE = FINISH FLOOR ELEVATION TYP. = TYPICAL DRAWING TITLE: NOTE PER DEM: UP = UTILITY POLE FT = FOOTVGC = VERTICAL GRANITE CURB (43.1.0M) = CEMENT CONCRETE SIDEWALK (MODIFIED) - R.I. STD. 43.1.0M FND. = FOUNDKindly be advised that this Permit GTD = GRADE TO DRAINVC = VITRIFIED CLAY NOTES & LEGEND WD = WOONSOCKET DATUM is not equivalent to a (43.3.0M) = WHEELCHAIR RAMP - R.I. STD. 43.3.0 GRAN. = GRANITE HDPE = HIGH DENSITY POLYETHYLENE PIPE WPM = WATER PAINT MARK verification of the type or extent HMA = HOT MIX ASPHALT w/ = WITH(43.3.1M) = WHEELCHAIR RAMP FOR LIMITED RIGHT-OF-WAY AREAS - R.I. STD. 43.3.1M of freshwater wetlands on site YD = YARD DRAIN HYD = HYDRANTI.D. = INNER DIAMETER (43.4.0) = DRIVEWAY DEVELOPMENT FOR 3'-0" TRANSITION CURB - R.I. STD. 43.4.0 DRAWING NO.: INV. = INVERT LOD = LIMIT OF DISTURBANCE (43.5.0) = CEMENT CONCRETE DRIVEWAYS - R.I. STD. 43.5.0 LP = LOW POINT MUTCD = MANUAL OF UNIFORM TRAFFIC CONTROL DEVICES, LATEST EDITION (48.1.0M) = DETECTABLE WARNING SYSTEM (MODIFIED) - R.I. STD. 48.1.0M SHEET NO. 4 OF 18

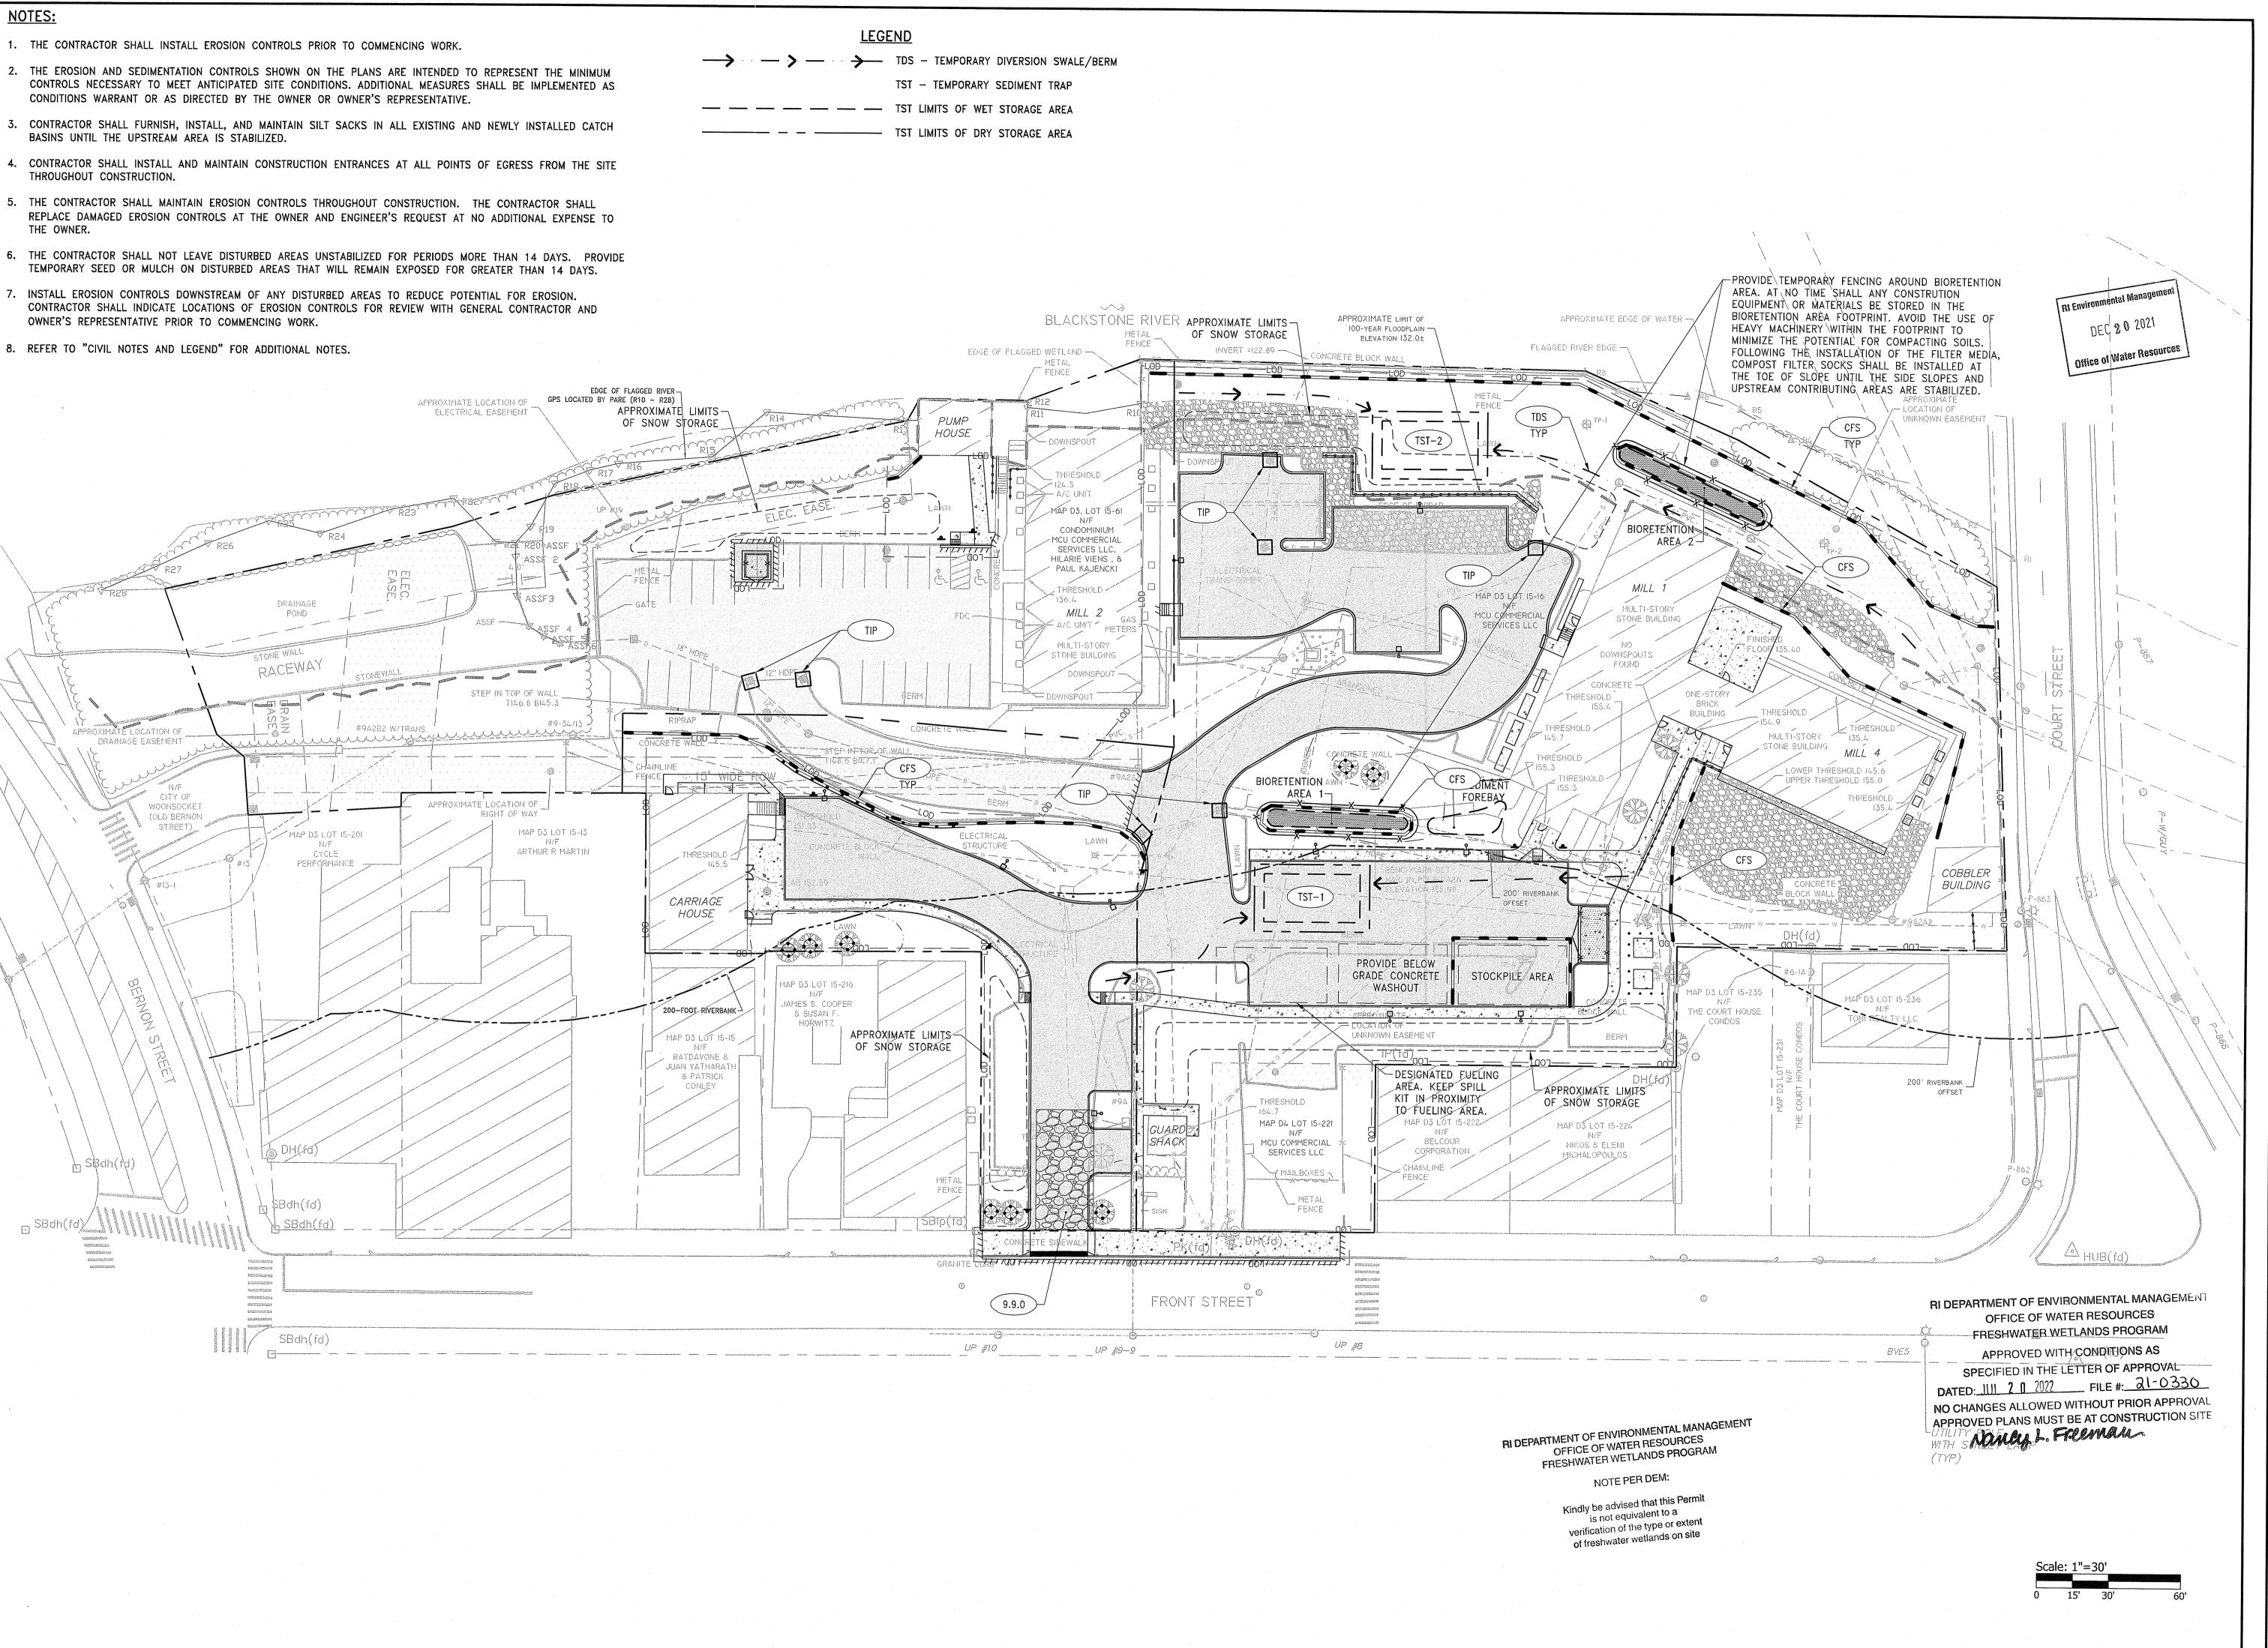




OWNER: BRISA BERNON MILLS, LP. 119 FRONT STREET, #401 WOONSOCKET, RI 02895 APPLICANT:

BRISA DEVELOPMENT, LLC 2009 FLATBUSH AVENUE NEW YORK, NY 11234

SCALE ADJUSTMENT GUIDE

BAR IS ONE INCH ON ORIGINAL DRAWING

ledevelopment D3, (AP 5 & Ber

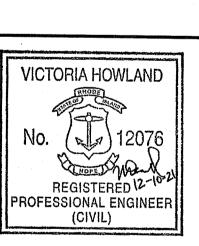


REVISIONS: PROJECT NO.: 21022.00 DATE: DECEMBER 10, 2021 SCALE: 1"=30' DESIGNED BY: CHECKED BY: VAH DRAWN BY: APPROVED BY: DRAWING TITLE:

EROSION & SEDIMENT CONTROL PLAN

DRAWING NO.:

SHEET NO. 5 OF 18

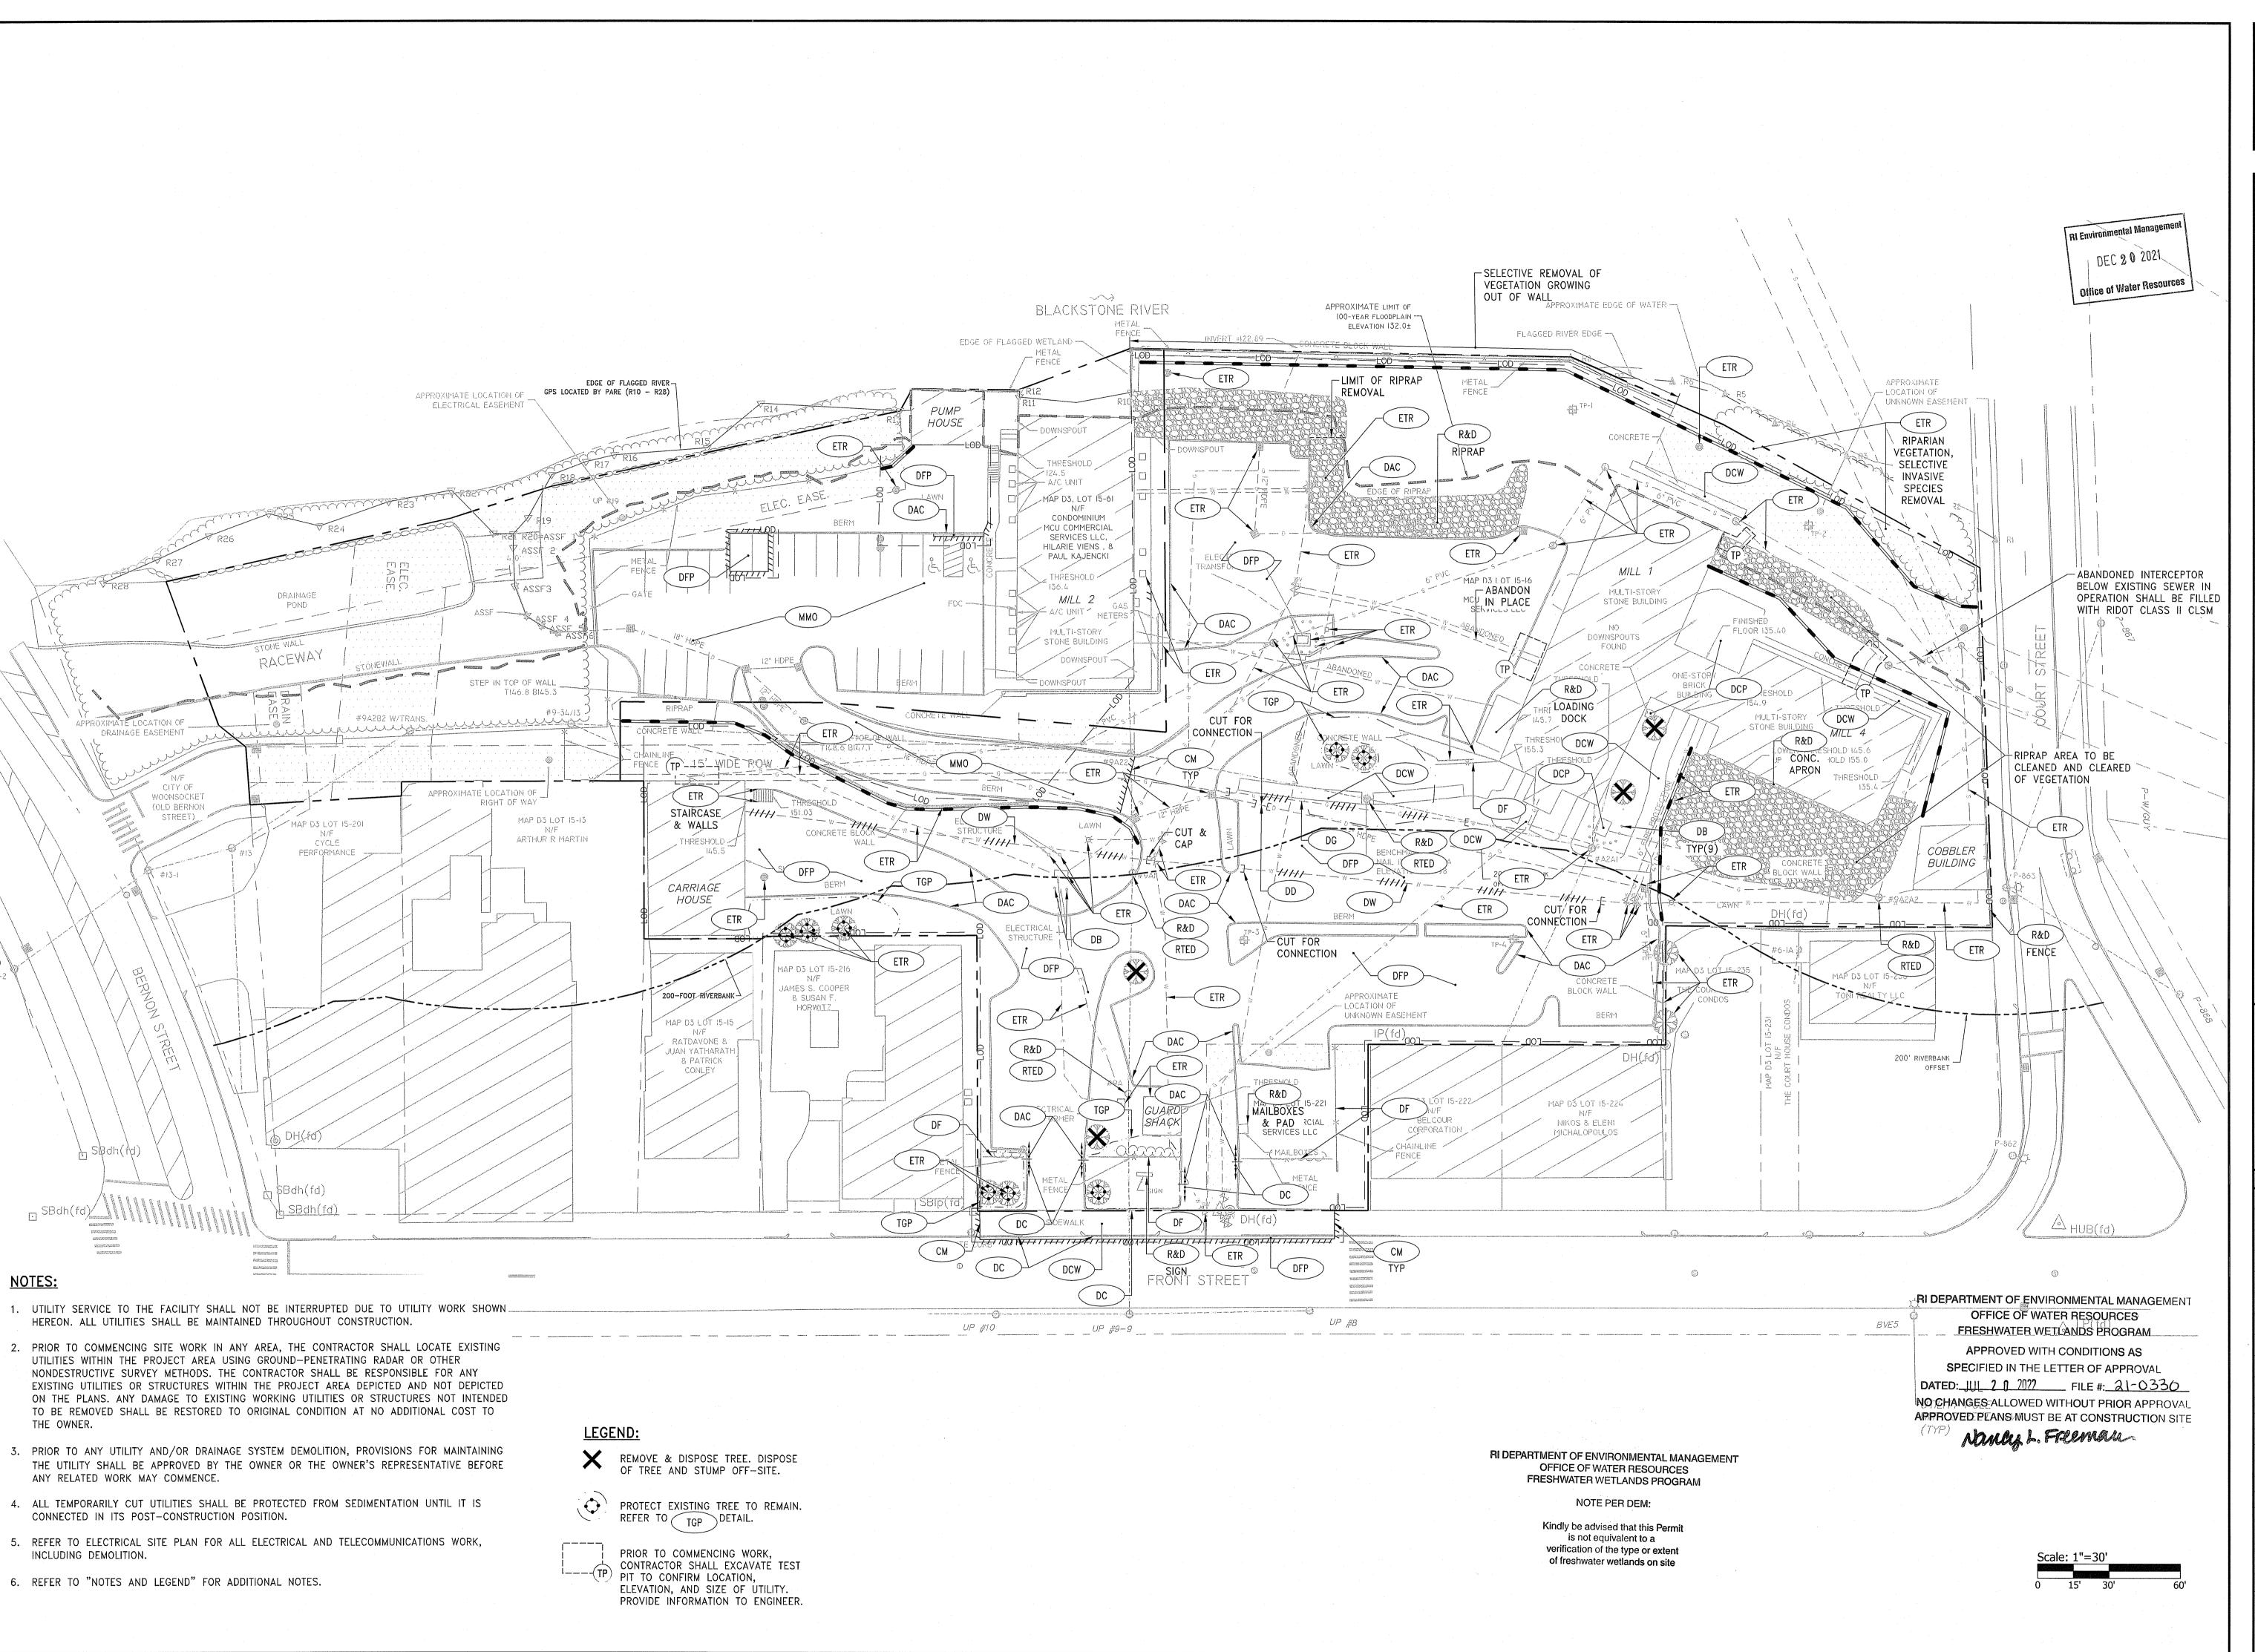



401-334-4100

BRISA BERNON MILLS, LP. 119 FRONT STREET, #401 WOONSOCKET, RI 02895 APPLICANT:

BRISA DEVELOPMENT, LLC 2009 FLATBUSH AVENUE NEW YORK, NY 11234

SCALE ADJUSTMENT GUIDE

BAR IS ONE INCH ON

ORIGINAL DRAWING

Redevelopment Mill rnon

Bei

VICTORIA HOWLAND REGISTERED 12 PROFESSIONAL ENGINEER (CIVIL)

REVISIONS: PROJECT NO.: 21022.00 DATE: DECEMBER 10, 2021 SCALE: 1"=30' **DESIGNED BY:** CHECKED BY: DRAWN BY: APPROVED BY:

ΚM

DRAWING TITLE:

DEMOLITION PLAN

DRAWING NO.: C3.1

6 OF 18

SHEET NO.

PARKING SUMMARY MAP D3, LOT 15-61 MAP D3, LOT 15-16A MAP D3, LOT 15	-16B TOTAL		
	VIDED EXISTING REQUIRED PROVIDED 6 78 77 79		PAF ENGIN 8
CESSIBLE SPACES** 2 1 2 0 2 2 1 TAL SPACES 28 19 26 54 ± 46 51 16	1 2 4 5 7 80 81 84		٥
COUIRED DT 15-61: RESIDENCES WITHIN DOWNTOWN OVERLAY DISTRICT: RESIDENCES WITHIN DOWNTOWN OVERLAY DISTRICT: 1 SPACE PER DWELLING UNIT 1 SPACE PER DWELLING UNIT 3 SPACES FOR			OWNE BRISA
19 DWELLING UNITS PROPOSED 1 SPACE X 19 DWELLING UNITS = 19 SPACES 1 SPACE X 19 DWELLING UNITS = 19 SPACES 1 SPACE X 41 DWELLING UNITS = 41 SPACES 3 SPACES X (5	AND THE PROPERTY OF THE PROPER	Toylor -	nmental Management WOON APPLI
OFFICE FACILITIES: 3 SPACES FOR EACH 1,000 SF OF OFFICE SPACE 1,542 SF OFFICE SPACE 3 SPACES X (1,542 SF/1,000 SF) = 5 SPACES	BLACKSTONE RIVER (TYP.)	run, l	DEC 20 2021 BRISA 2009 F NEW Y
DA REQUIREMENT FOR PARKING LOT 1 TO 25 TOTAL SPACES = 1 SPACE 26 TO 50 TOTAL SPACES = 2 SPACES	RTAD DEDGE OF FLAGGED WETLAND FENCE INVERT =122.8 CONCRETE BLOCK WALL	FLAGGED RIVER EDGE Office	ice of Water Resour
51 TO 75 TOTAL SPACES = 3 SPACES 76 TO 100 TOTAL SPACES = 4 SPACES EDGE OF FLAGGED RIV APPROXIMATE LOCATION OF GPS LOCATED BY PARE (R10 - R2) ELECTRICAL EASEMENT	DUMPSTER HOUSE RIZE RIZE RIZE RIZE RIZE RIZE RIZE RIZ	METAL APPROXIMATE FENCE R5 LOCATION OF UNKNOWN EASEMENT	
		TLD SRW RETEX	so
R18 R16	43.1.0M) (43.1.0M) (43.1.0M)	NCE STORY OF THE PROPERTY OF T	
R23	VCP FENCE ON SIGN SIGN SIGN SIGN SIGN SIGN SIGN SIG	BIORETENTION AREA 2	
R27 R27 R27 R27 R27 R27 R27 R27	SIGN SERVICES LLC R7-8 HILARIE VIENS, 8 PARTLD RTLD RTLD CSTR 7.5.1	SRW MILL 1	
DRAINAGE POND ASSE	7.1.1 THANDRAIL OF TYP: A/C UNIT METERS	ATD STOREFRONT DOOR STOREFRONT DOOR	
STONE WALL	RTMD (TYP) HMA MULTI-STORY STONE BUILDING	RTLD RTSD RTSD RTAD RTAD	86
RACEWA STONEWALL STEP IN TOP OF WALL TI46.8 BI45.5	4 UTILITY DOWNSPOUT DOWNSPOUT DOWNSPOUT DOWNSPOUT	RTLD ONE-STORY STORE FRONT DOOR 20' RTLD BRICK SILL DETAIL (TYP) THREE HOLD SILL DETAIL (TYP)	
APPROXIMATE LOCATION OF #9-54/13271 APPROXIMATE LOCATION OF CONCE	CONCRETE WALL 7.5.1 CONCRETE WALL CONCRETE WALL	THRESHOLD CP MULTI-STORY ISS. 4 WILL 4 THRESHOLD RTMD R	
CHAINL FENCE	R7-8 1148.6 P 34.4.0 NE R7-8P #9A223 BIORETENTION AWN AREA 1 43.1.0M	SEDIMENT SIGN RTAD LOWER THRESHOLD 145.6 UPE 43.1.0M LD 155.0 THRESHOLD 145.6 THRESHOLD 145.6	5
CITY OF WOONSOCKET (OLD BERNON STREET) APPROXIMATE LOCATION OF RIGHT OF WAY RTSD	8.3.1M BERM DO SIGN 12W	R7/8 STOREFRONT DOOR SILL DETAIL (TYP)	P-W/GU
MAP D3 LOT 15-201 N/F CYCLE PERFORMANCE PERFORMANCE MAP D3 LOT 15-201 N/RTAD ARTHUR R PHAP D3 LOT 15-201 N/RTAD DOOR SILL 2'	STRUCTURE THE 7.1.2 BY BY CRETE PLOC THE 12W BOL 12W BOL 12W BOL	43.3.0M SIGN R77-8-A AI (48.1.0M) COMBRER BUILDING	
#13-1 DOOK SILL 2 DETAIL (TYP)	CARRIAGE TYPE TO THE TOTAL TO THE TOTAL THE TO	2 0 R7 - 8P SHP 6 - 49.42 2 49	33
	7.5.1 HMA 9'-	ATD ATD OP DH(fd) OP DH(fd) OP DH(fd) OP DH(fd) RTLD RTLD	\$
	7.1.0 SIGN N/F JAMES S. COOPER JAMES S. COOPER	TENCE MAP D3 L0T I5-236 MAP D3 L0T I5-236	
	200-FOOT RIVERBANK A 8. SUSAN F. HORWITZ MAP D3 LOT 15-15 RTED REPROVIDENT A 3.3.1M A 3.3.1M A 3.3.1M	AND GENERATOR S SERMENT 7.1.0 BERM RIED RICHARD TONI FALTY LLC	
	N/F (48.1 0M)	BOLLARDS (12) (TYP) RILD VCP BOLLARDS (12) (TYP) BOLLARDS (12) (TYP)	
ZONING TABLE NG ZONE: MU-1 MIXED USE 1		TYP. DUMPSTER ENCLOSURE MAP D3 LOT 15-222 ENCLOSURE MAP D5 LOT 15-224	
OWN OVERLAY DISTRICT, SPECIAL FLOOD HAZARD OVERLAY DISTRICT, RIVER CORRIDOR OVERLAY CT, DESIGN REVIEW OVERLAY DISTRICT LOT AREA	HMA THANSEORMER TYP. N/F MCU COMMERCIAL SERVICES LLC SERVICES LLC	BELCOUR CORPORATION CHAINLINE N/F N/F N/F N/F N/F N/F N/F N/F N/F N/	
3 LOT 15-61 = 1.11 ACRES (48,468 SF) 3 LOT 15-16 = 2.72 ACRES (118,773 SF) 3 LOT 15-16A = 2.19 ACRES (95,517 SF)	SIGN MAILBOXES METAL 12W SIGN B WETAL FENCE	XISTING ACCESS	
3 LOT 15-16B = 0.61 ACRES (26,733 SF) 4 LOT LOT 15-221 = 0.08 ACRES (3,477 SF) IG FOOTPRINT		ASEMENT TO BE	HUB(fd)
H-61: TOTAL BUILDING AREA = 5,364 ± SF (EXISTING AND PROPOSED) H-16: TOTAL BUILDING AREA = 14,044 ± SF (EXISTING) H-16A: TOTAL BUILDING AREA = 11,922 ± SF (PROPOSED)	7.1.1 43.4.0 7.1.1 HMA (1) (1) (1) (1) (1) (1) (1) (1) (1) (1)		
6-6B: TOTAL BUILDING AREA = 2,620 ± SF (PROPOSED) 6-221: TOTAL BUILDING AREA = 0 SF REQUIRED MAP D3, LOT 15-61 MAP D3, MAP D3, MAP D3, LOT 15-16B	FRONT STREET BUILDING SETBACK 7.3.0 (TYP.)		
(MU-1) EXISTING PROVIDED EXISTING PROVIDED PROVIDED	NOTES: 1. CONTRACTOR SHALL PROVIDE LOAM AND SEED ON ALL DISTURBED AREAS UNLESS NOTED OTHERWISE.	BVE5 RI DEPARTMENT OF ENVIRONM OFFICE OF WATER F	LP(fd) WENTAL MANAGEMENT
DING SETBACK 20 FT 327 FT 327 FT* 1 FT 1 FT* 117 FT* SIDE SETBACK 10 FT 11 FT 11 FT* 1 FT 16 FT* 1 FT*	REFER TO LANDSCAPE DRAWINGS TO LANDSCAPE DRAWINGS FOR SURFACE COVER IN LANDSCAPED AREAS. 2. ALL ACCESSIBLE RAMPS SHALL BE CONSTRUCTED WITH DETECTABLE WARNING PANELS.	FRESHWATER WETLAN APPROVED WITH CO	NDS PROGRAM
SIDE SETBACK 10 FT 11 FT 11 FT* 1 FT 16 FT* 1 FT* REAR SETBACK 25 FT 12 FT 12 FT* 2 FT 141 FT* 2 FT* REET FRONTAGE VARIES** 0 FT 0 FT* 316 FT 197 FT 60 FT	3. PRIOR TO COMMENCING WORK, THE CONTRACTOR SHALL EMPLOY A PROFESSIONAL LAND SURVEYOR REGISTERED IN THE STATE OF RHODE ISLAND TO ESTABLISH CONTROL ON THE SITE AND TO PERFORM	ONTED: JUL 2 0 2022 F	FILE #: 21-0330
SSORY SETBACK 5 FT N/A N/A 21 FT 5 FT* N/A SUMBLING HEIGHT 70 FT 4 STORIES 4 STORIES 3 STORIES 2 STORIES	FIELD MEASUREMENTS AS REQUIRED TO LAYOUT THE PROPOSED BUILDING AND SITE IMPROVEMENTS. THE CONTRACTOR'S SURVEYOR SHALL COORDINATE THE BUILDING LAYOUT WITH THE PROJECT LAND SURVEYOR TO ACCURATELY LOCATE THE BUILDING ON THE SITE.	NO CHANGES ALLOWED WITH APPROVED PLANS MUST BE A NOULLA L. FILE	IOUT PRIOR APPROVAL PR
BUILDING HEIGHT 30 FT 4 STORIES 55 FT 8 63 FT 63 FT 25 FT * AX. BUILDING COVERAGE 50% 11% 11% 12% 12% 10%	4. REFER TO STRUCTURAL DRAWINGS FOR ALL CONCRETE ENTRANCE PADS.	RI DEPARTMENT OF ENVIRONMENTAL MANAGEMENT OFFICE OF WATER RESOURCES FRESHWATER WETLANDS PROGRAM	DE CH
MAX. GFA ON-RESIDENTIAL) 5,000 SF 0 SF 0 SF 1,542 SF 5,240 SF	 REFER TO STRUCTURAL DRAWINGS FOR ALL TYPICAL SECTIONS OF ENTRY WAYS. EXPANSION JOINTS (E.J.) 20 FEET O.C. (MAX.) UNLESS OTHERWISE NOTED. 	NOTE PER DEM:	DR/ APF DR/
MAX. UNITS (RESIDENTIAL) 25 16 19 0 41 0 MAX. PRINCIPAL 1 1 3 2 1	7. CONTROL JOINTS (C.J.) 5 FEET O.C. (MAX.) UNLESS OTHERWISE NOTED.	Kindly be advised that this Permit is not equivalent to a verification of the type or extent Scale:	
BUILDINGS 1 1 3 2 1 1 2 1 1 2 1 1 2 1 1	8. ALL PARKING SPACES AND ISLANDS ARE TO BE MARKED WITH 4" THICK WHITE EPOXY PAVEMENT MARKING UNLESS NOTED OTHERWISE. WATERBORNE PAVEMENT MARKINGS ARE NOT ACCEPTABLE.	of freshwater wetlands on site	15' 30' 60'
o' FOR FIRST UNIT PLUS 10' PER EACH ADDITIONAL UNIT P D3, LOT 15-16A - 410 FT P D3, LOT 15-16A - 410 FT	9. COORDINATE FINAL QUANTITY AND PLACEMENT OF BOLLARDS SURROUNDING TRANSFORMER WITH NATIONAL GRID.		
MAP D3, LOT 15-16B - 70 FT	10. REFER TO "CIVIL NOTES AND LEGEND" FOR ADDITIONAL NOTES.		SHE

PORATION TISTS - PLANNERS VALLEY PLACE RI 02865 -4100

MILLS, LP. EET, #401 RI 02895

PMENT, LLC AVENUE 11234

TMENT GUIDE 1" E INCH ON DRAWING


MAP D4, LOT 15-221 115 & 119 Front Street Woonsocket, Rhode Island

HOWLAND 12076 TEJ WAR 12-10-21 STERED 12-10-21 IAL ENGINEER VIL)

21022.00 EMBER 10, 2021 1"=30' KM VAH AKL VAH

L PLAN 1

C4.1 <u>7</u> OF <u>18</u>

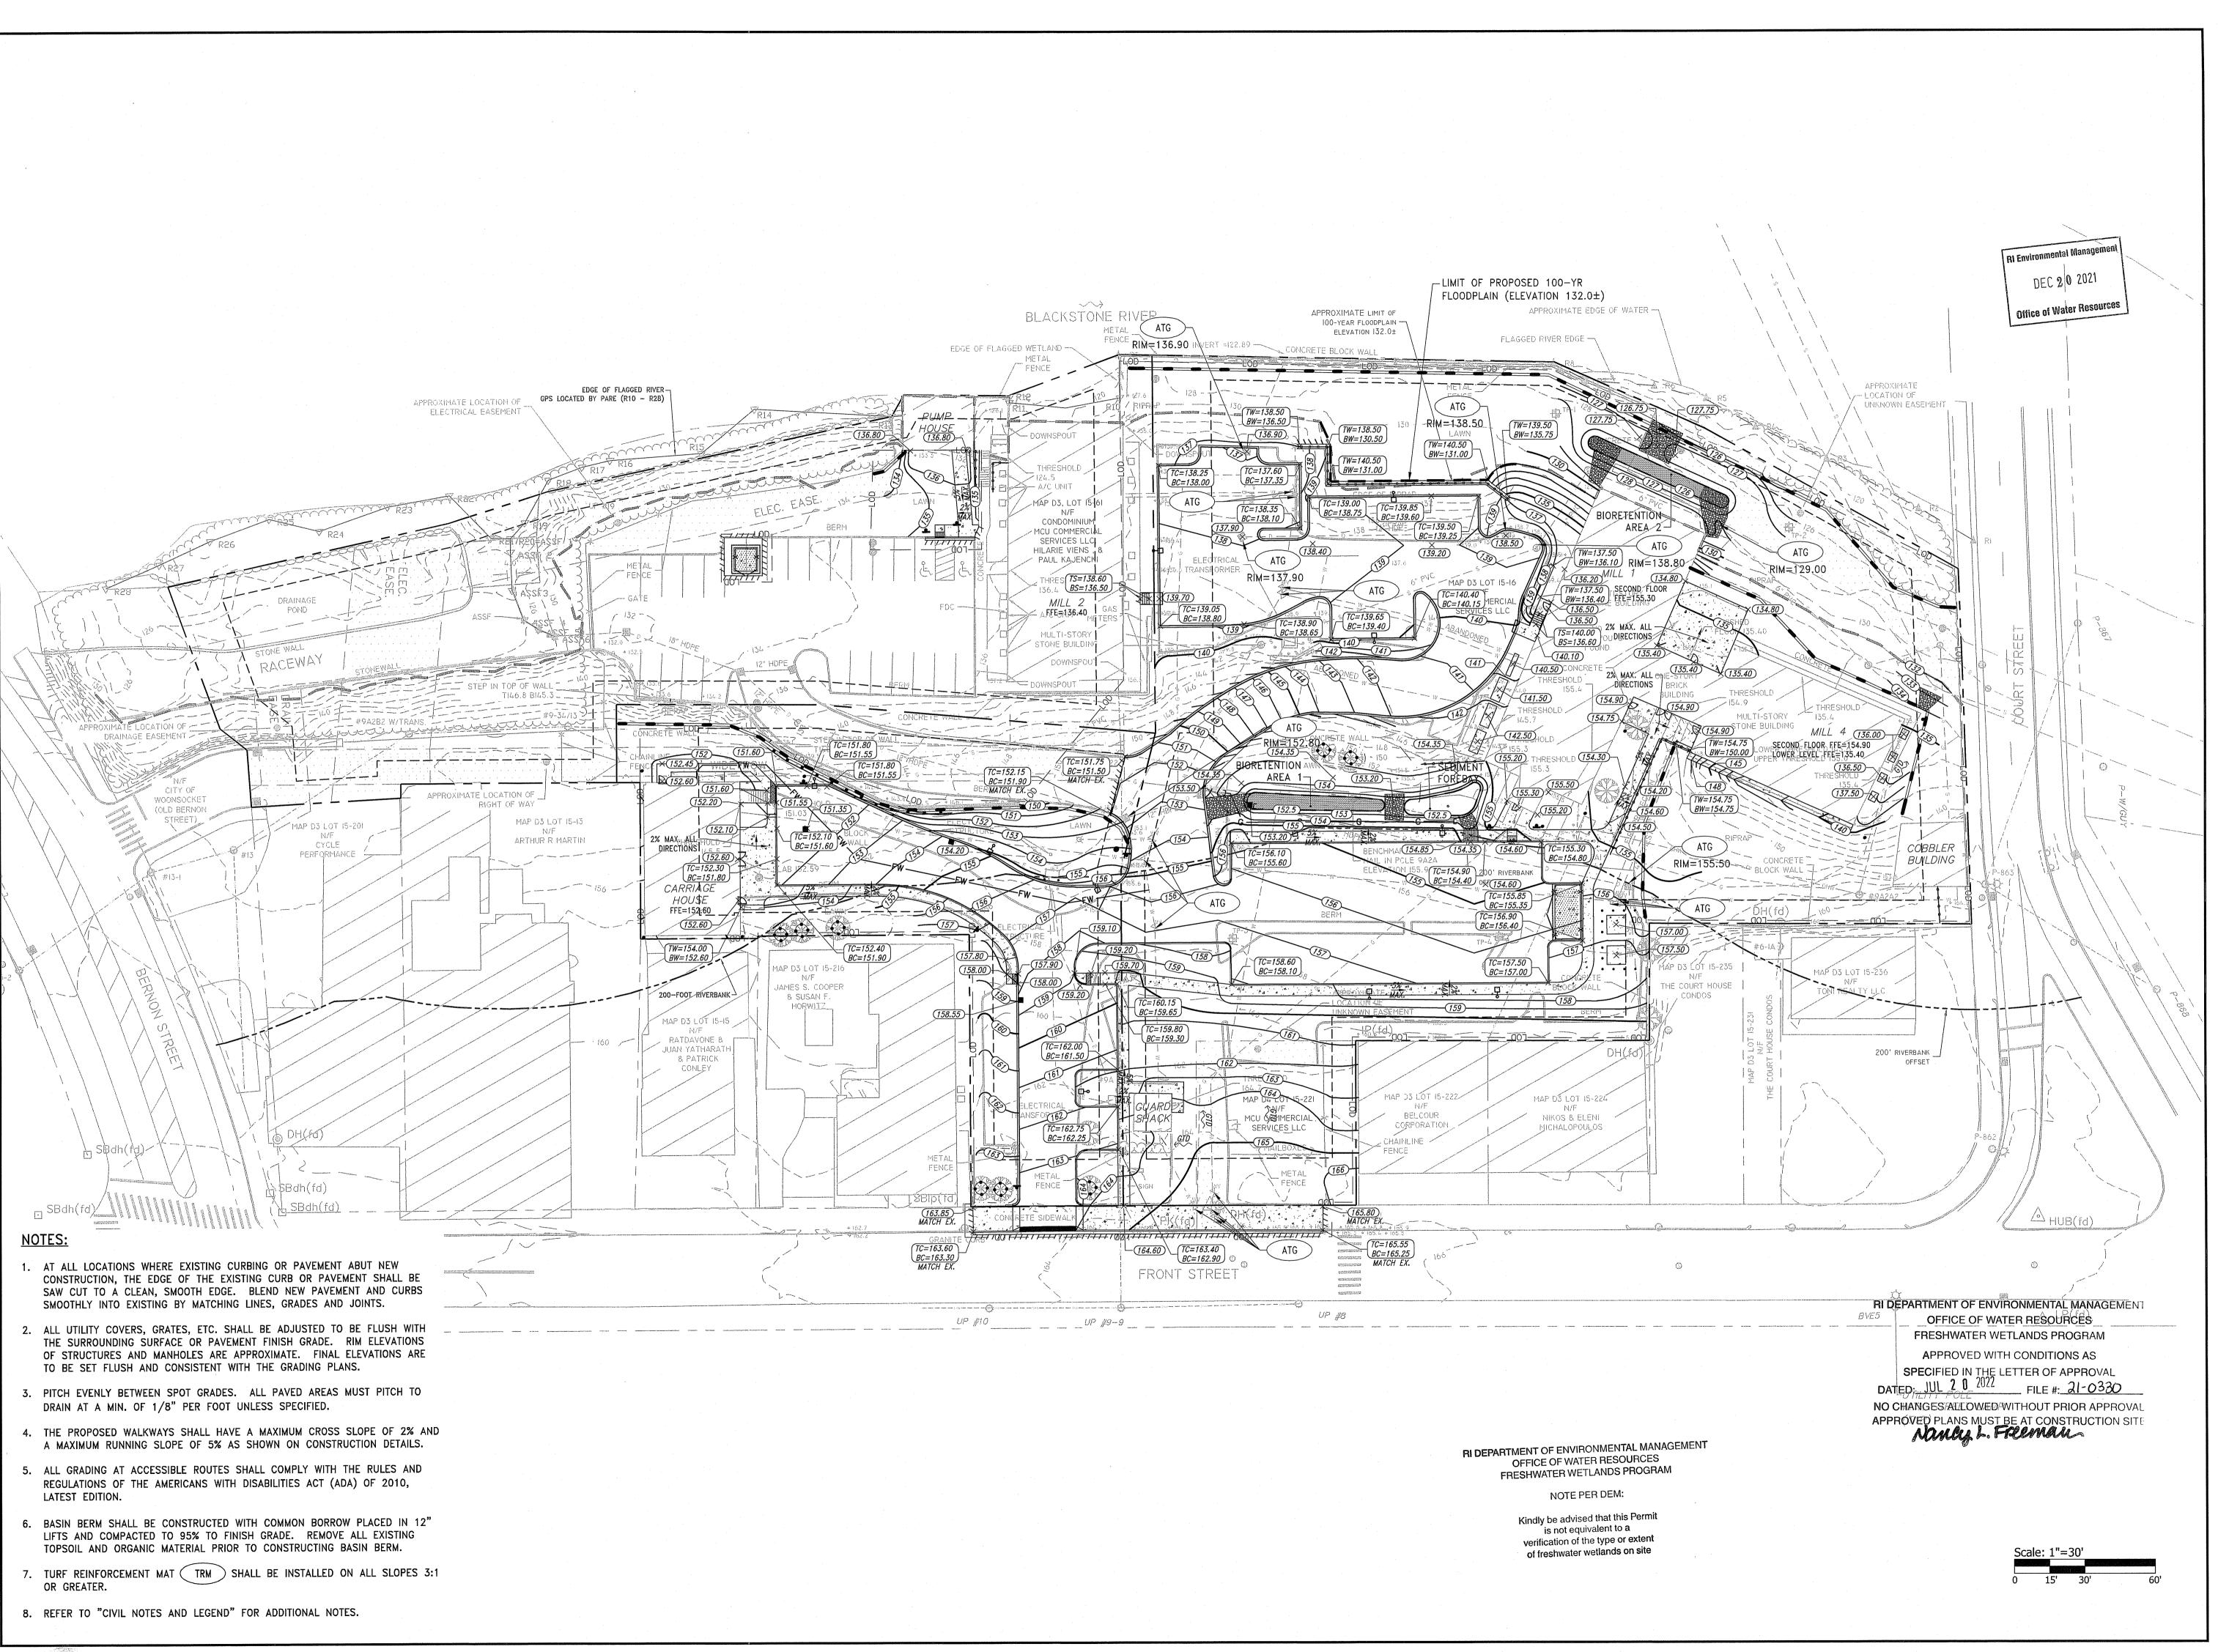



BRISA BERNON MILLS, LP. 119 FRONT STREET, #401 WOONSOCKET, RI 02895 APPLICANT:


BRISA DEVELOPMENT, LLC 2009 FLATBUSH AVENUE NEW YORK, NY 11234

SCALE ADJUSTMENT GUIDE

BAR IS ONE INCH ON

ORIGINAL DRAWING

levelopment rnon Bei

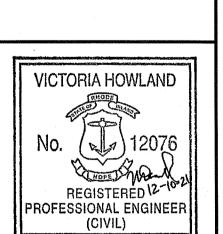

REVISIONS: PROJECT NO.: 21022.00 DATE: DECEMBER 10, 2021 DESIGNED BY: CHECKED BY: DRAWN BY: APPROVED BY: DRAWING TITLE:


GRADING PLAN 1

C5.1

8 OF 18

DRAWING NO.:

SHEET NO.

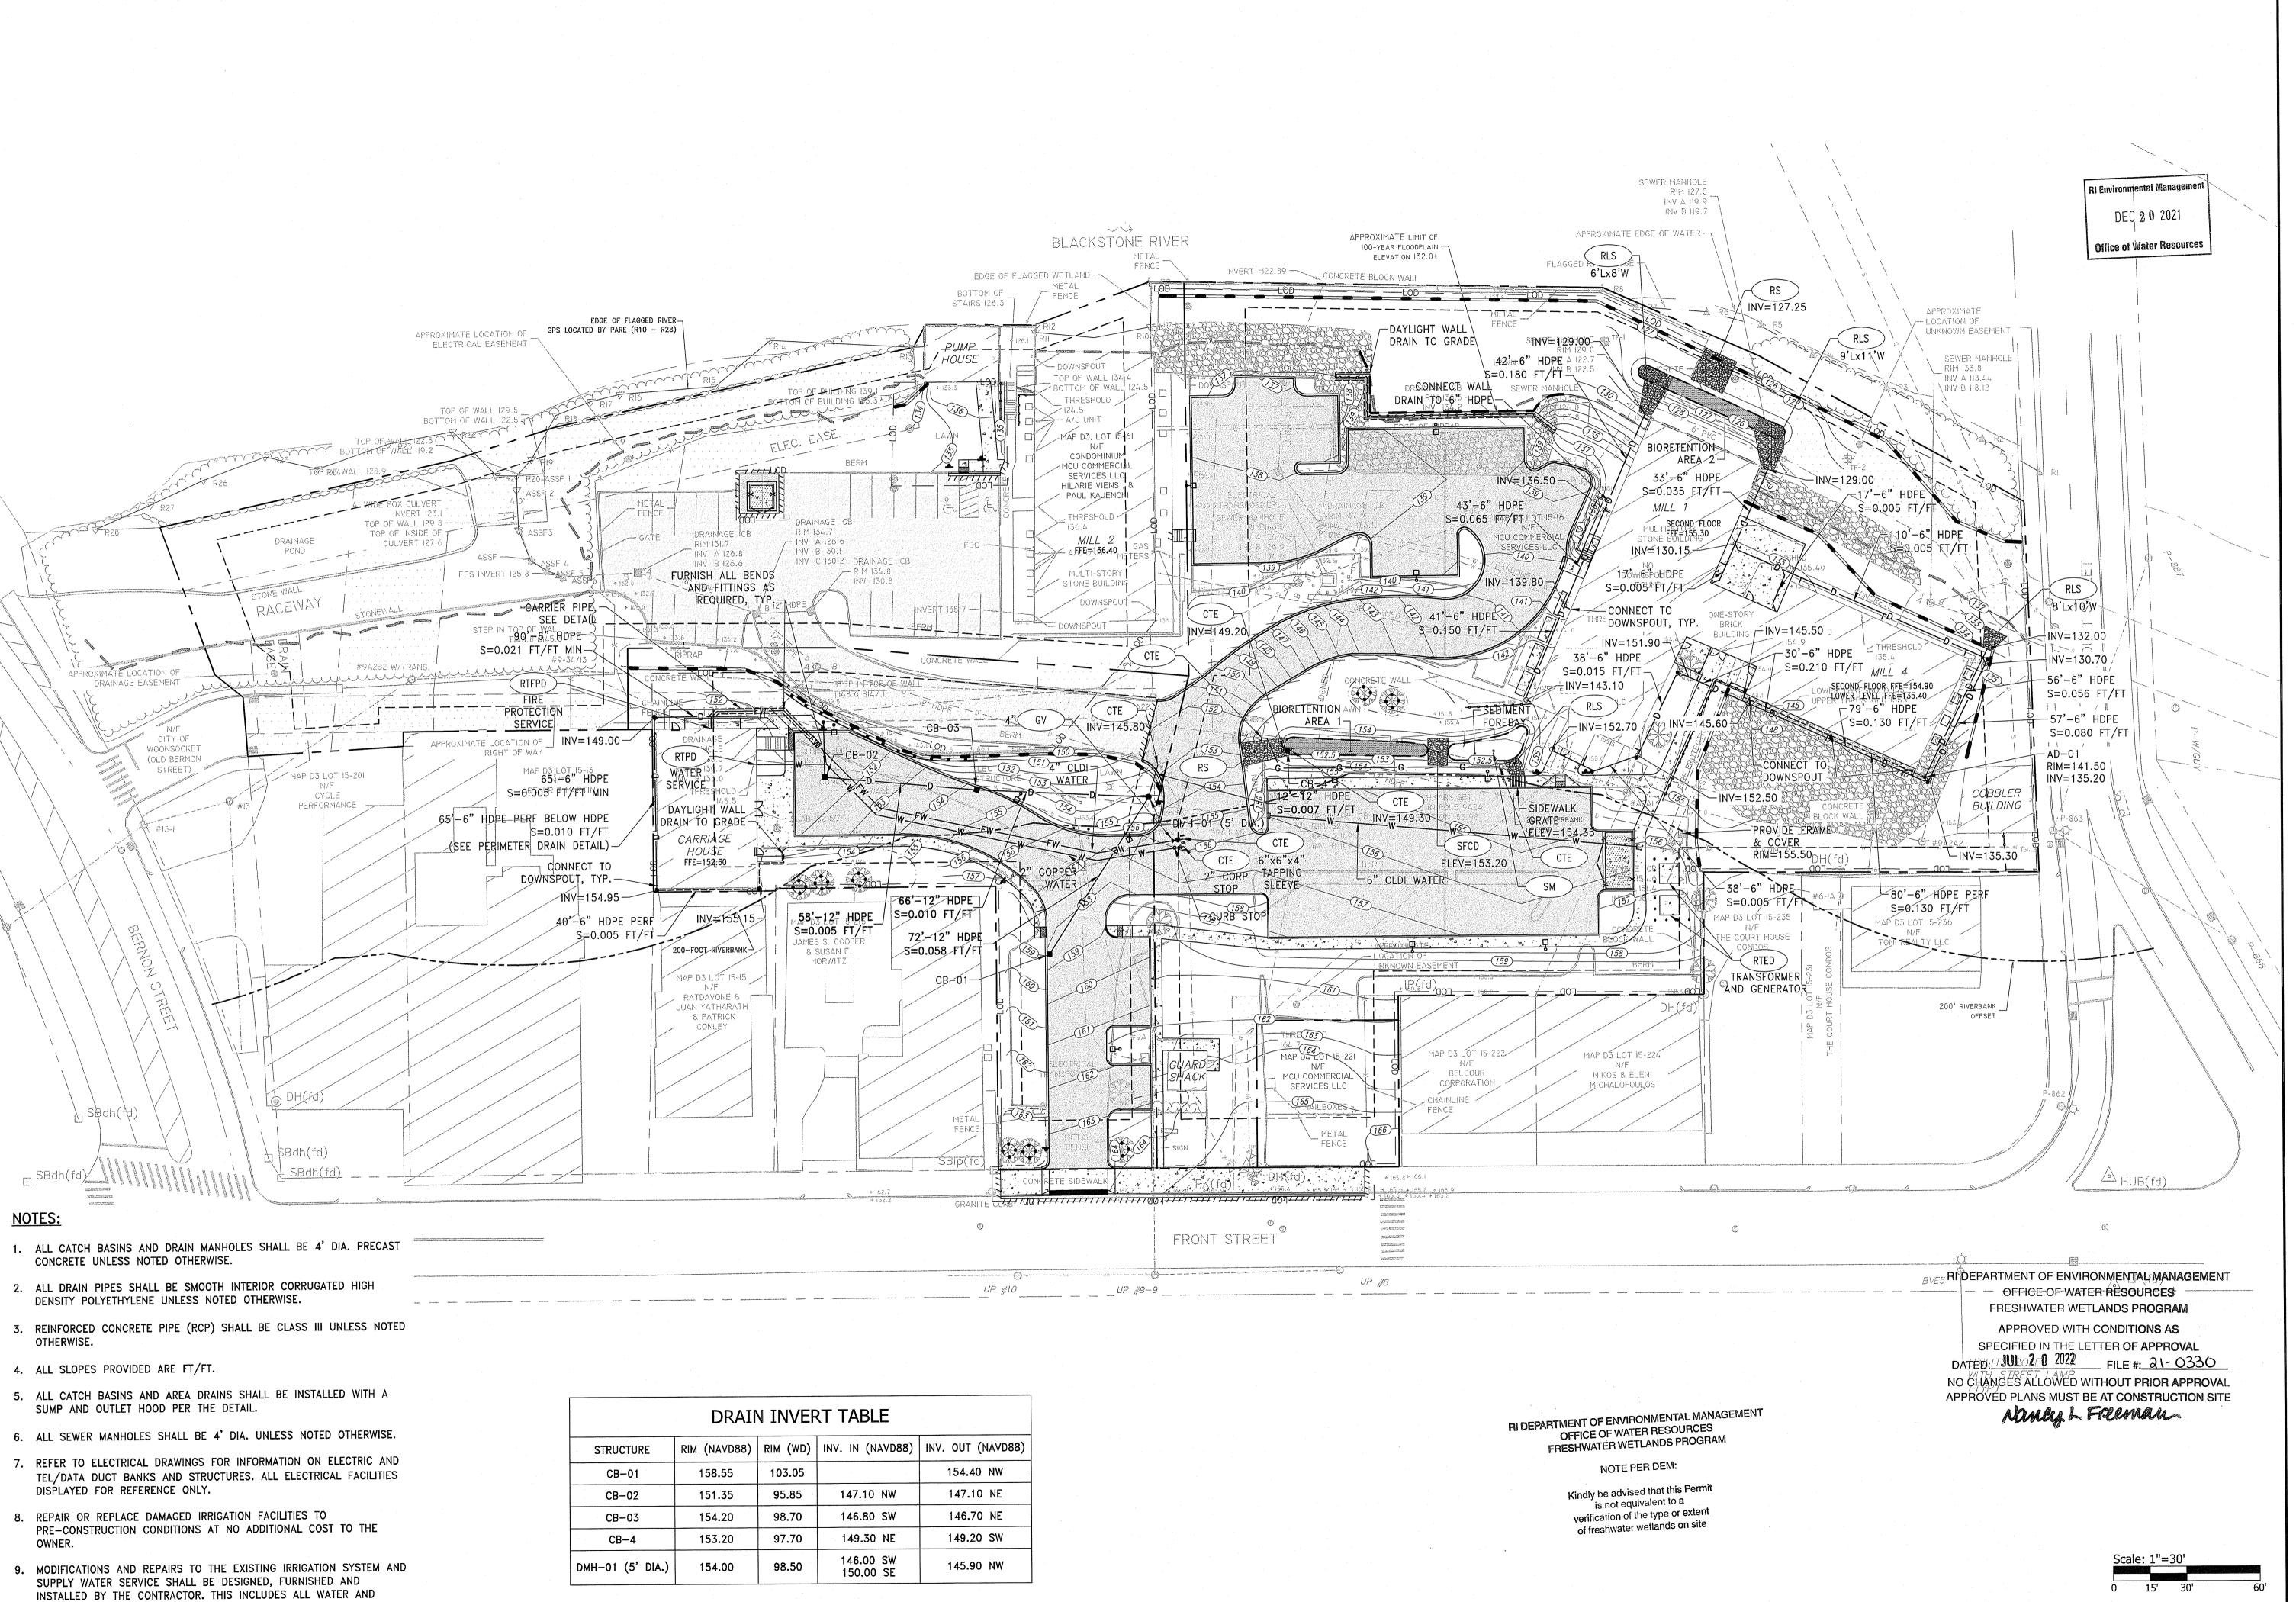

ELECTRICAL COMPONENTS INSTALLED PER MANUFACTURERS

10. REFER TO "CIVIL NOTES AND LEGEND" FOR ADDITIONAL NOTES.

RECOMMENDATIONS.



BRISA BERNON MILLS, LP. 119 FRONT STREET, #401 WOONSOCKET, RI 02895 APPLICANT: BRISA DEVELOPMENT, LLC 2009 FLATBUSH AVENUE

NEW YORK, NY 11234 SCALE ADJUSTMENT GUIDE

BAR IS ONE INCH ON ORIGINAL DRAWING

edevelopment

D3, (AP rnon Be

VICTORIA HOWLAND PROFESSIONAL ENGINEER (CIVIL)

REVISIONS:


21022.00 PROJECT NO.: DATE: DECEMBER 10, 2021 DESIGNED BY: CHECKED BY DRAWN BY: APPROVED BY:


> DRAINAGE & UTILITY PLAN 1


DRAWING NO.:

DRAWING TITLE:

C6.1 SHEET NO.

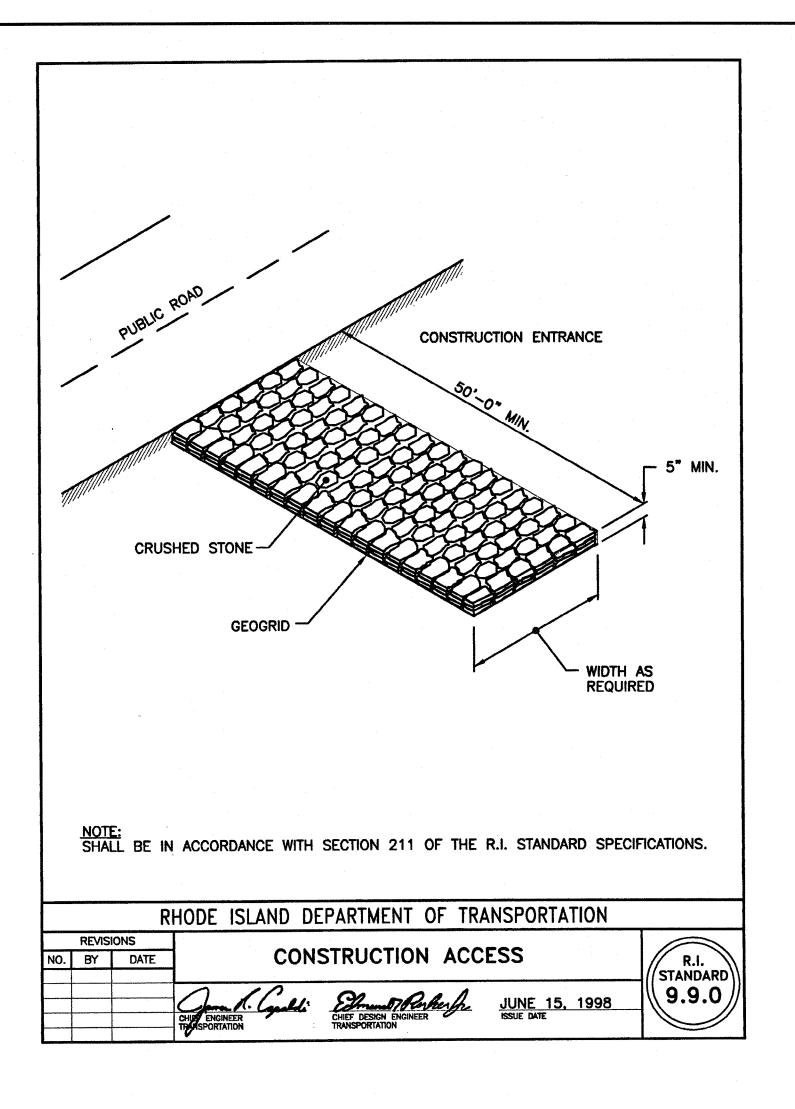


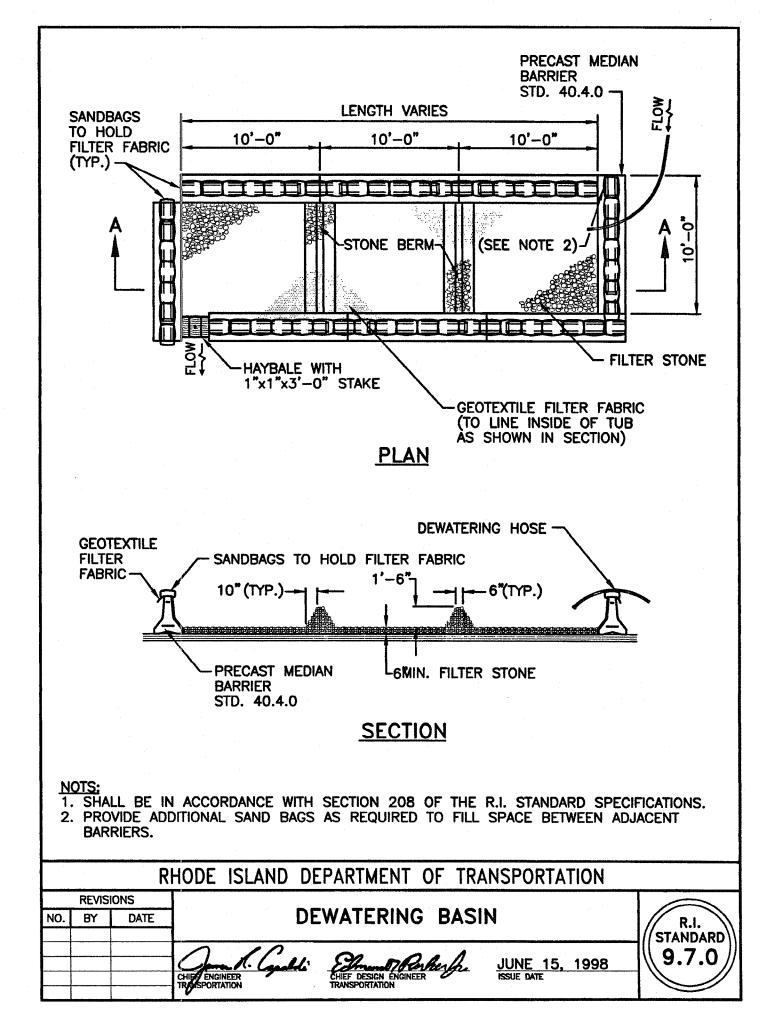

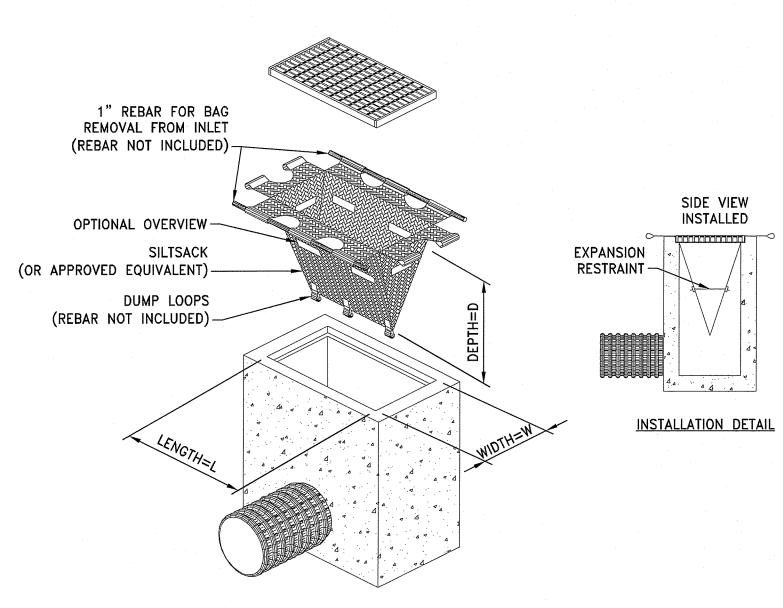

- 1. INLET PROTECTION SHALL BE CLEANED OF SILT AND DEBRIS ON A REGULAR BASIS AS REQUIRED BY PROJECT SPECIFIC SESC.
- 2. INSPECTIONS SHALL BE DONE AFTER EACH RAIN EVENT AND AT A MINIMUM EVERY TWO WEEKS AND AS REQUIRED BY PROJECT SPECIFIC SESC.


TEMPORARY INLET PROTECTION NOT TO SCALE

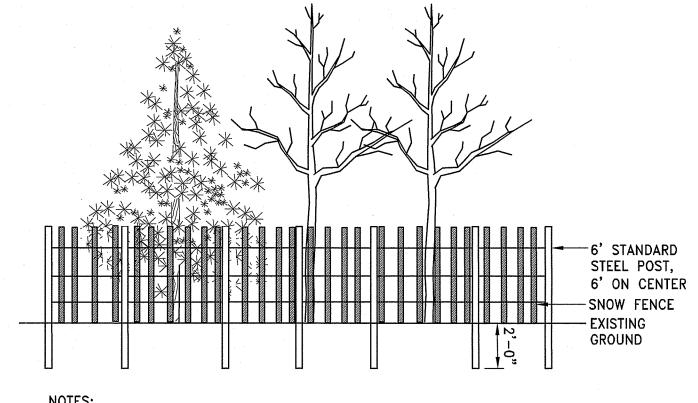


NOTES:

1. TREE GROUP PROTECTION SHALL BE INSTALLED AT THE DRIP LINE OF THE TREES TO BE PROTECTED.

TREE GROUP PROTECTION DETAIL NOT TO SCALE

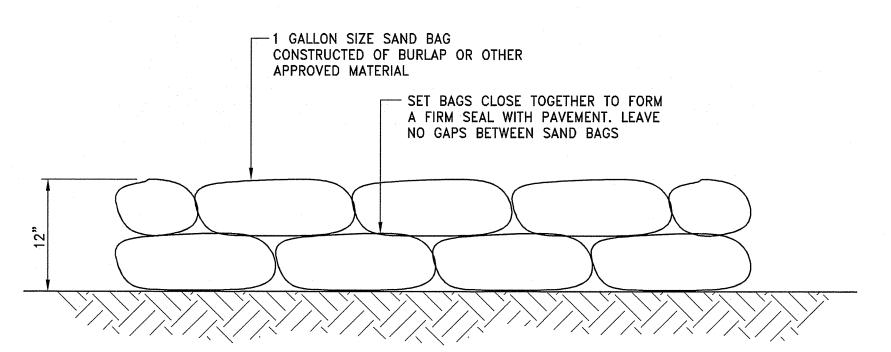


SAND BAG EROSION CONTROL BARRIER

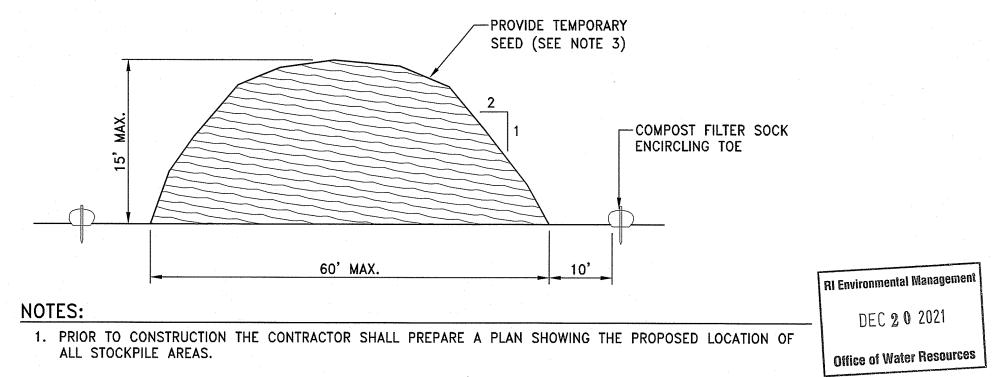

- 2. STOCKPILE AREA SHALL NOT EXCEED SPECIFIED DIMENSIONS WITHOUT APPROVAL FROM ENGINEER.
- 3. STOCKPILED ERODIBLE MATERIAL THAT WILL NOT BE USED FOR GREATER THAN 14 DAYS SHALL BE STABILIZED WITH TEMPORARY SEED IMMEDIATELY FOLLOWING PLACEMENT.
- 4. ALL ON-SITE COMMON BORROW SHALL BE STOCKPILED ON TOP OF, AND FULLY COVERED WITH, POLYETHYLENE SHEETING PER THE SITE ELUR.

ERODIBLE MATERIAL STOCKPILE NOT TO SCALE

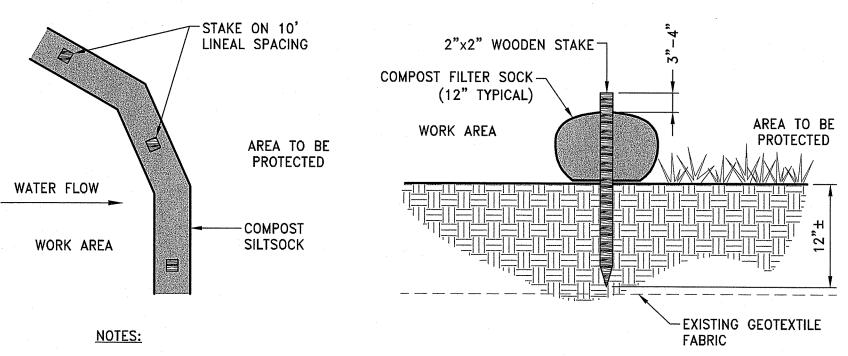


- 1. COMPOST/ SOIL/ ROCK/ SEED FILL TO MEET APPLICATION REQUIREMENTS.
- 2. COMPOST MATERIAL TO BE REMOVED OR DISPERSED ON SITE AS DETERMINED BY ENGINEER.
- 3. IF SOCK NETTING MUST BE JOINED, FIT BEGINNING OF NEW SOCK OVER END OF OLD SOCK, OVERLAPPING BY 2 FEET AND STACK OVERLAP. IF SOCK NETTING IS NOT JOINED. OVERLAP OLD SOCK WITH NEW ONE BY MINIMUM OF 2 FEET.



RIDEPARTMENT OF ENVIRONMENTAL MANAGEMENT OFFICE OF WATER RESOURCES FRESHWATER WETLANDS PROGRAM

APPROVED WITH CONDITIONS AS SPECIFIED IN THE LETTER OF APPROVAL DATED: JUL 2 0 2022 FILE #: 21-0330 NO CHANGES ALLOWED WITHOUT PRIOR APPROVA APPROVED PLANS MUST BE AT CONSTRUCTION SITE

NORMY L. FREMAN

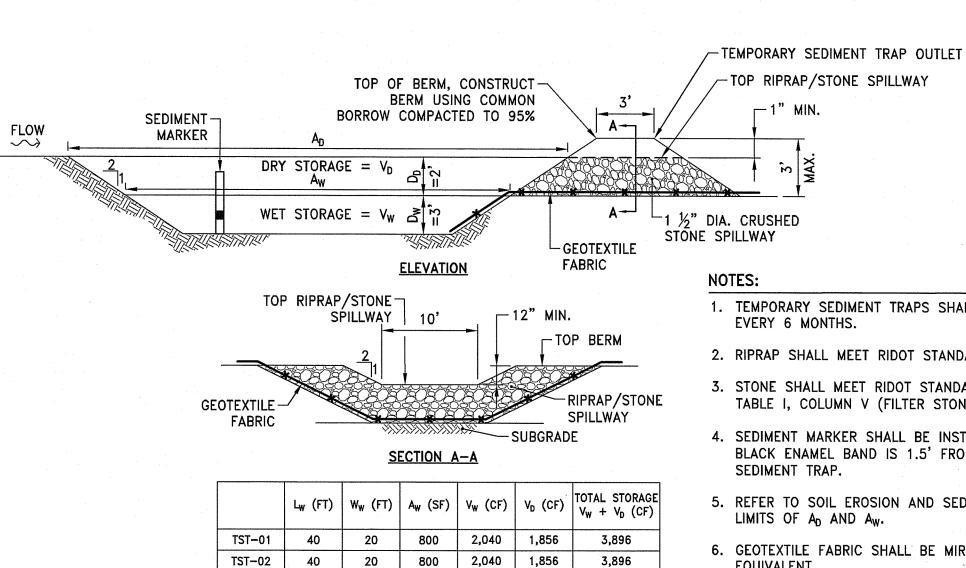

TEMPORARY SEDIMENT TRAP DETAIL

NOT TO SCALE

1. TEMPORARY SEDIMENT TRAPS SHALL BE CLEANED OR REMOVED

- 2. RIPRAP SHALL MEET RIDOT STANDARD SPECIFICATION M.10.03.2.
- 3. STONE SHALL MEET RIDOT STANDARD SPECIFICATION M.01.09 TABLE I, COLUMN V (FILTER STONE).
- 4. SEDIMENT MARKER SHALL BE INSTALLED SUCH THAT TOP OF BLACK ENAMEL BAND IS 1.5' FROM THE BOTTOM OF THE
- 5. REFER TO SOIL EROSION AND SEDIMENT CONTROL PLANS FOR LIMITS OF A_D AND A_W .
- 6. GEOTEXTILE FABRIC SHALL BE MIRAFI 140N OR APPROVED EQUIVALENT.

RI DEPARTMENT OF ENVIRONMENTAL MANAGEMENT OFFICE OF WATER RESOURCES FRESHWATER WETLANDS PROGRAM

NOTE PER DEM:

Kindly be advised that this Permit is not equivalent to a verification of the type or extent of freshauter wetlangs on site



BRISA BERNON MILLS, LP. 119 FRONT STREET, #401 WOONSOCKET, RI 02895 BRISA DEVELOPMENT, LLC 2009 FLATBUSH AVENUE

NEW YORK, NY 11234

SCALE ADJUSTMENT GUIDE

BAR IS ONE INCH ON ORIGINAL DRAWING

Redevelopmen Ber

VICTORIA HOWLAND PROFESSIONAL ENGINEER (CIVIL)


RE	EVISIONS:		
			_
			_
			_
			_
		-	_
			_
		·	
PF	ROJECT NO.	: 21022.00	
D/	ATE: DE	ECEMBER 10, 2021	
SC	CALE:	NOT TO SCALE	
DE	ESIGNED BY	: KM	
Cŀ	HECKED BY:	VAH	_
DF	RAWN BY:	AKL	
ΑF	PROVED BY	Y: VAH	
DF	RAWING TIT	LE:	_


DETAILS 1


10 OF 18


DRAWING NO.:


SHEET NO.

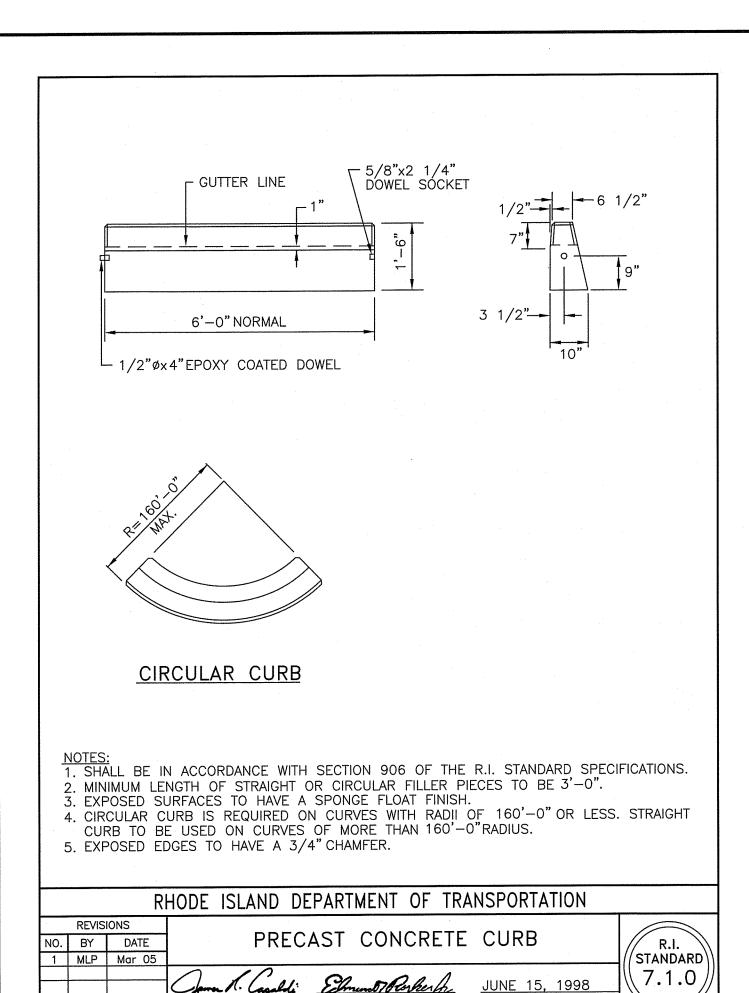


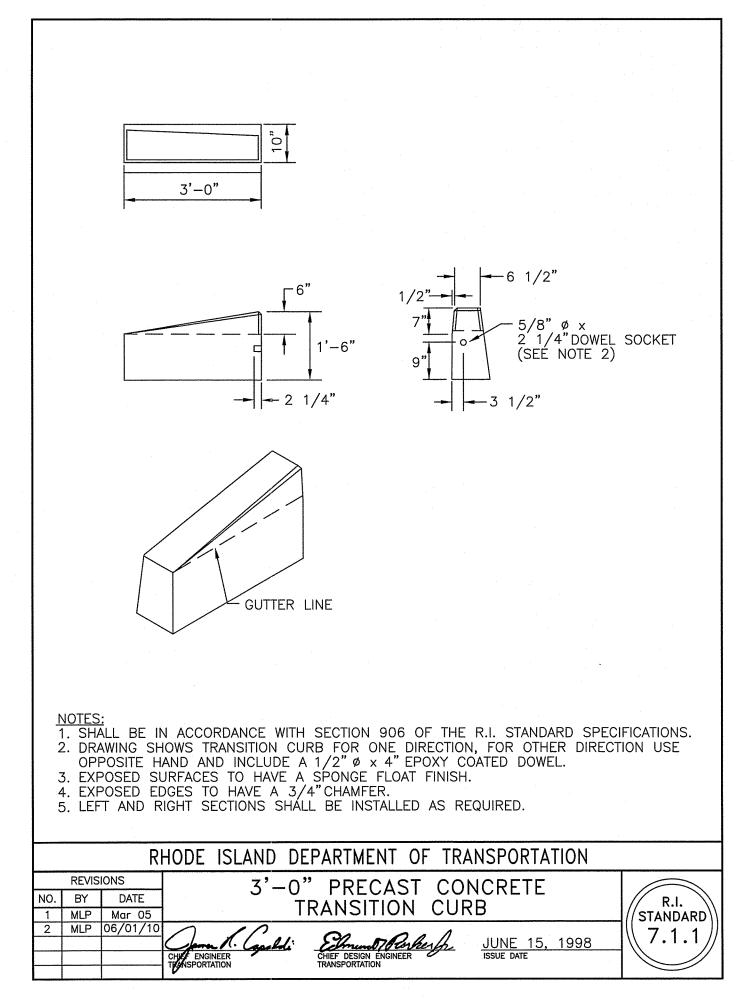

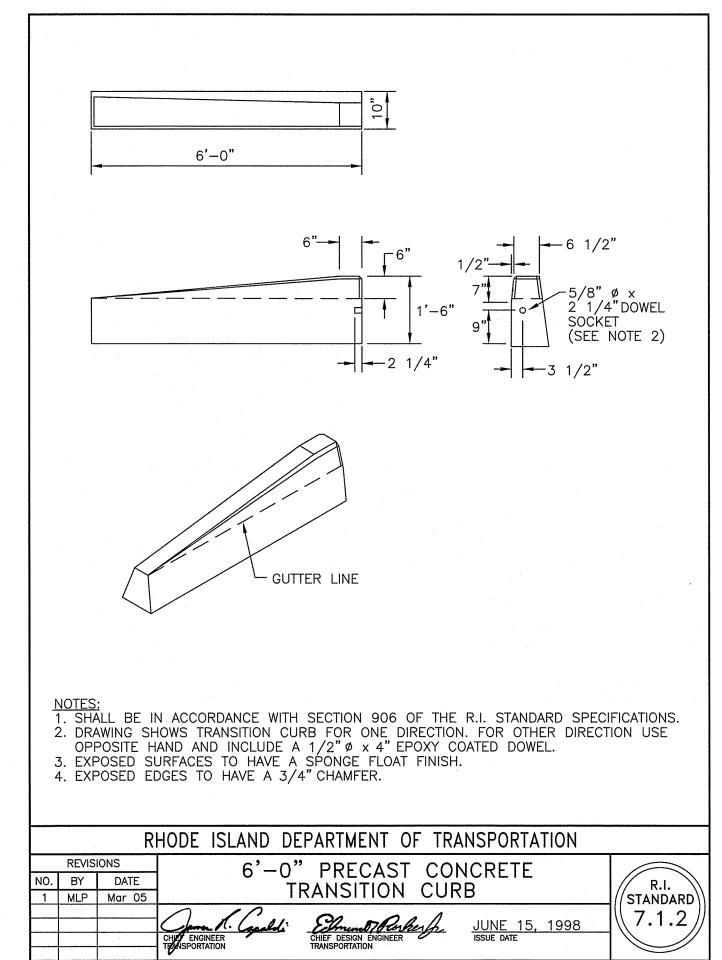


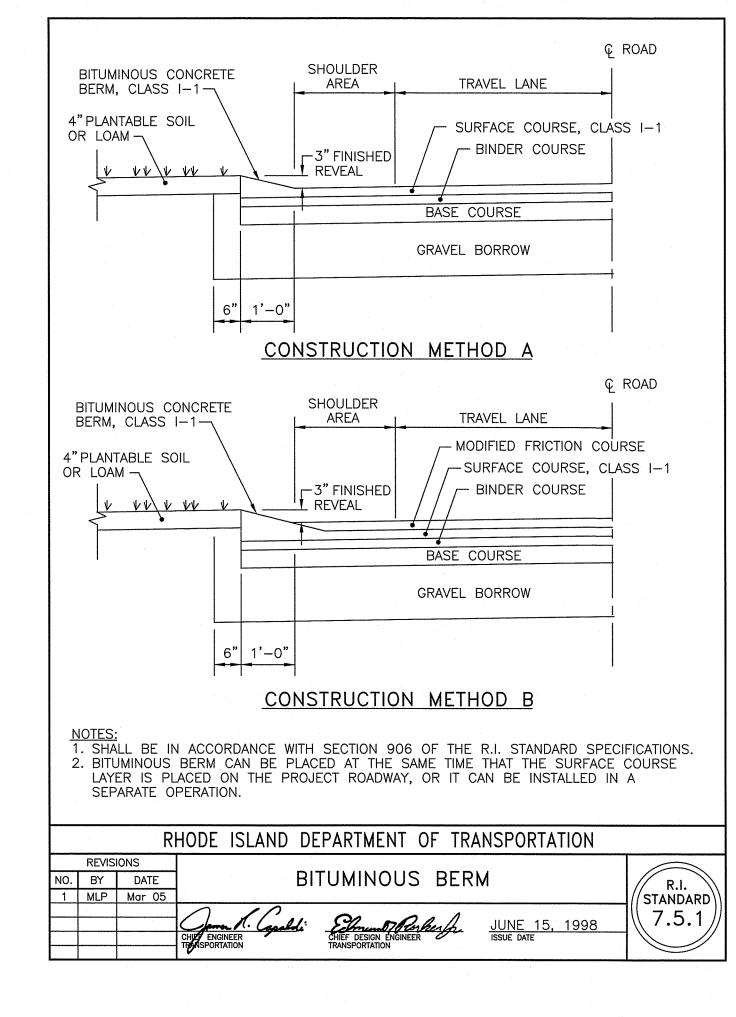

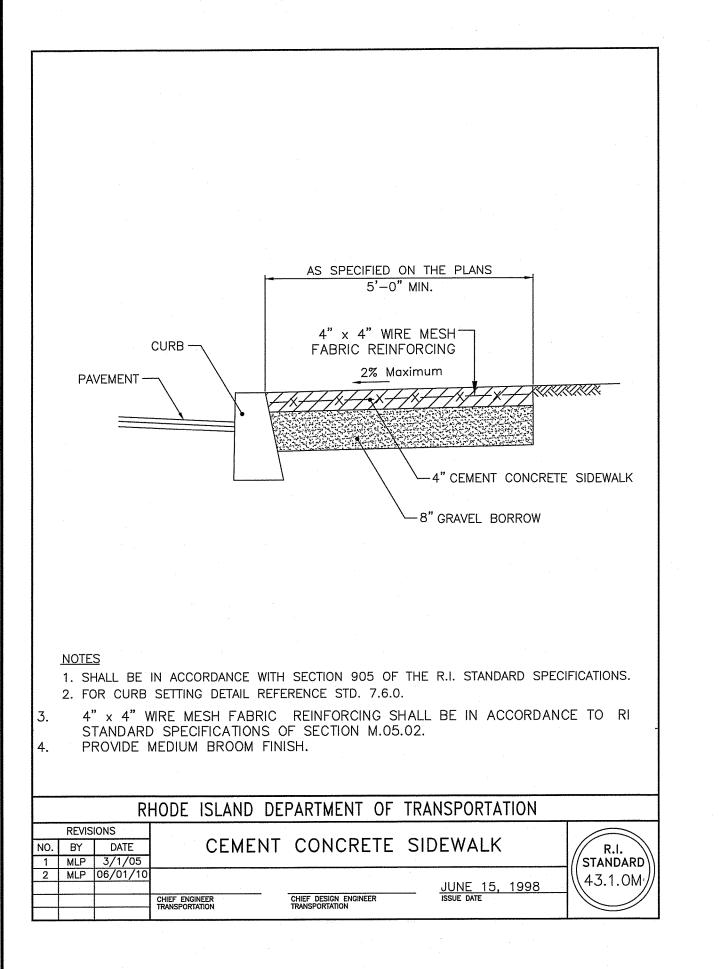


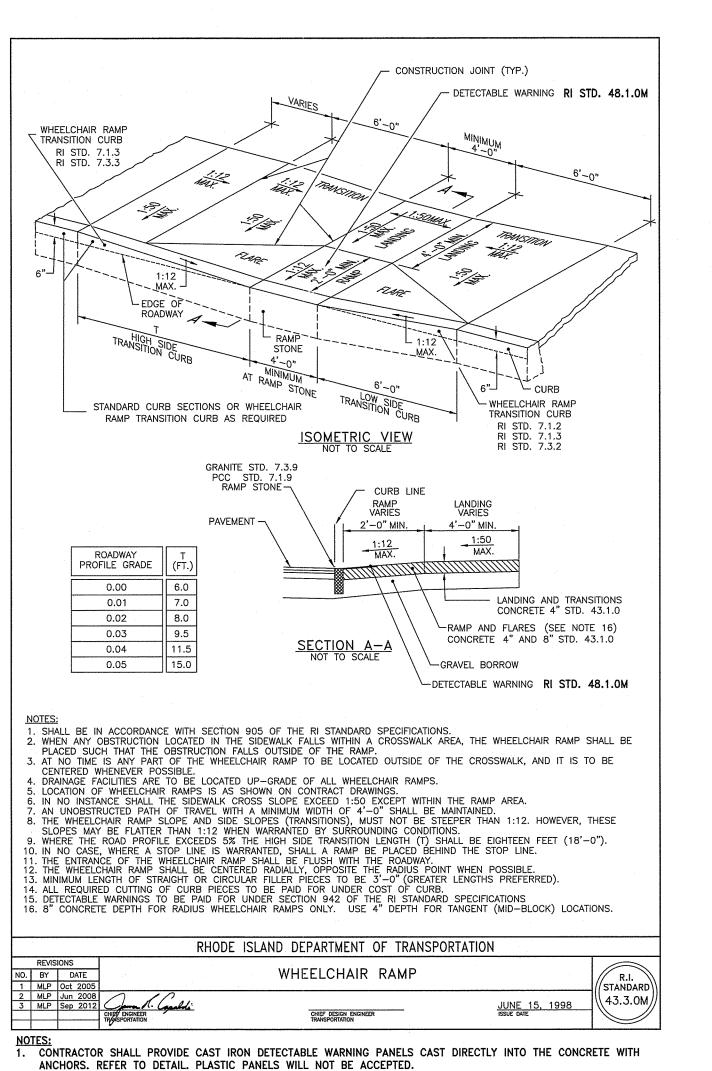



2. PROVIDE R.I. STD. 43.1.0M. SEE DETAIL.

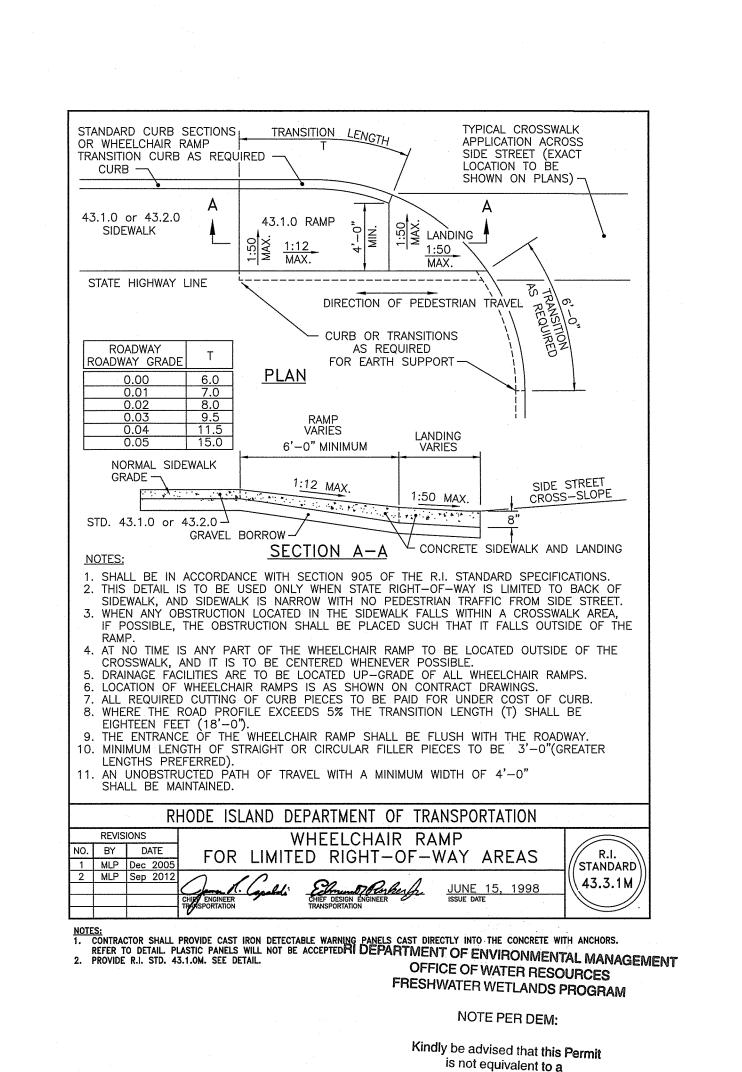

verification of the type or extent of freshwater wetlands on site

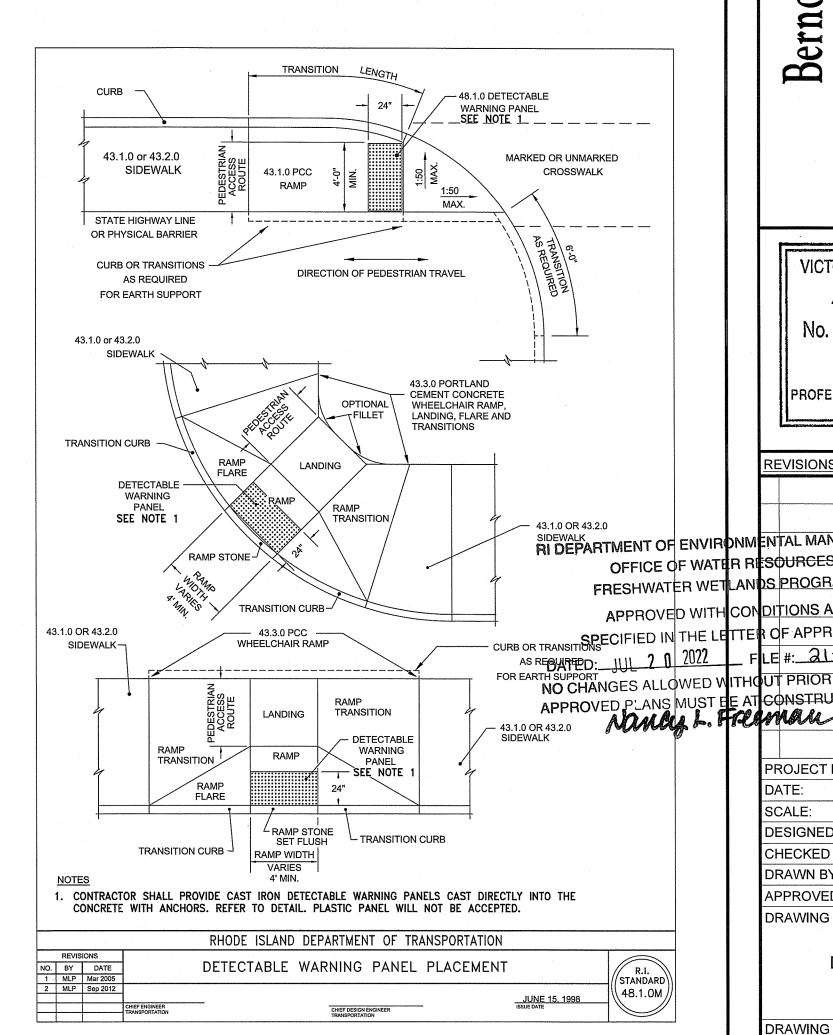

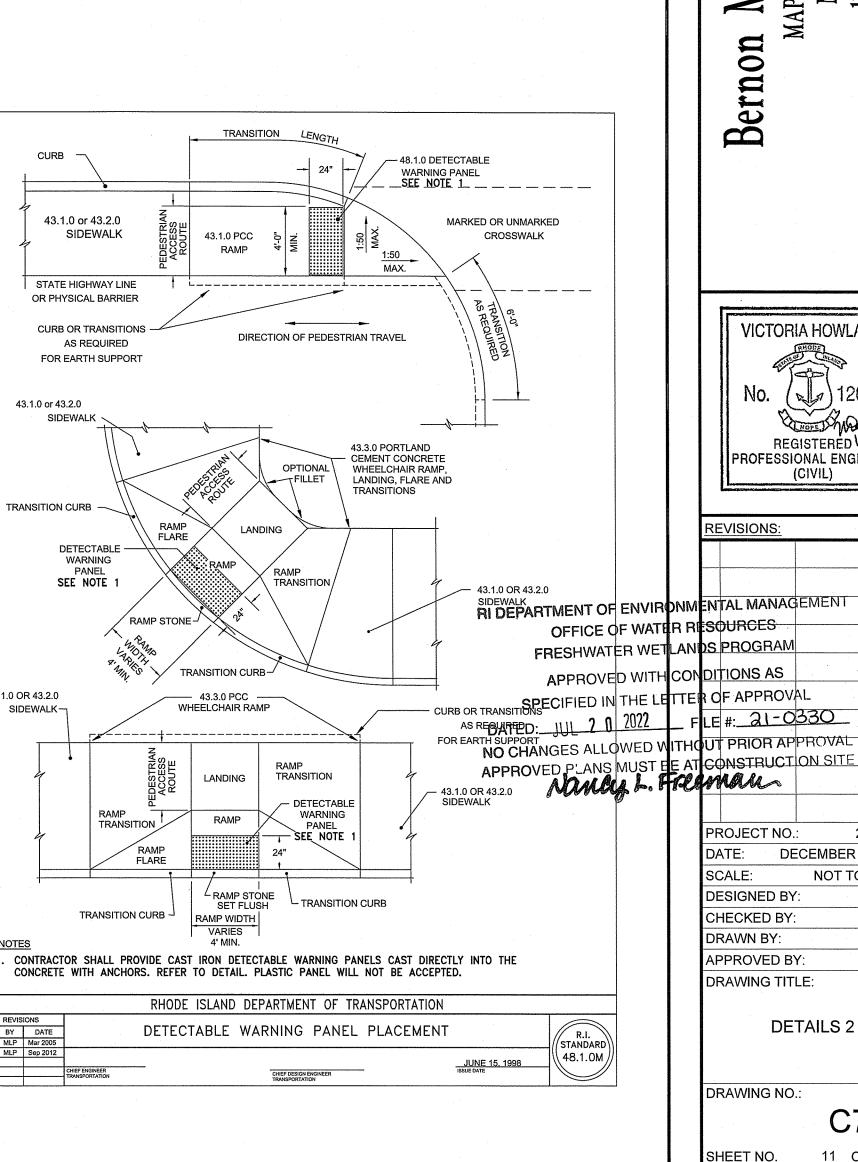

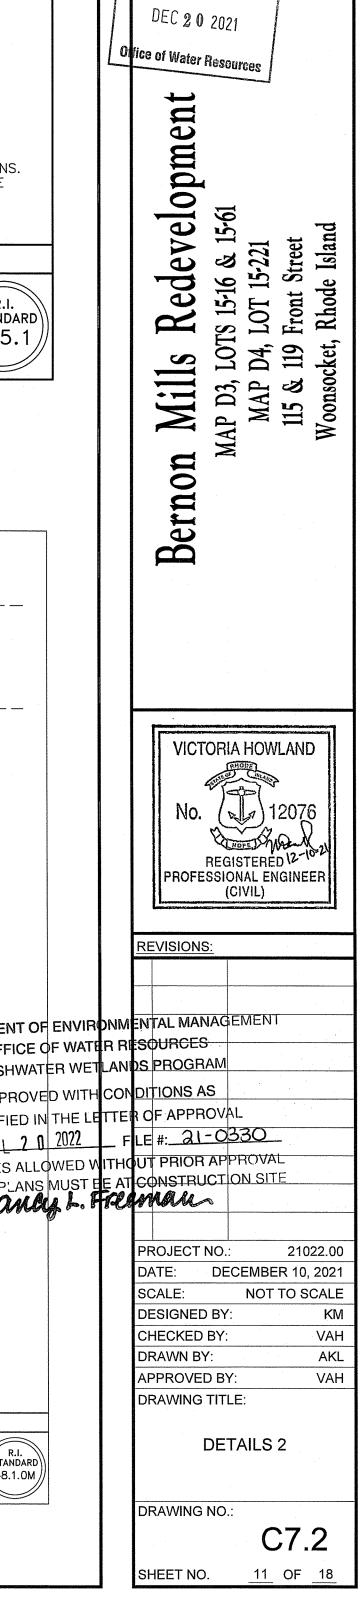

PARE

PARE CORPORATION

ENGINEERS - SCIENTISTS - PLANNERS 8 BLACKSTONE VALLEY PLACE

LINCOLN, RI 02865

401-334-4100

BRISA BERNON MILLS LP.

119 FRONT STREET, #401 WOONSOCKET, RI 02895

BRISA DEVELOPMENT, LLC

SCALE ADJUSTMENT GUIDE

BAR IS ONE INCH ON ORIGINAL DRAWING


.nvironmental Managemer

2009 FLATBUSH AVENUE

NEW YORK, NY 11234

OWNER:

APPLICANT

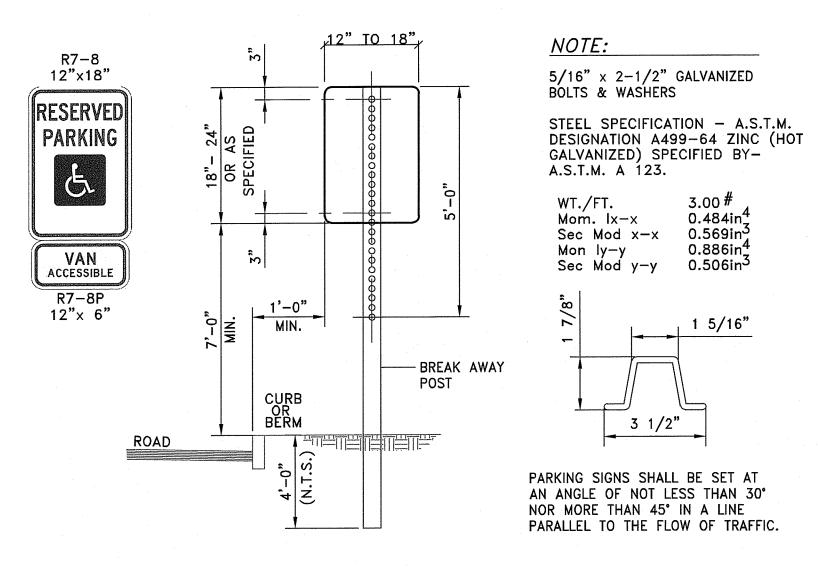

- 1. ALL LAG SCREWS, BOLTS AND WASHERS SHALL BE GALVANIZED 5/16"x2 1/2" LONG UNLESS OTHERWISE
- 2. WASHERS SHALL BE 0.07" THICK.
- 3. ALL SIGN COLORS, RADII AND BORDERS AS SPECIFIED IN "MANUAL ON UNIFORM TRAFFIC CONTROL DEVICES."
- 4. SHALL BE IN ACCORDANCE WITH SECTION T.15 OF THE STANDARD SPECIFICATIONS.
- 5. PARKING SIGNS SHALL BE SET AT AN ANGLE OF NOT LESS THAN 30° NOT MORE THAN 45° WITH A LINE PARALLEL TO FLOW OF TRAFFIC, 1'-6" (1'-0" MIN.) FROM THE EDGE OF CURB FACE.
- 6. ALL ACCESSIBLE PARKING AND SIGNAGE SHALL BE IN CONFORMANCE WITH THE RULES & REGULATIONS AS SPECIFIED BY THE AMERICAN DISABILITIES ACT (ADA).
- 7. SIGN(S) SHALL BE LOCATED SO THEY CANNOT BE OBSCURED BY A VEHICLE PARKED IN THE SPACE.
- 8. FOR ACCESSIBLE VAN SPACE USE SIGN AS DETAILED.
- 9. FOR ACCESSIBLE SPACE FOR AUTOMOBILES USE ONLY ACCESSIBLE PARKING SIGN.


ACCESSIBLE SIGN MOUNTING NOT TO SCALE

LEGEND	DESIGNATION	SIZE
STOP	R1-1	(30" x 30")
RESERVED PARKING	R7-8	(12" x 18")
VAN	R7-8P	(12" x 6")

- 1. SIGNS SHALL BE CONSTRUCTED OF TYPE III REFLECTORIZED SHEETING AND IN ACCORDANCE WITH MUTCD REQUIREMENTS, LATEST REVISION.
- 2. THE CONTRACTOR SHALL SUBMIT SAMPLE SIGNS TO THE OWNER FOR APPROVAL PRIOR TO FURNISHING.
- 3. LETTERS, COLOR, AND FONT FOR NON-STANDARD SIGNS SHALL BE SELECTED BY THE OWNER.
- 4. ALL SIGN MOUNTING SHALL CONFORM TO R.I. STD. DETAIL 24.2.0 EXCEPT R7-8 AND R7-8P. R7-8 AND R7-8P SHALL CONFORM

TO ACCESSIBLE SIGN MOUNTING DETAIL.

SIGN SCHEDULE

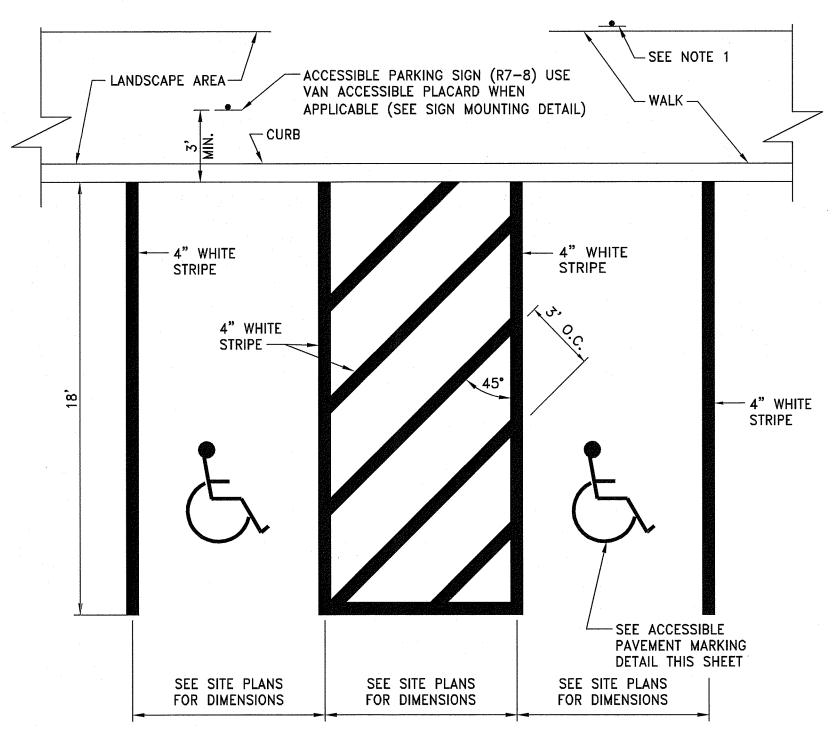


1. WHERE STALLS ABUT SIDEWALK, PARKING SIGNS SHOULD BE PLACED AT BACK EDGE OF SIDEWALK, UNLESS NOTED OTHERWISE.

2. ALL PAVEMENT MARKINGS TO BE EPOXY RESIN.

ACCESSIBLE PARKING STALLS @ 90°


NOT TO SCALE

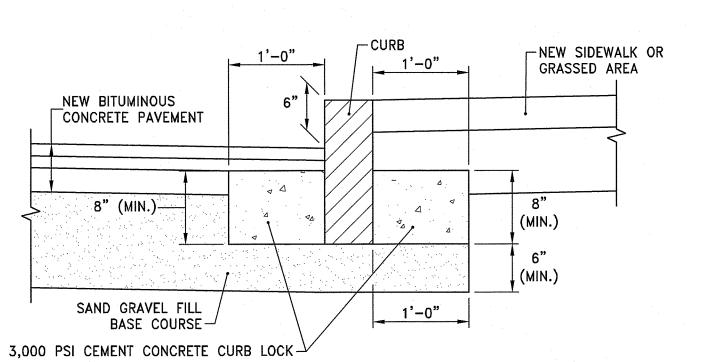


NOTES:


1. SHALL BE IN ACCORDANCE WITH SECTION 906 OF THE R.I. STANDARD SPECIFICATIONS. 2. PROVIDE CEMENT CONCRETE CURB LOCK ON ALL CURBS

CURB SETTING DETAIL NOT TO SCALE

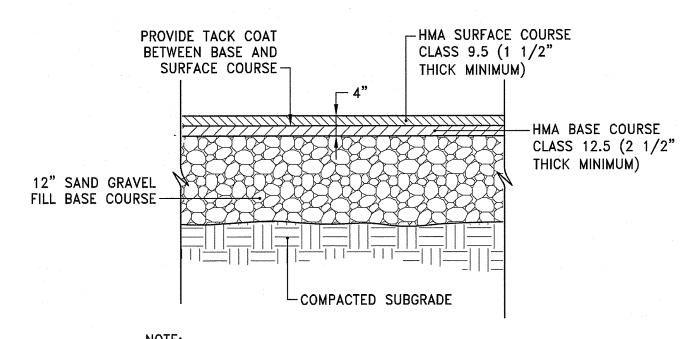


1. SUBMIT JOB MIX FORMULAS TO ENGINEER FOR APPROVAL PRIOR TO PLACEMENT.

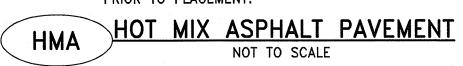


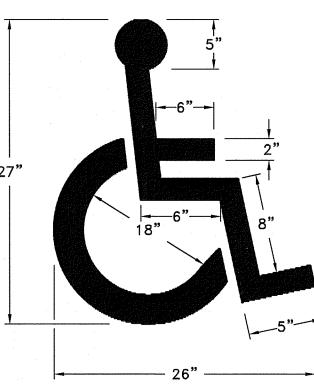

ACCESSIBLE PARKING AND SIGNAGE SHALL BE IN CONFORMANCE WITH THE RULES & REGULATIONS OF THE AMERICANS WITH DISABILITIES ACT.




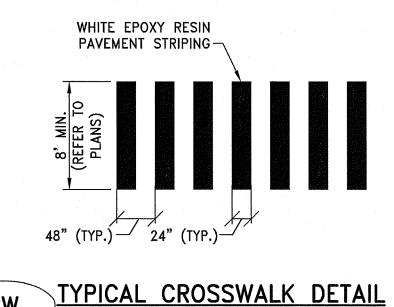

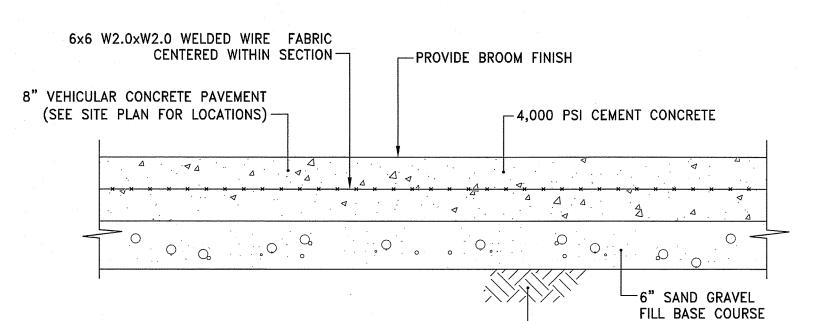

VEHICULAR CONCRETE PAVEMENT DETAIL

95% COMPACTED SUBGRADE —

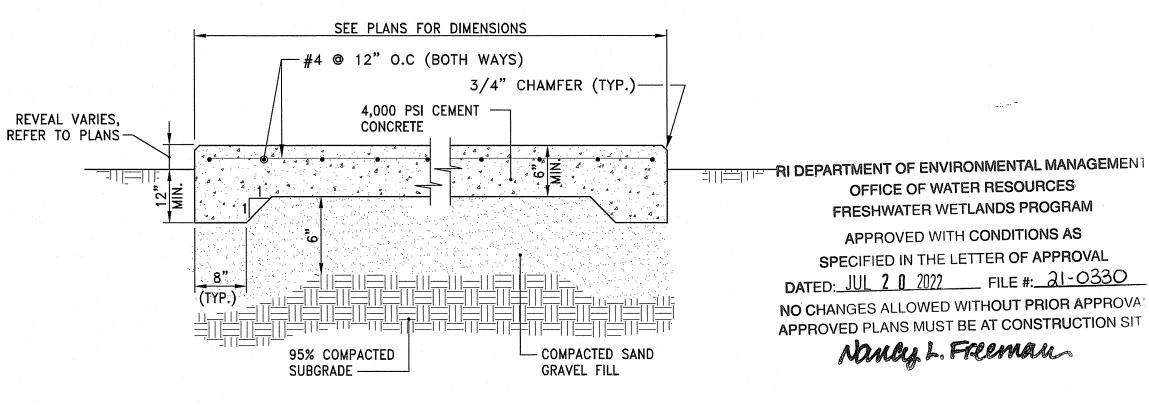

NOTES:

- 1. REINFORCING TO BE #4 GRADE 60 BARS AND SHALL CONFORM TO ASTM STANDARD A-615 OF THE LATEST DATA. REINFORCING RODS TO BE LOCATED IN THE CENTER OF THE SLAB, WITH A MINIMUM OF 2" CLEARANCE FROM FACE OF CONCRETE.
- 2. CONTRACTOR SHALL COORDINATE LOCATIONS OF OPENINGS, FENCE POSTS, OR OTHER FEATURES IN SLAB.

CEMENT CONCRETE PAD



OWNER: BRISA BERNON MILLS, LP. 119 FRONT STREET, #401 WOONSOCKET, RI 02895 APPLICANT:

BRISA DEVELOPMENT, LLC 2009 FLATBUSH AVENUE NEW YORK, NY 11234

RI Environmental Managemen

DEC 20 2021


Office of Water Resources

SCALE ADJUSTMENT GUIDE BAR IS ONE INCH ON

ORIGINAL DRAWING

Redevelopment Mill P D3, MAP 115 &

ğ

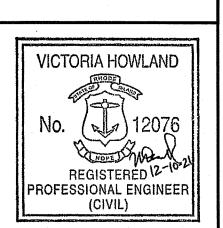

L		
	REVISIONS:	
I		
Ì		
Transmit compa		
Ì		ANALISE PARAMETER ANALISM AND
Maria Caracteristics of the Caracteristics o		i i voida por viinnimassa.
I		
I		
	PROJECT NO.:	21022.00
	DATE: DEC	DEMBER 10, 2021
	SCALE:	NOT TO SCALE
	DESIGNED BY:	KM
	CHECKED BY:	VAH
I	DRAWN BY:	AKL
	APPROVED BY:	: VAH

NOTE PER DEM: Kindly be advised that this Permit is not equivalent to a verification of the type or extent of freshwater wetlands on site

OFFICE OF WATER RESOURCES

FRESHWATER WETLANDS PROGRAM

APPROVED WITH CONDITIONS AS

SPECIFIED IN THE LETTER OF APPROVAL

DATED: JUL 2 0 2022 FILE #: 21-0330

NO CHANGES ALLOWED WITHOUT PRIOR APPROVA:

APPROVED PLANS MUST BE AT CONSTRUCTION SIT

May L. Freman

RI DEPARTMENT OF ENVIRONMENTAL MANAGEMENT


OFFICE OF WATER RESOURCES
FRESHWATER WETLANDS PROGRAM


DETAILS 3


DRAWING TITLE:

DRAWING NO.:


SHEET NO. 12 OF 18

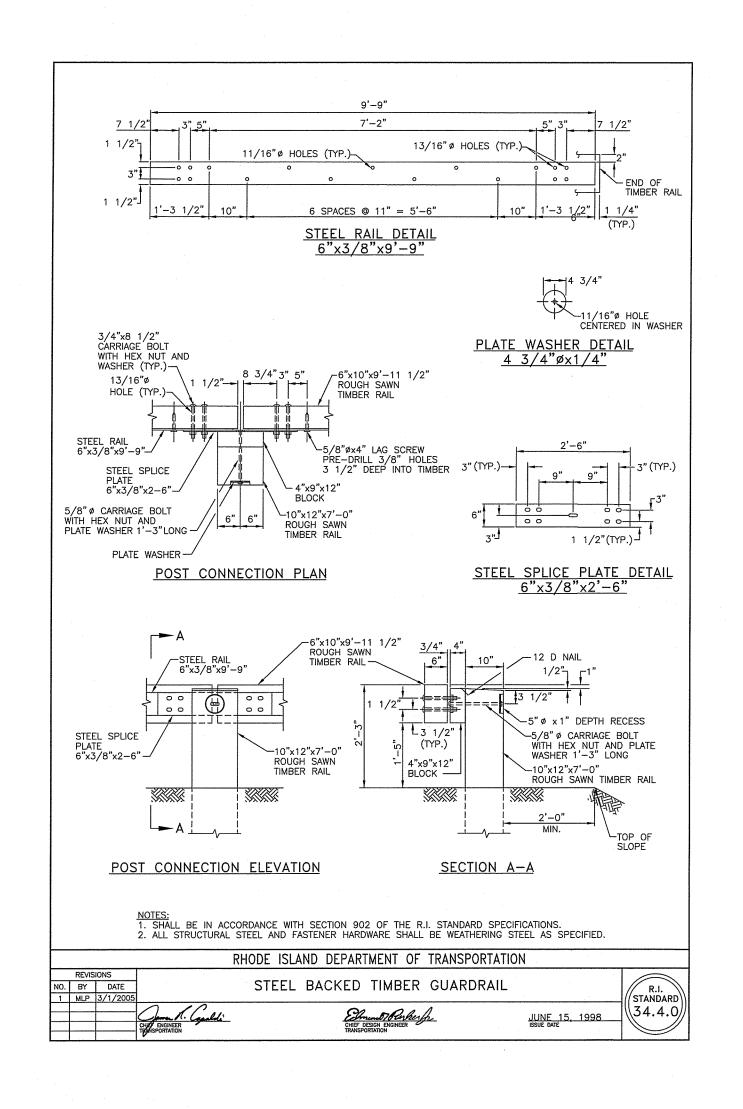


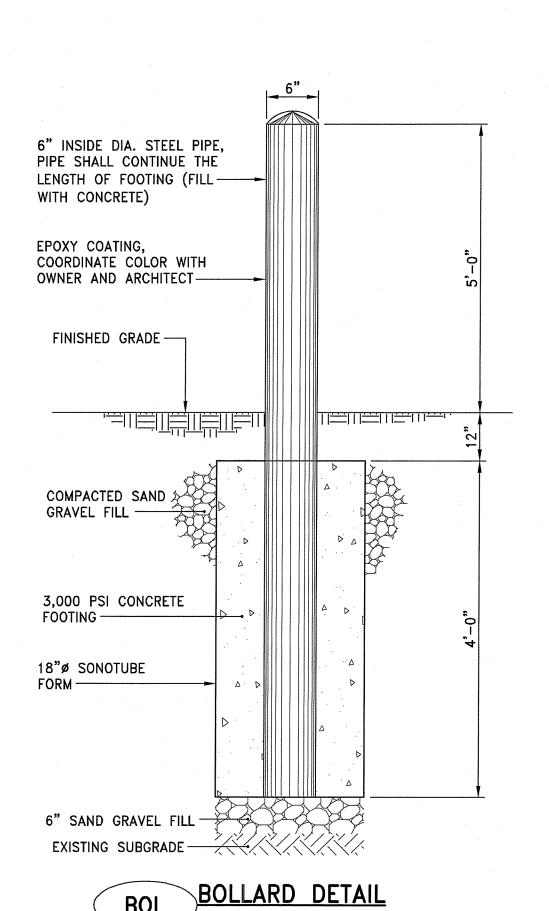

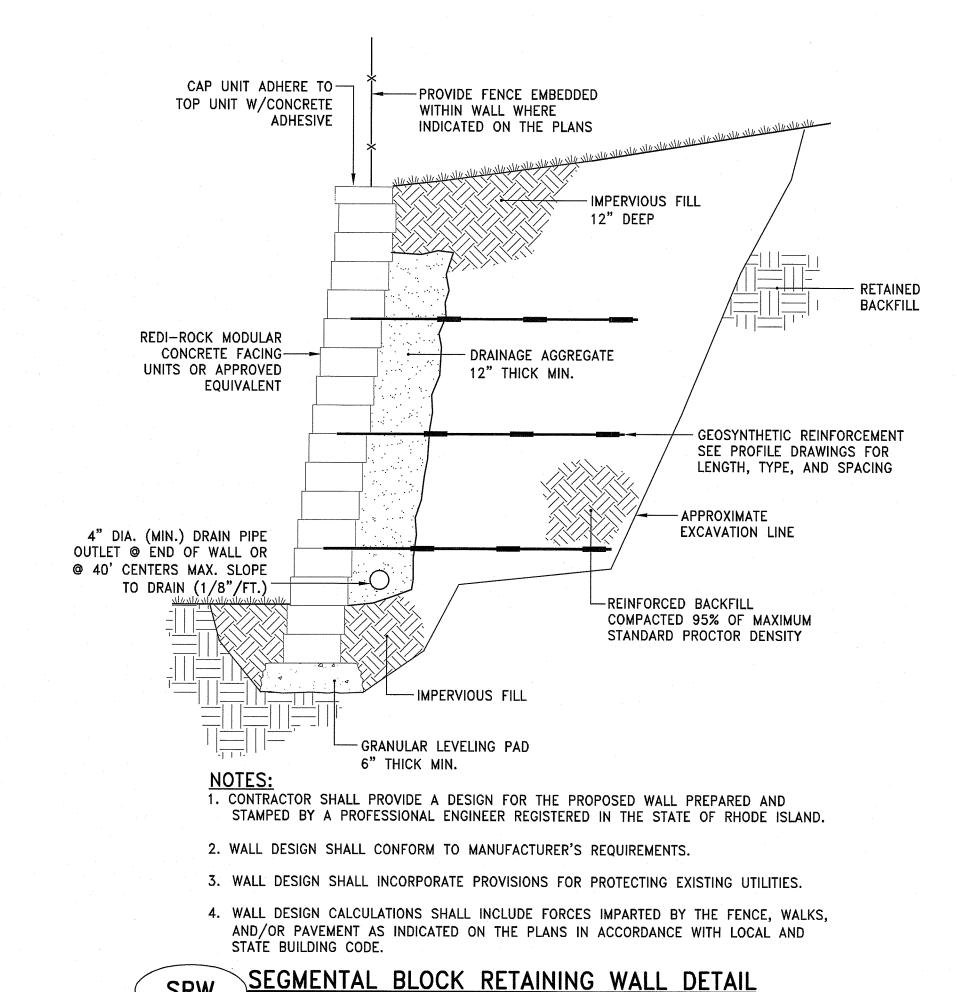

NOT TO SCALE

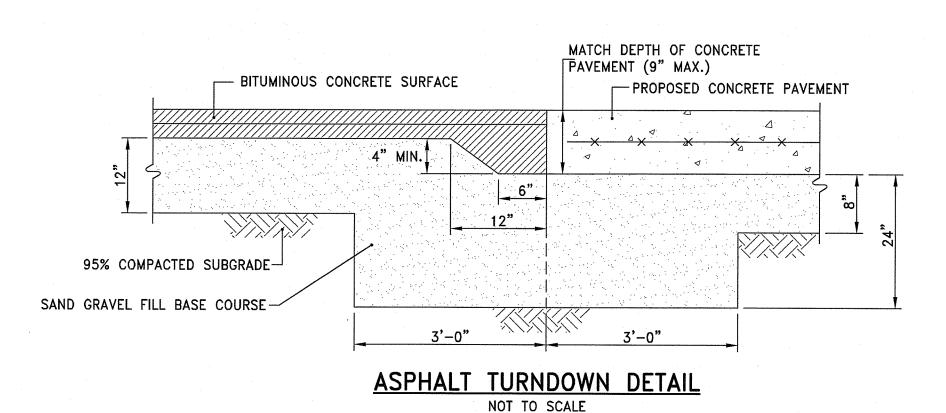

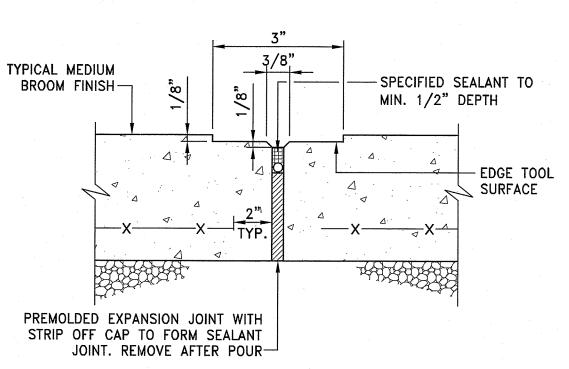

EXPANSION JOINT AT 20' O.C. (TYP)


1. EXPANSION JOINTS (E.J.) 20 FEET O.C. UNLESS

OTHERWISE NOTED.

2. CONTROL JOINTS (C.J.) 5 FEET O.C. UNLESS OTHERWISE

3. WHERE EXISTING AND NEW CONCRETE SIDEWALKS MEET, SAWCUT EXISTING WALK AND INSTALL EXPANSION JOINT AND DOWELS AS SHOWN. DRILL EXISTING CONCRETE WALK EDGE TO RECEIVE STEEL DOWELS AT EXPANSION

4. REFER TO LANDSCAPE PLANS FOR LOCATIONS.

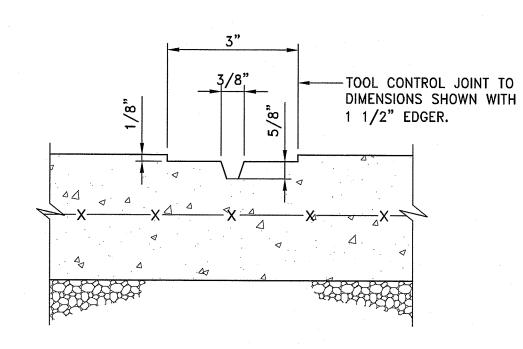

CONTROL JOINT AT 5' O.C. (TYP)

EXPANSION AND CONTROL JOINTS FOR SIDEWALK PAVING

Office of Water Resources

RI Environmental Managemen DEC 20 2021

> Redevelopmen non

Ber

PARE CORPORATION

8 BLACKSTONE VALLEY PLACE

ENGINEERS - SCIENTISTS - PLANNERS

LINCOLN, RI 02865

401-334-4100

BRISA BERNON MILLS, LP.

BRISA DEVELOPMENT, LLC

SCALE ADJUSTMENT GUIDE

BAR IS ONE INCH ON

ORIGINAL DRAWING

2009 FLATBUSH AVENUE

NEW YORK, NY 11234

119 FRONT STREET, #401 WOONSOCKET, RI 02895

OWNER:

APPLICANT:

VICTORIA HOWLAND
No. 12076
REGISTERED 12-10-21
PROFESSIONAL ENGINEER (CIVIL)

REVISIONS:	
	,
	·
	·
PROJECT NO.	: 21022.00
DATE: DE	ECEMBER 10, 2021
SCALE:	NOT TO SCALE
DESIGNED BY	: KM
CHECKED BY:	VAH
DRAWN BY:	AKL
APPROVED BY	
DRAWING TIT	

DETAILS 4

SHEET NO. 13 OF 18

C7.4

DRAWING NO.:

RI DEPARTMENT OF ENVIRONMENTAL MANAGEMENT
OFFICE OF WATER RESOURCES

FRESHWATER WETLANDS PROGRAM

RI DEPARTMENT OF ENVIRONMENTAL MANAGEMENT OFFICE OF WATER RESOURCES FRESHWATER WETLANDS PROGRAM

APPROVED WITH CONDITIONS AS

SPECIFIED IN THE LETTER OF APPROVAL

DATED: 101 2 0 2022 FILE #: 21-0330


NO CHANGES ALLOWED WITHOUT PRIOR APPROVAL


APPROVED PLANS MUST BE AT CONSTRUCTION SITE


Nauly L. Freeman


NOTE PER DEM:


Kindly be advised that this Permit is not equivalent to a verification of the type or extent of freshwater wetlands on site

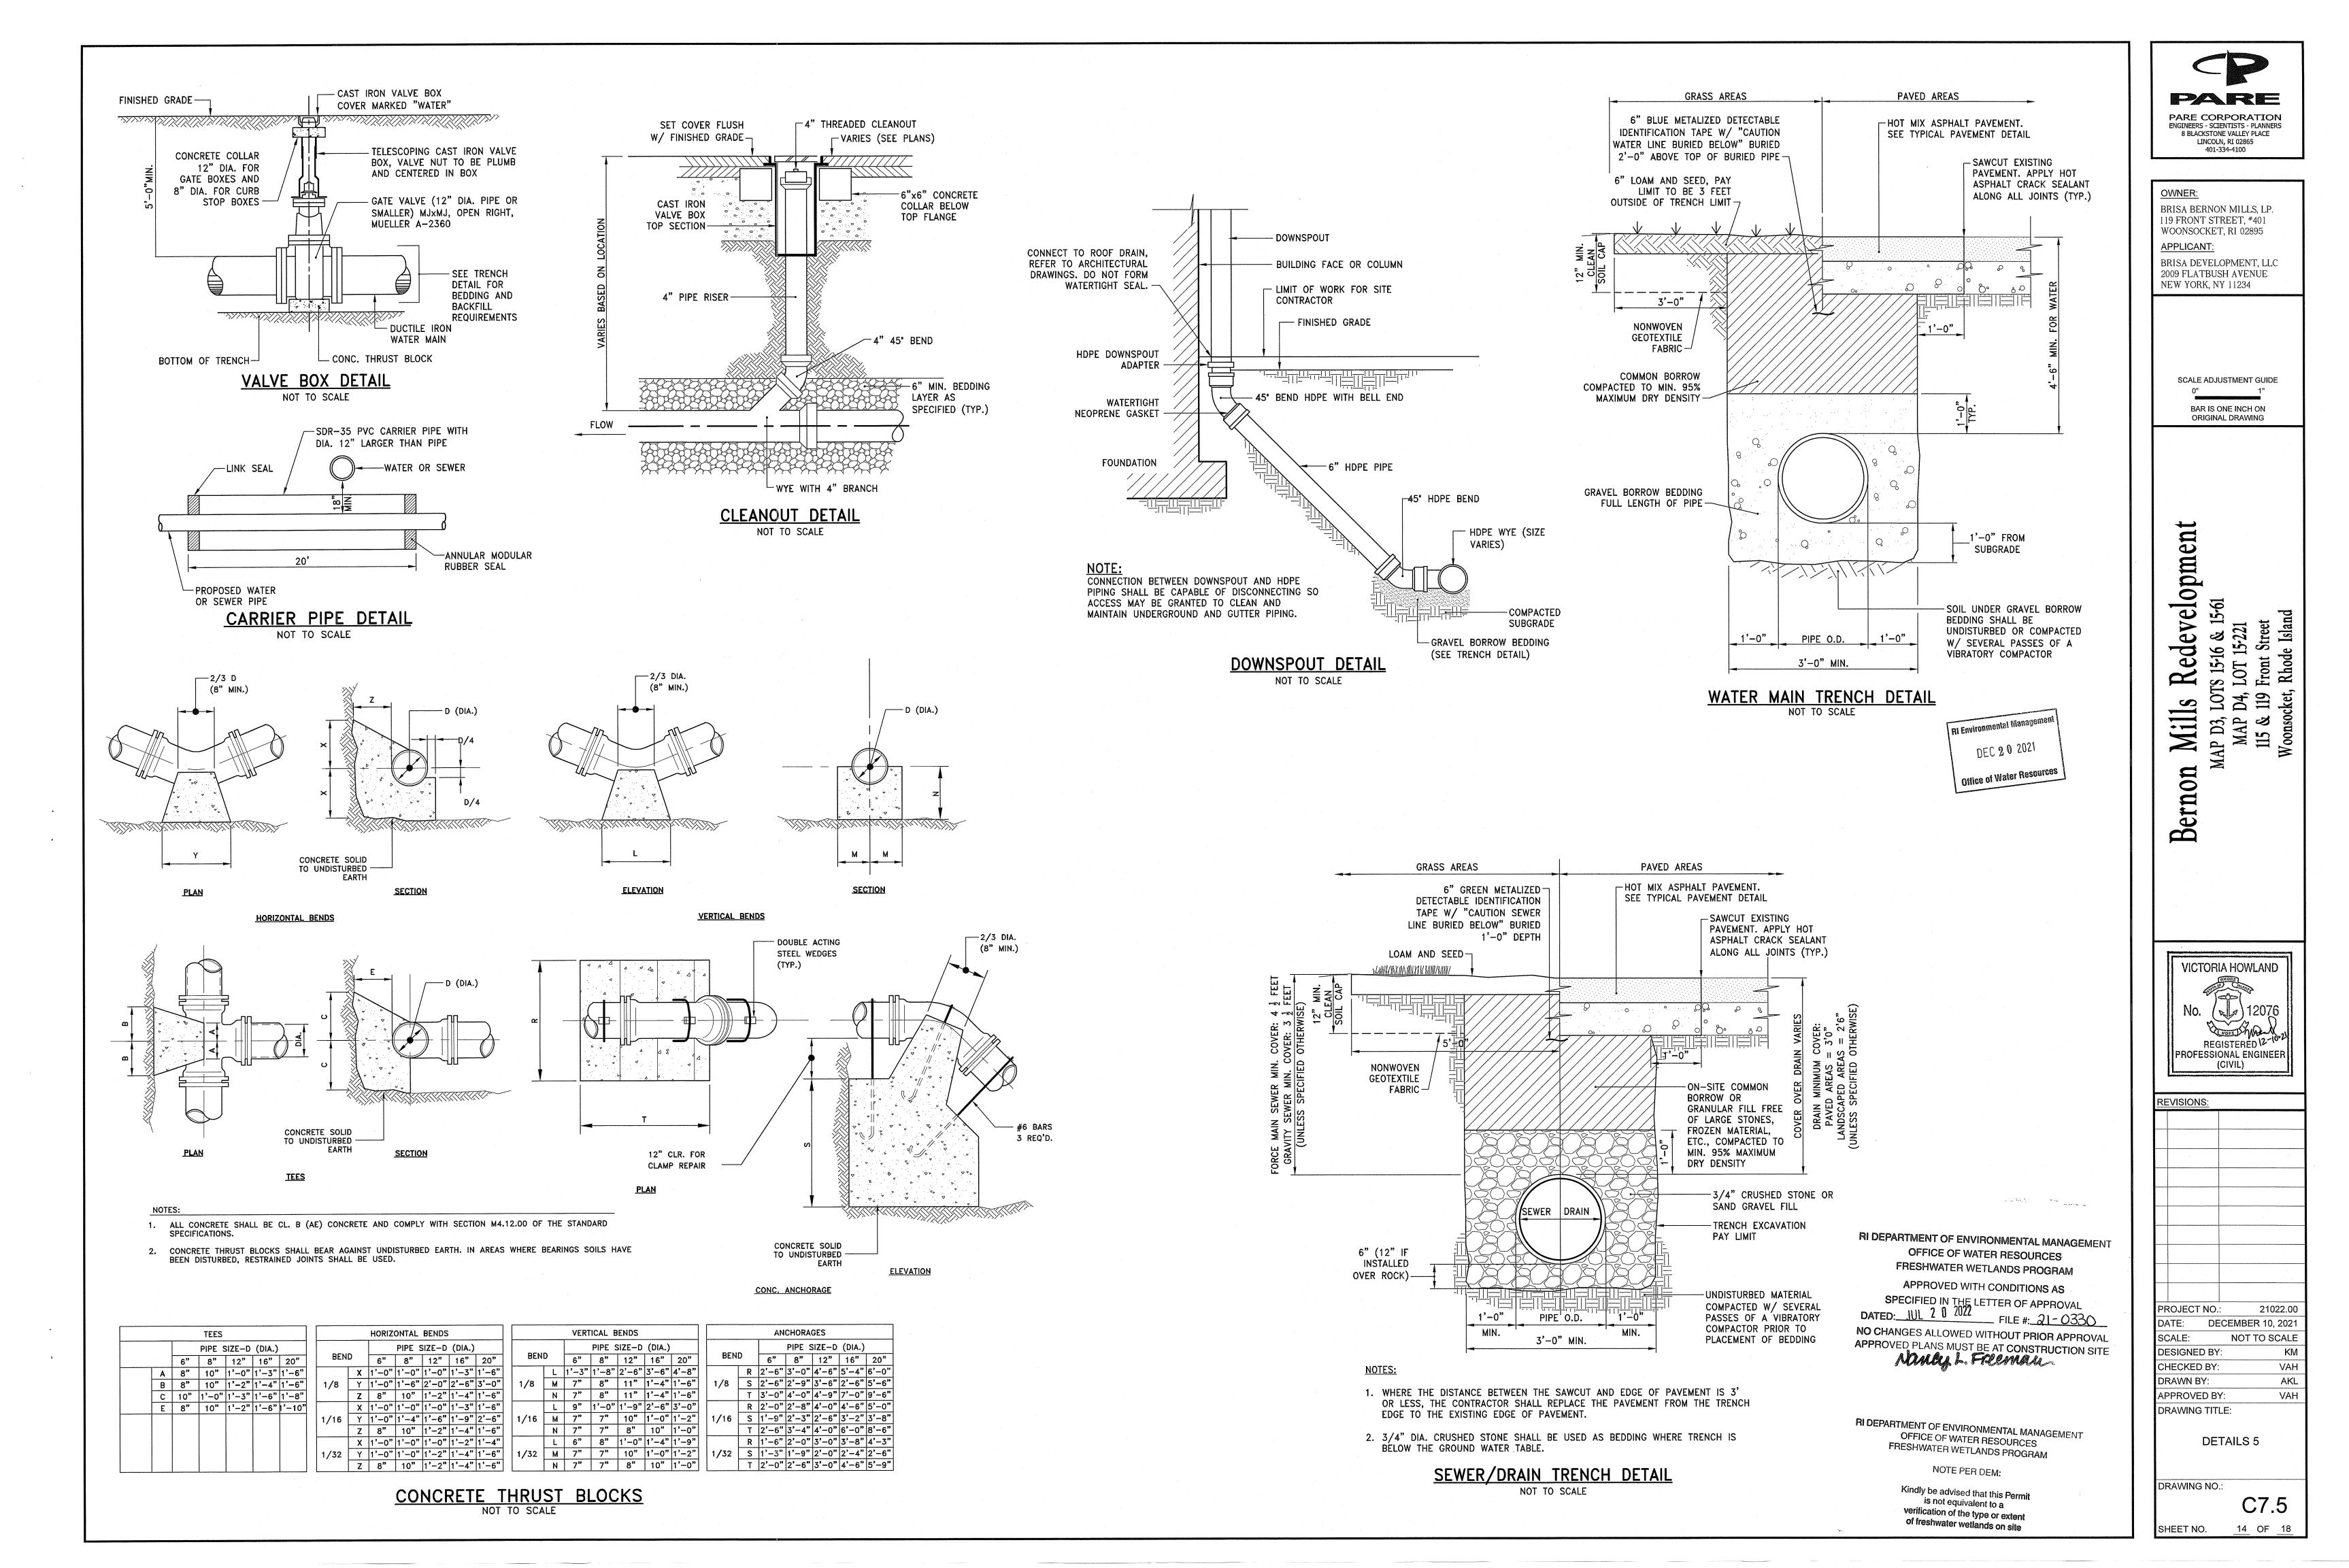

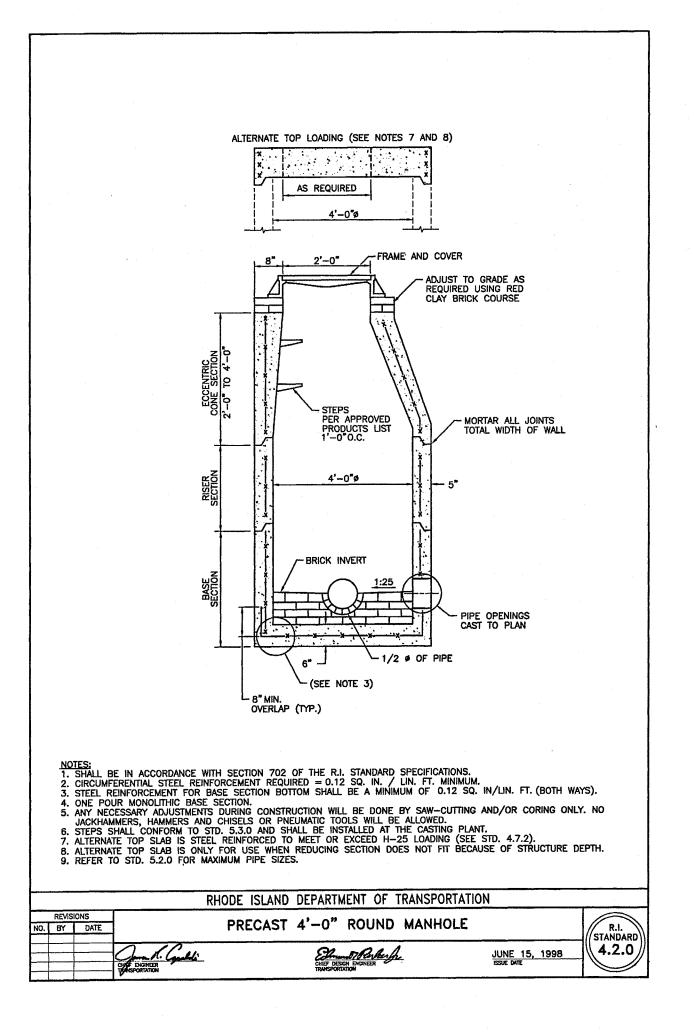

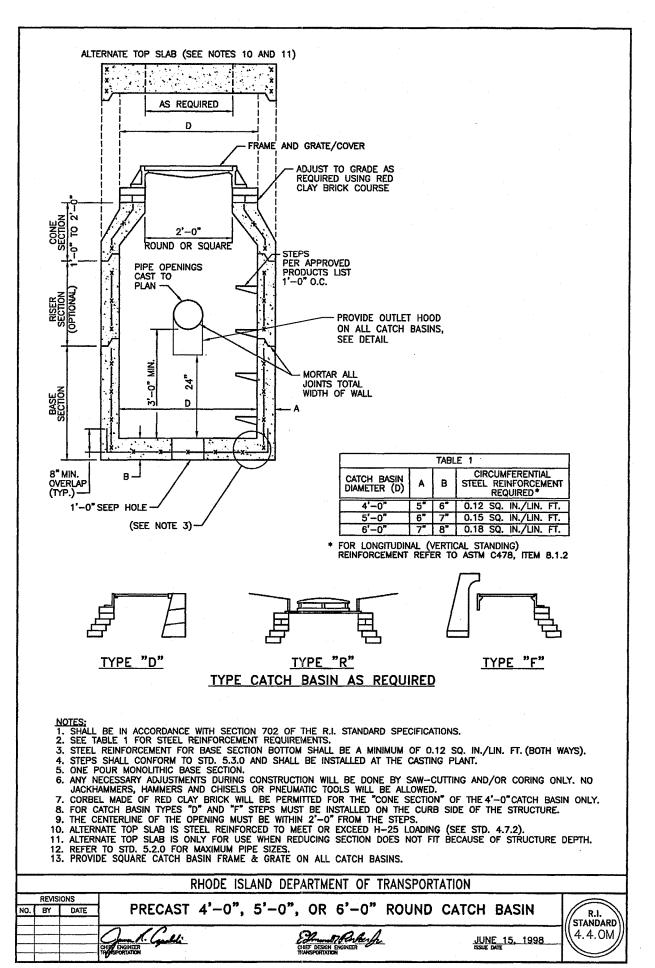

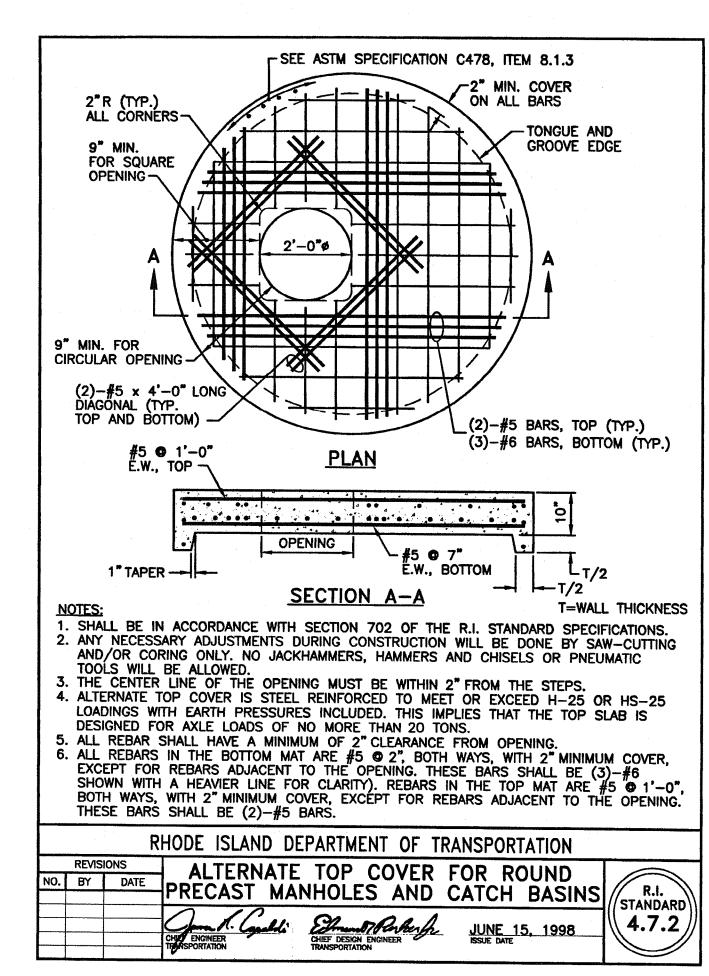

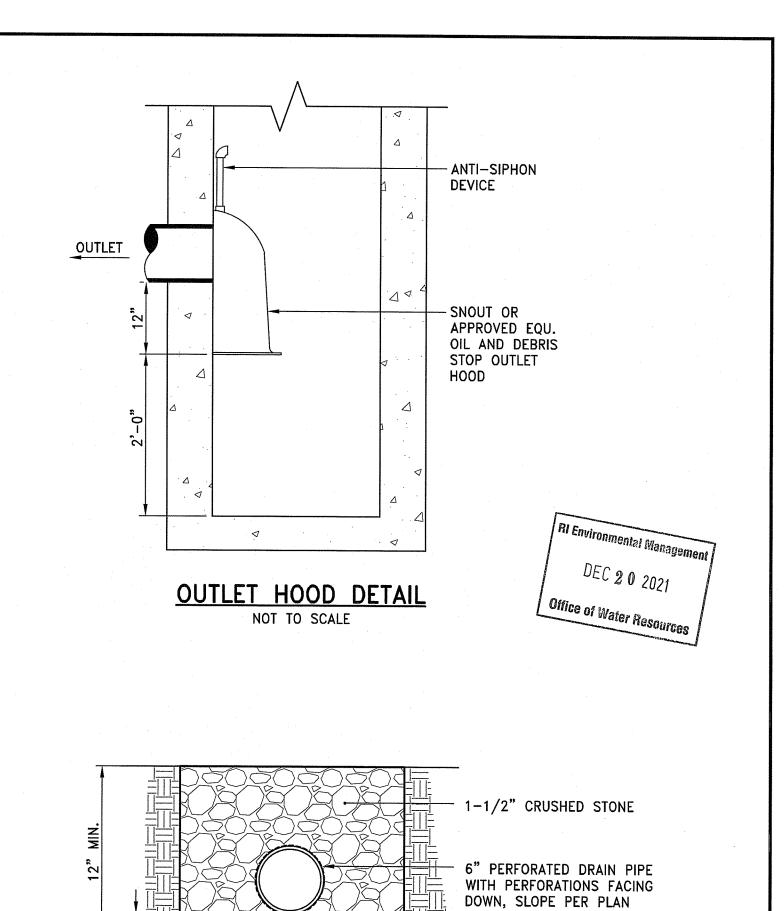

SUBGRADE

of freshwater wetlands on site

PARE PARE CORPORATION

ENGINEERS - SCIENTISTS - PLANNERS

8 BLACKSTONE VALLEY PLACE

LINCOLN, RI 02865

401-334-4100

BRISA BERNON MILLS, LP. 119 FRONT STREET, #401

BRISA DEVELOPMENT, LLC

SCALE ADJUSTMENT GUIDE

BAR IS ONE INCH ON

ORIGINAL DRAWING

S 15-16 LOT 15-

D4, 119

21022.00

VAH

AKL

C7.6

DRAWING NO.:

SHEET NO.

P D3, MAP 115 &

AP

ledevelopment

Mill


2009 FLATBUSH AVENUE NEW YORK, NY 11234

WOONSOCKET, RI 02895

OWNER:



18" MIN.

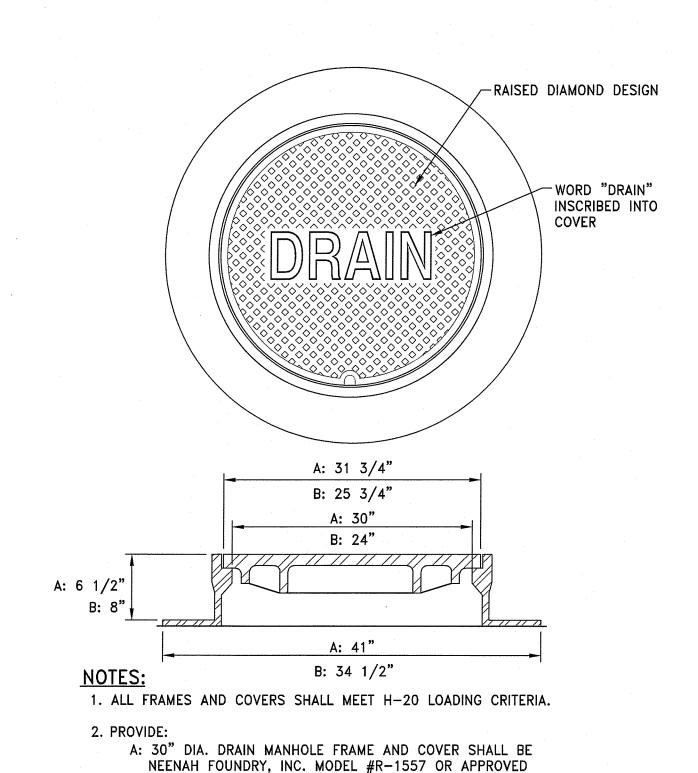

B: 24" DIA. DRAIN MANHOLE FRAME AND COVER SHALL BE

3. ALL DRAIN MANHOLES SHALL HAVE 24" DIA. DRAIN MANHOLE

NEENAH FOUNDRY, INC. MODEL #R-1556 OR APPROVED


DRAIN MANHOLE FRAME & COVER


NOT TO SCALE

EQUIVALENT.


EQUIVALENT.


COVER UNLESS NOTED OTHERWISE.

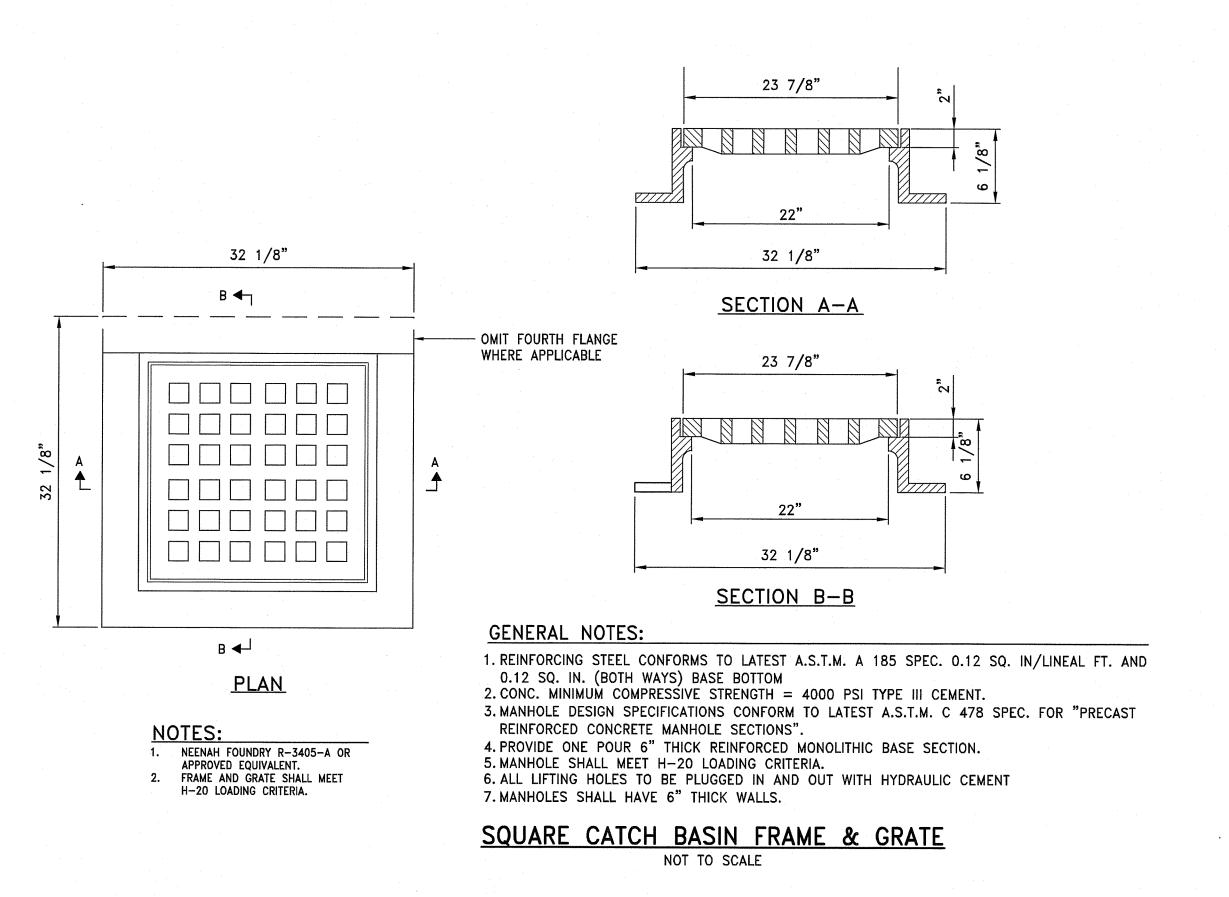

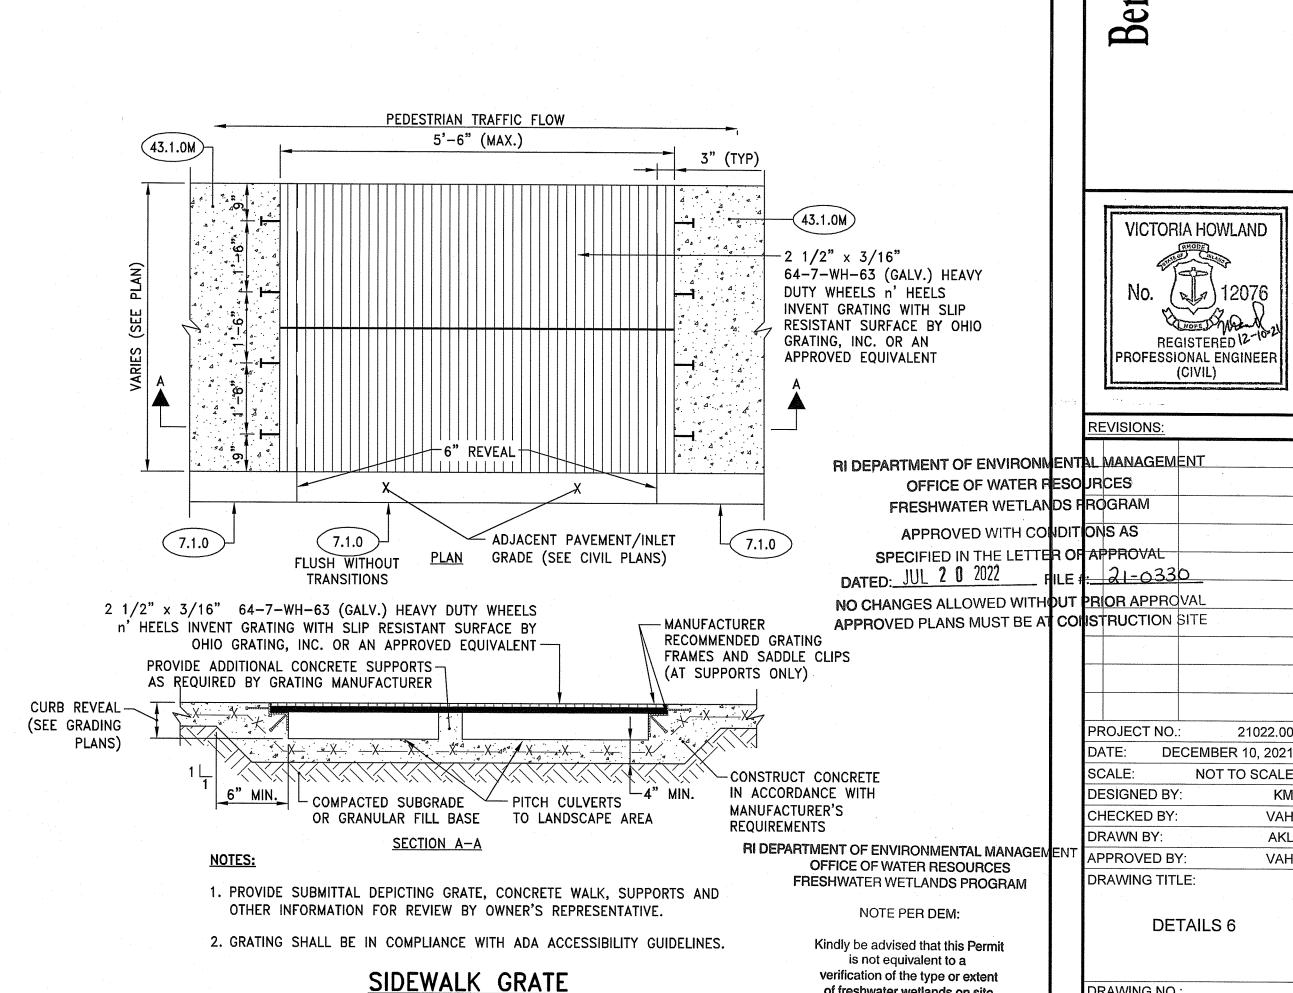

NOT TO SCALE

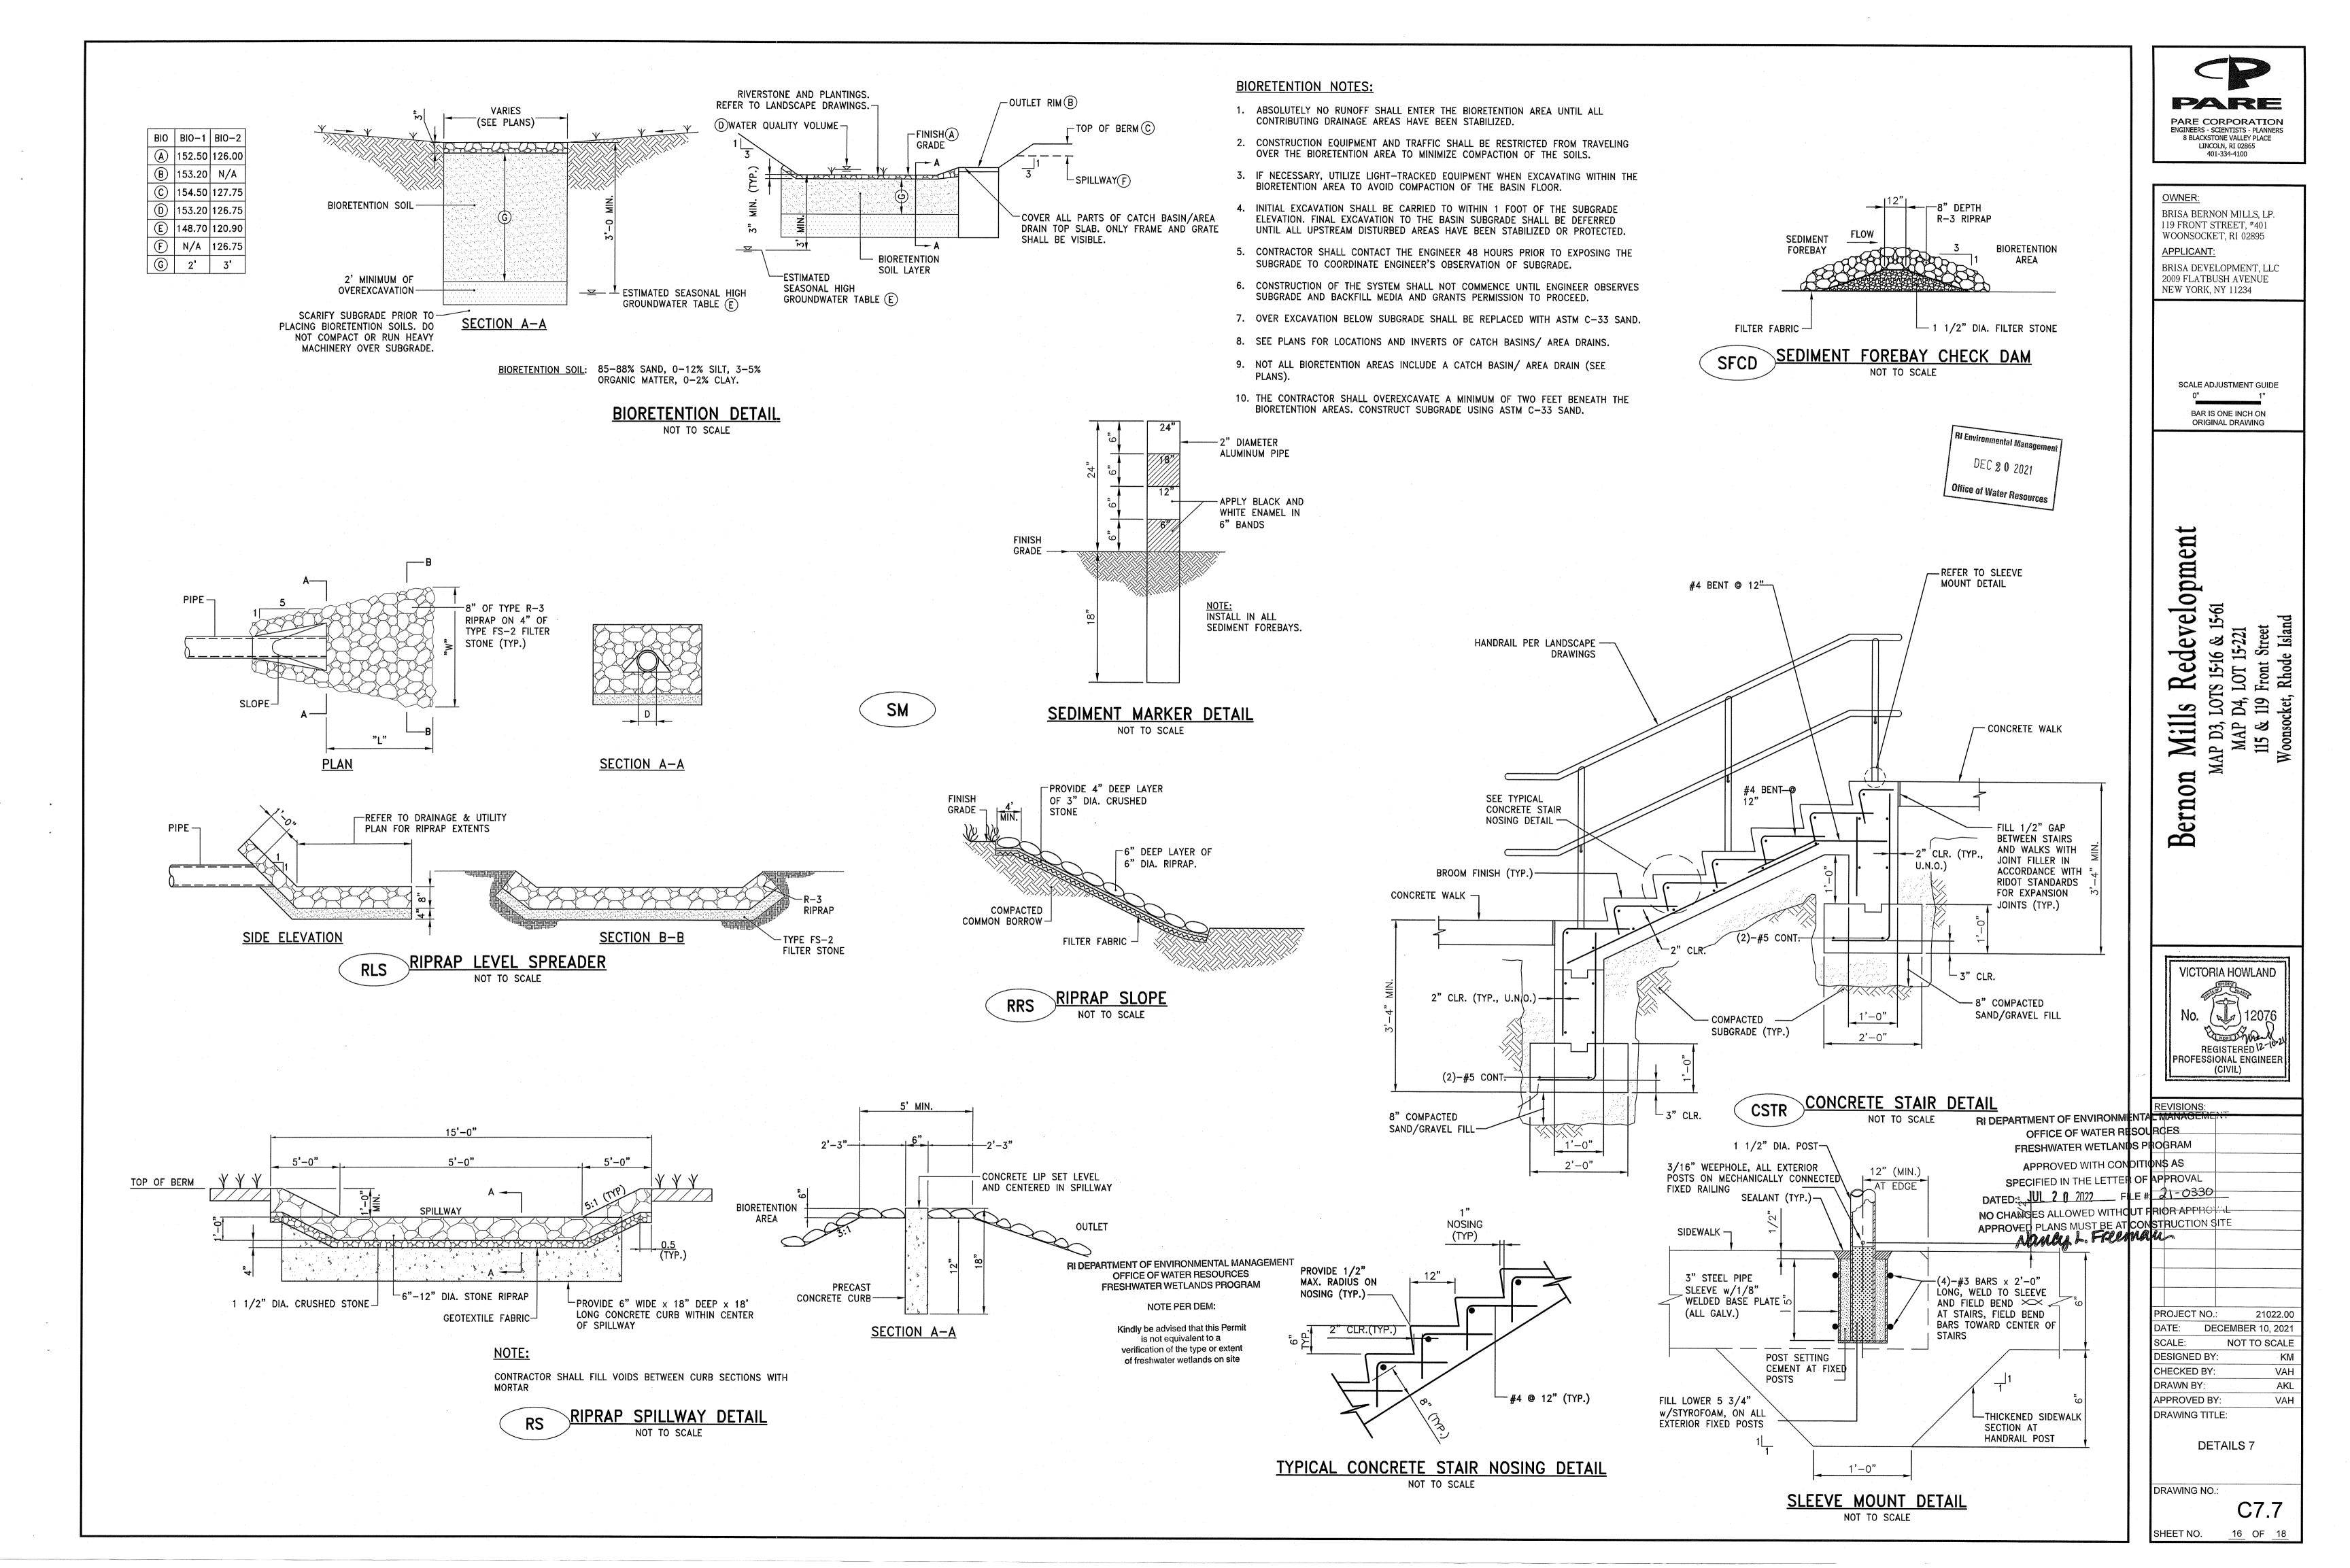

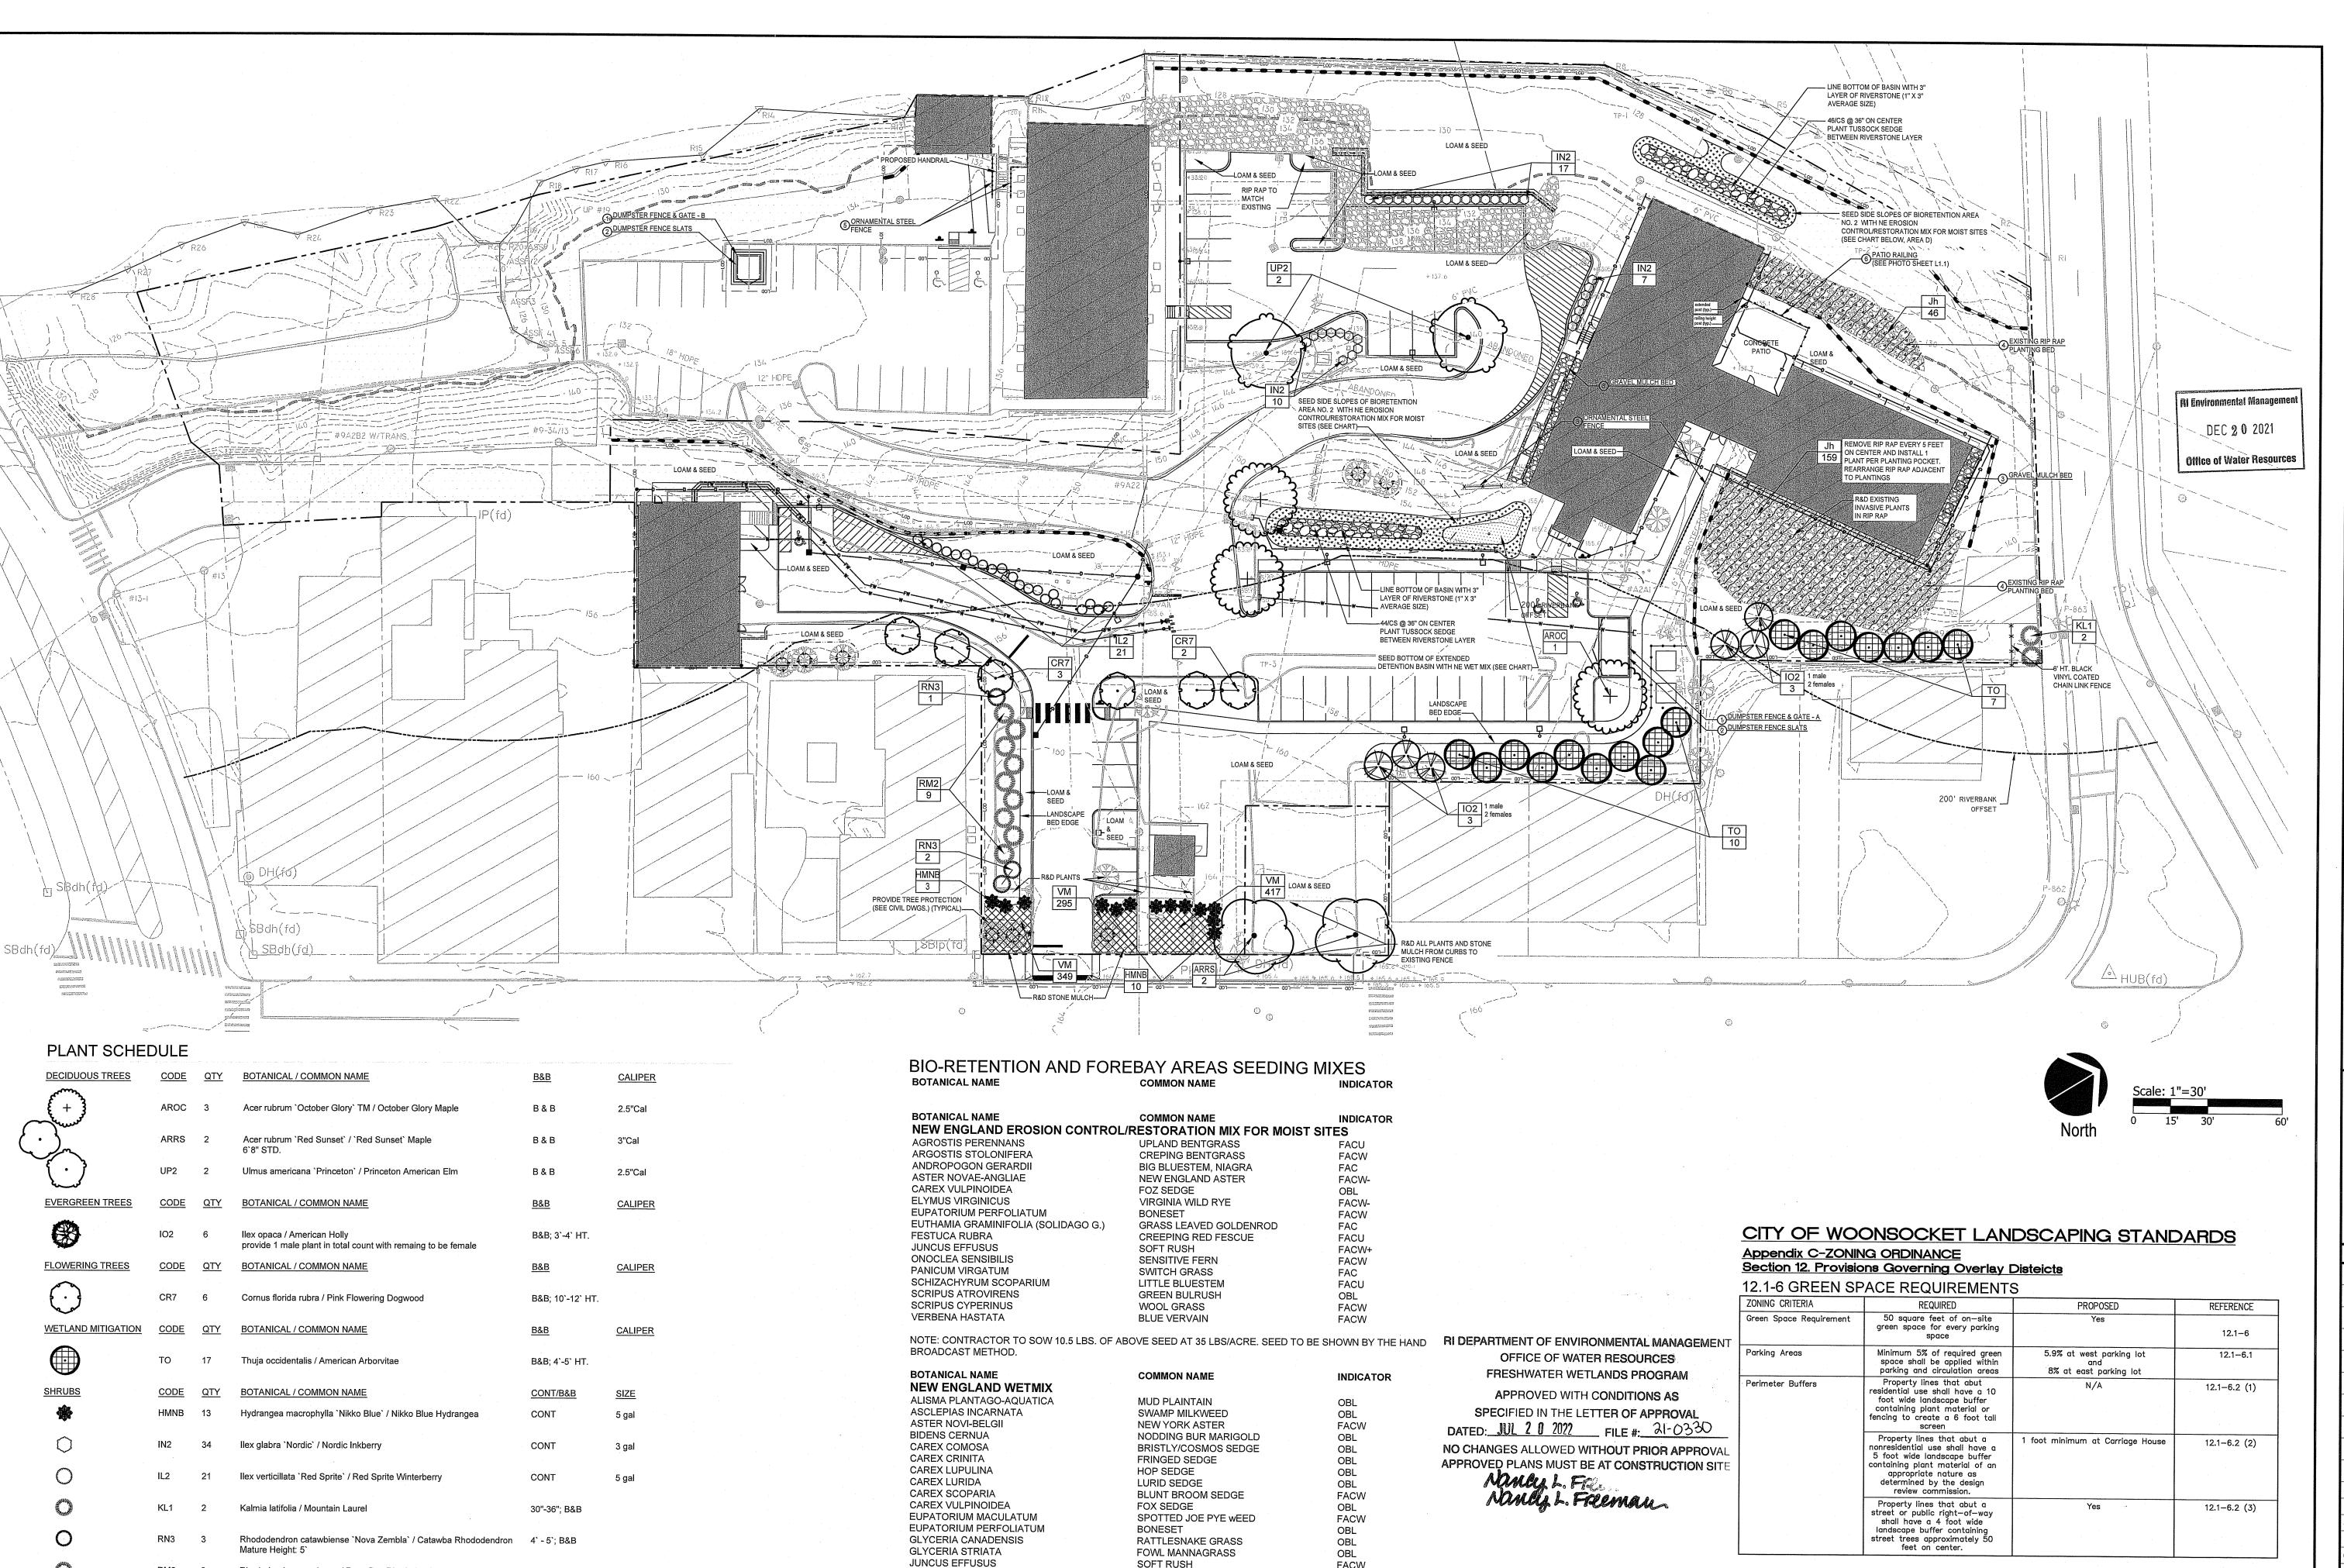

SOFT RUSH

NOTE: CONTRACTOR TO SOW 12.6 LBS. OF ABOVE SEED AT 18 LBS/ACRE. SEED TO BE SHOWN BY THE HAND

BIO-RETENTION BASIN - PLANT SCHEDULE

BOTANICAL NAME

CARIX STRICTA

SENSITIVE FERN

SQUARE STEMMED MONKEY FLOWER

COMMON NAME

TUSSOCK SEDGE

MIMULUS RINGENS

ONOCLEA SENSIBILIS

BROADCAST METHOD.

SYMBOL

CS

Rhododendron maximum / Rose Bay Rhododendron

BOTANICAL / COMMON NAME

1,061 Vinca minor / Common Periwinkle

Juniperus horizontalis / Creeping Juniper

GROUND COVERS

CODE

<u>QTY</u>

B & B

CONT.

CONT/FLAT

5` - 6` HT.

<u>SPACING</u>

60" o.c.

12" o.c.

FACW

FACW

SPACING

36" ON CENTER

RI DEPARTMENT OF ENVIRONMENTAL MANAGEMENT

OFFICE OF WATER RESOURCES

FRESHWATER WETLANDS PROGRAM

NOTE PER DEM:

Kindly be advised that this Permit

is not equivalent to a

verification of the type or extent

of freshwater wetlands on site

OBL

1 GALLON




Diane C. Soule & Associates, ASLA Landscape Architecture 422 Farnum Pike Smithfield, Rhode Island 02917 www.dianesouleandassociates.com 401.231.0736 email: diane@dcsa.ws

SCALE ADJUSTMENT GUIDE

BAR IS ONE INCH ON ORIGINAL DRAWING

edevelopment Mill 0 Ber

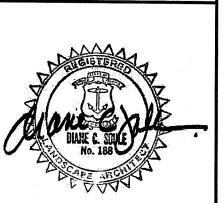

REVISIONS: PROJECT NO.: 21022.00 DATE: DECEMBER 10, 2021 SCALE: 1" = 30' **DESIGNED BY:** DCS CHECKED BY:

DCS DRAWN BY: DCS DCS APPROVED BY:

Landscape Plan


DRAWING NO .:

SHEET NO.

DRAWING TITLE:

LOCATION OF EXISTING UTILITIES SHOWN, ARE FROM GATE LOCATION AND EXISTING DOCUMENTATION AND MAY NOT BE ACCURATE. EXACT LOCATION TO BE DONE BY THE APPROPRIATE UTILITY COMPANY OR MUNICIPALITY PRIOR TO ANY EXCAVATION CALL DIGSAFE AT: 1-888-DIG-SAFE 1-888-344-7233

PROTECT YOURSELF, GIVE THREE WORKING DAYS NOTICE

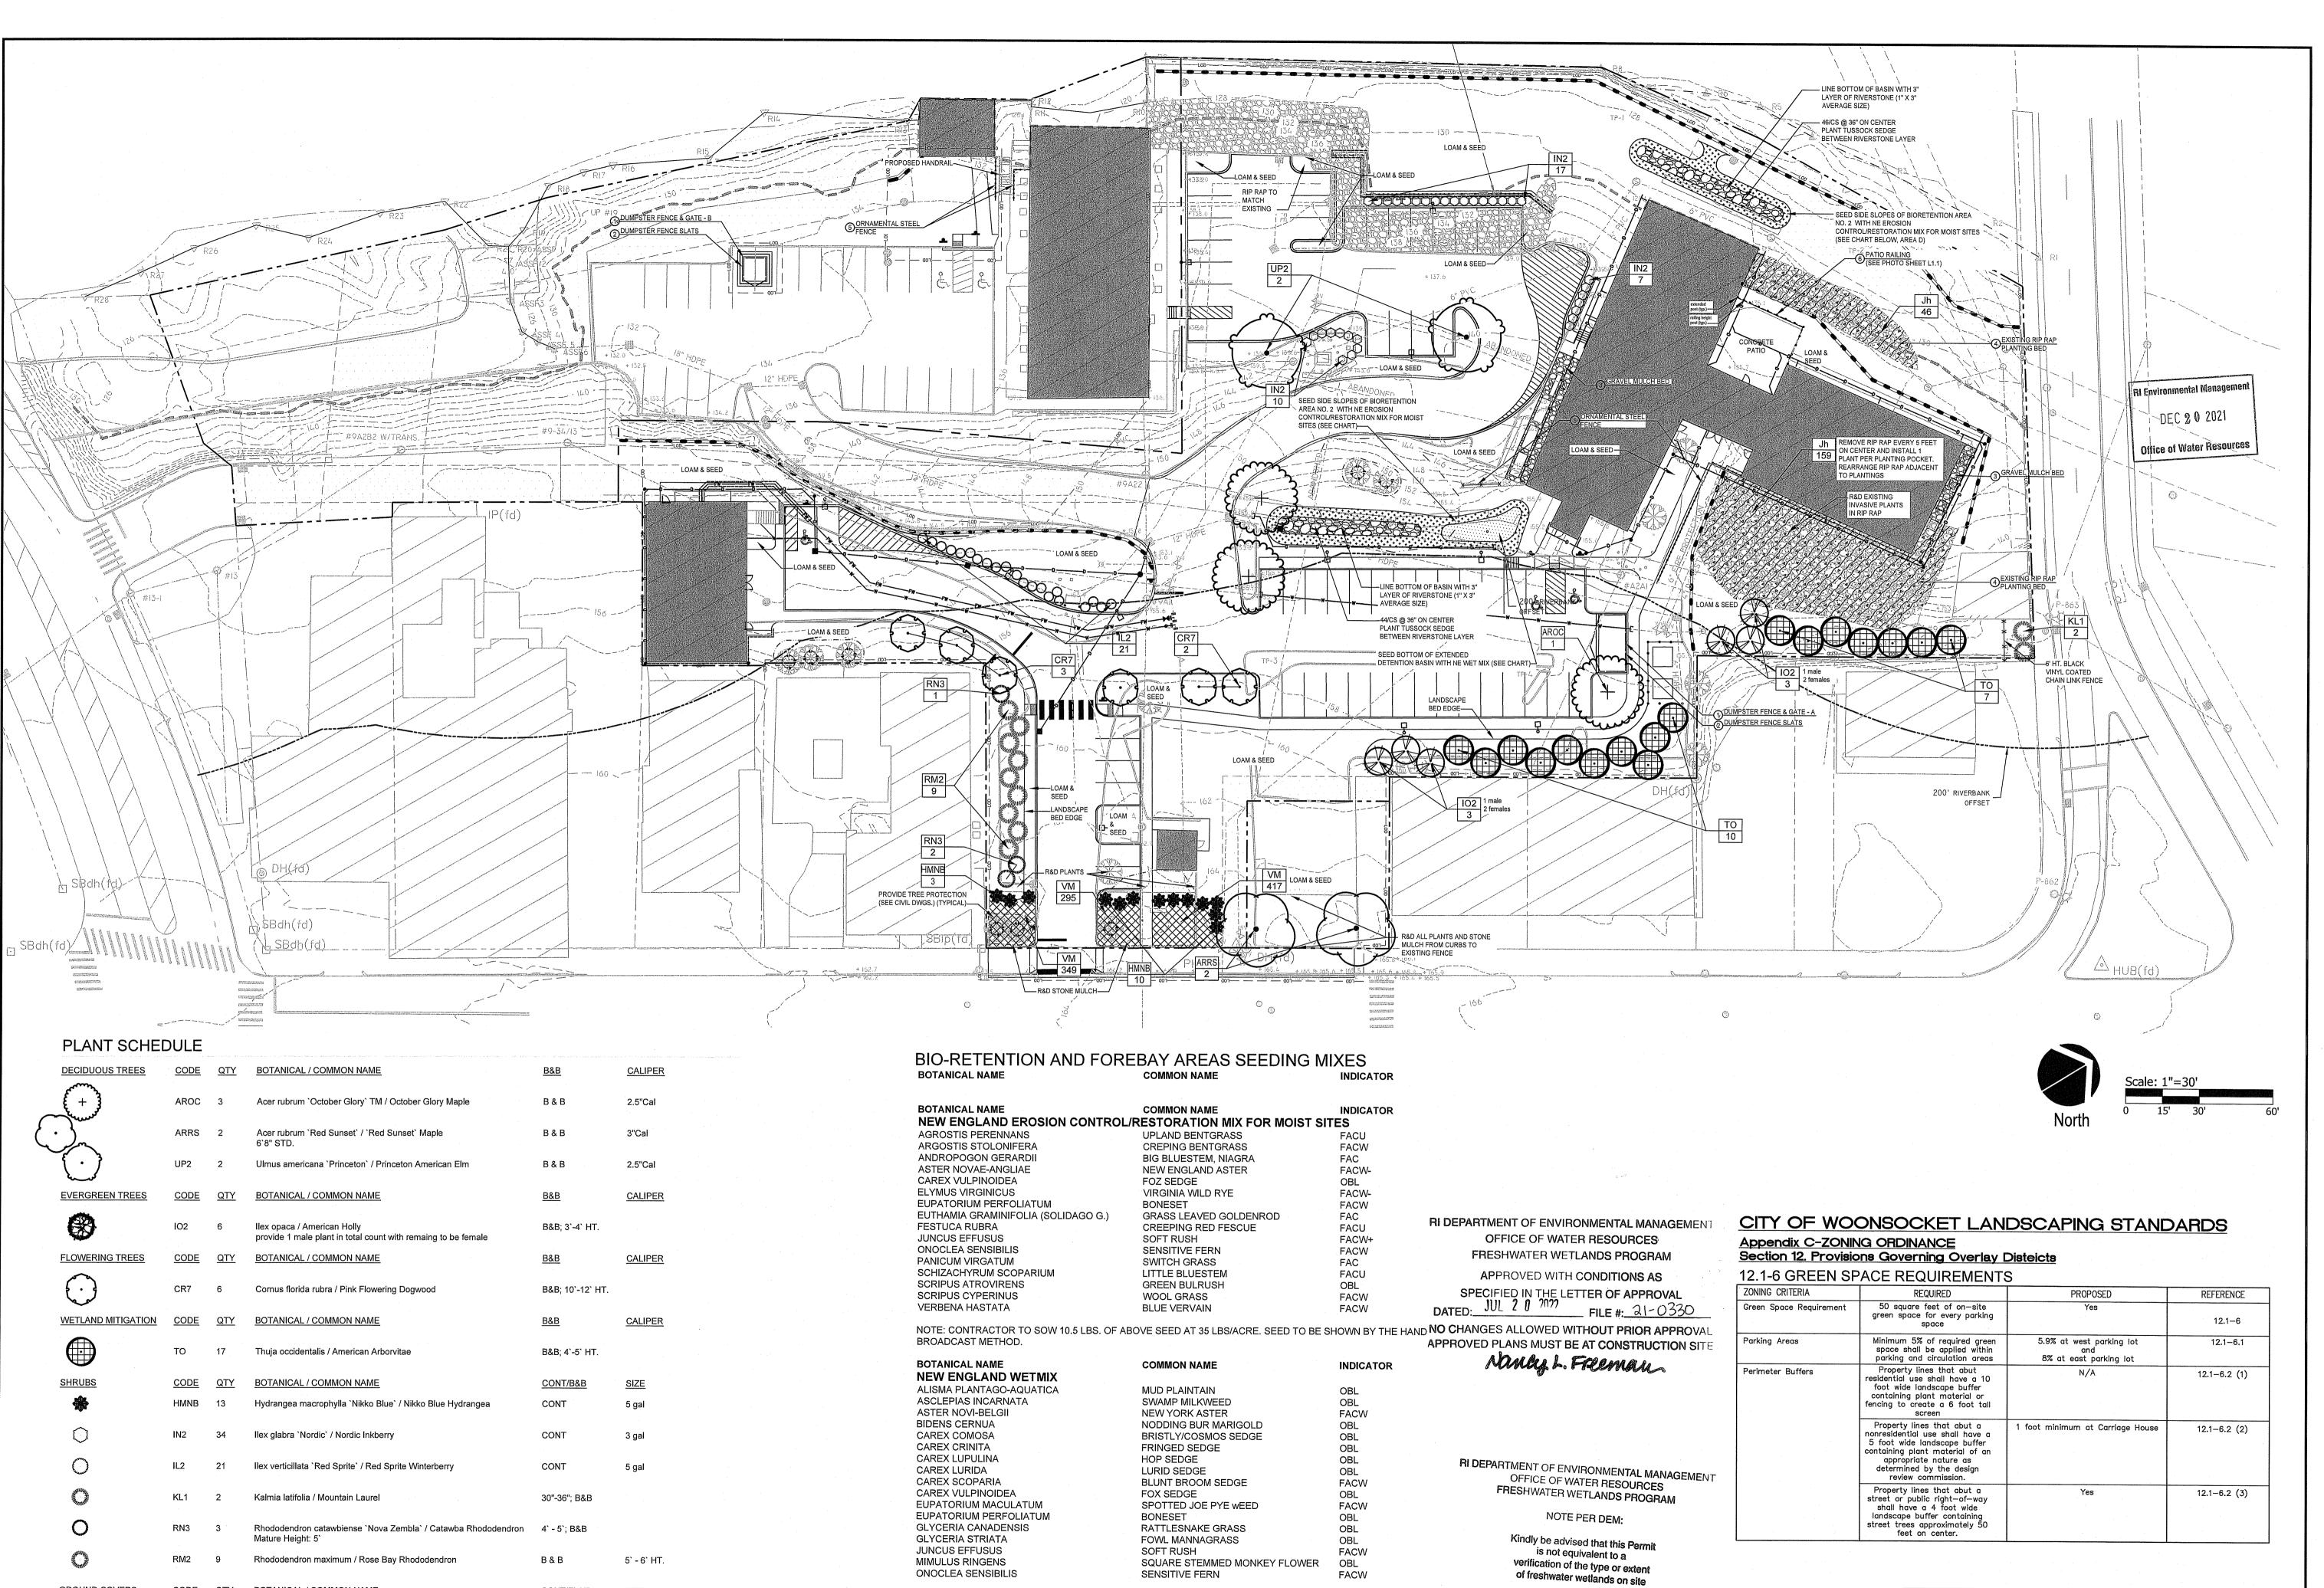

NOTE: CONTRACTOR TO SOW 12.6 LBS. OF ABOVE SEED AT 18 LBS/ACRE. SEED TO BE SHOWN BY THE HAND

COMMON NAME

TUSSOCK SEDGE

SIZE

1 GALLON

SPACING

36" ON CENTER

BIO-RETENTION BASIN - PLANT SCHEDULE

BOTANICAL NAME

CARIX STRICTA

BROADCAST METHOD.

SYMBOL

CS

QTY.

90

BOTANICAL / COMMON NAME

1,061 Vinca minor / Common Periwinkle

Juniperus horizontalis / Creeping Juniper

CONT/FLAT

CONT.

<u>SPACING</u>

60" o.c.

12" o.c.

GROUND COVERS

CODE

PARE CORPORATION ENGINEERS - SCIENTISTS - PLANNERS 8 BLACKSTONE VALLEY PLACE LINCOLN, RI 02865 401-334-4100

Diane C. Soule & Associates, ASL Landscape Architecture 422 Farnum Pike Smithfield, Rhode Island 02917 www.dianesouleandassociates.com

SCALE ADJUSTMENT GUIDE

BAR IS ONE INCH ON ORIGINAL DRAWING

Redevelopmen on et ğ



REVISIONS: PROJECT NO.: 21022.00 DATE: DECEMBER 10, 2021 SCALE: 1" = 30' **DESIGNED BY:** DCS DCS CHECKED BY: DCS DRAWN BY:

APPROVED BY: DRAWING TITLE:

Landscape Plan

DCS

DRAWING NO.:

SHEET NO.

LOCATION OF EXISTING UTILITIES SHOWN, ARE FROM GATE LOCATION AND EXISTING DOCUMENTATION AND MAY NOT BE ACCURATE. EXACT LOCATION TO BE DONE BY THE APPROPRIATE UTILITY COMPANY OR MUNICIPALITY PRIOR TO ANY EXCAVATION CALL DIGSAFE AT: 1-888-DIG-SAFE 1-888-344-7233

WORKING DAYS NOTICE